

CHER-AE HEIGHTS INDIAN COMMUNITY OF THE TRINIDAD RANCHERIA - CALIFORNIA

FUNDED BY CALIFORNIA DEPARTMENT OF WATER RESOURCES, UNDER THE SMALL COMMUNITY DROUGHT RELIEF PROGRAM

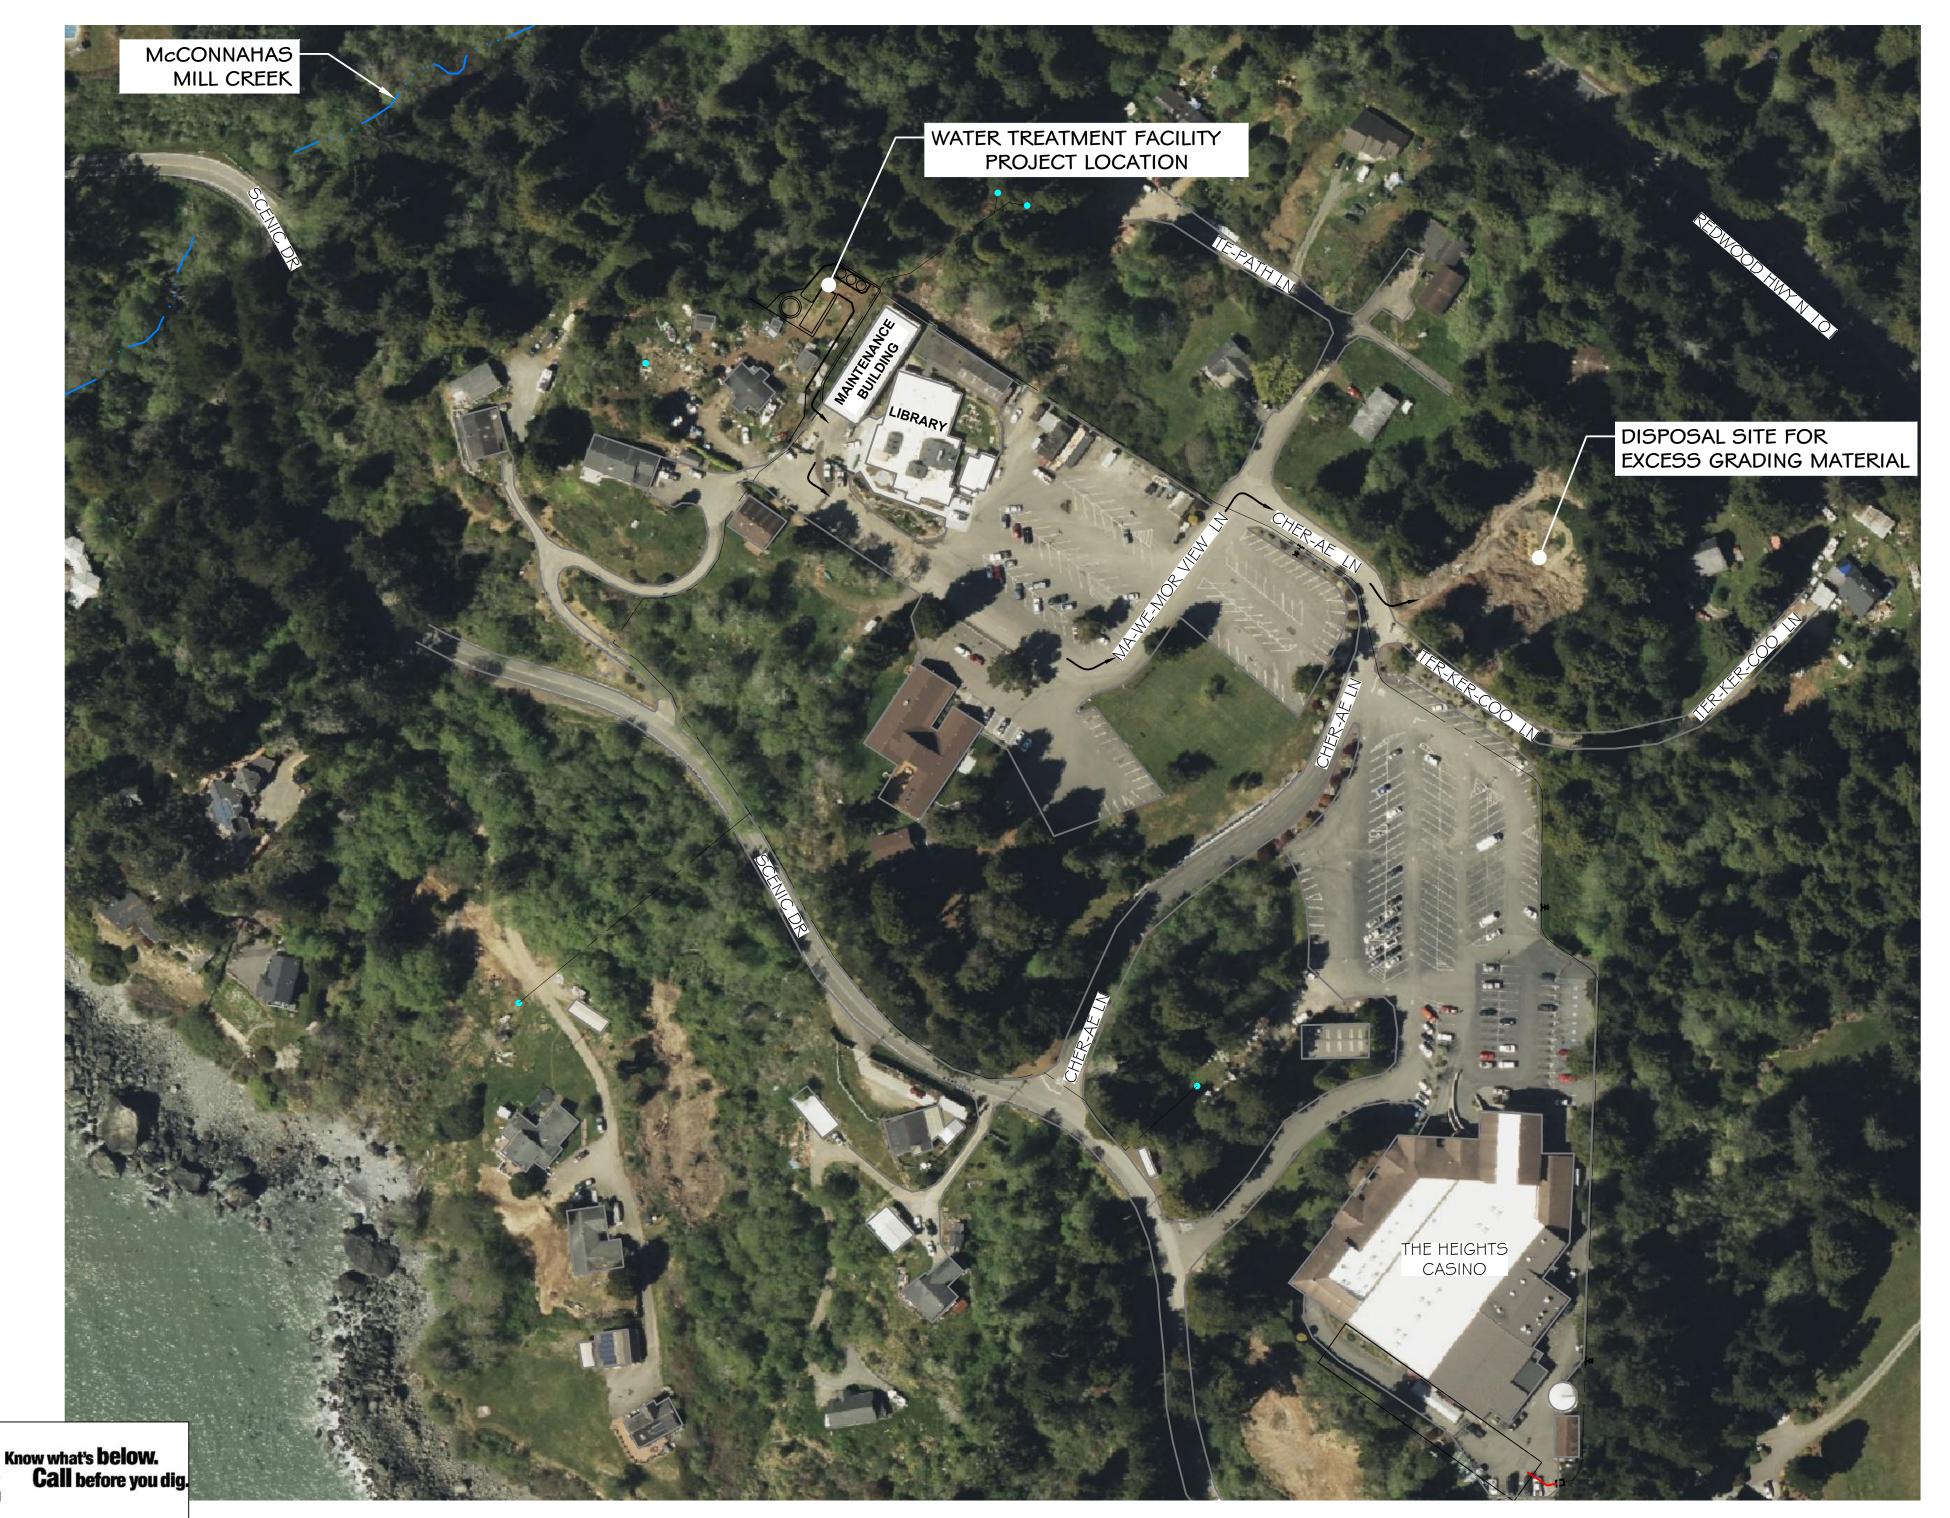


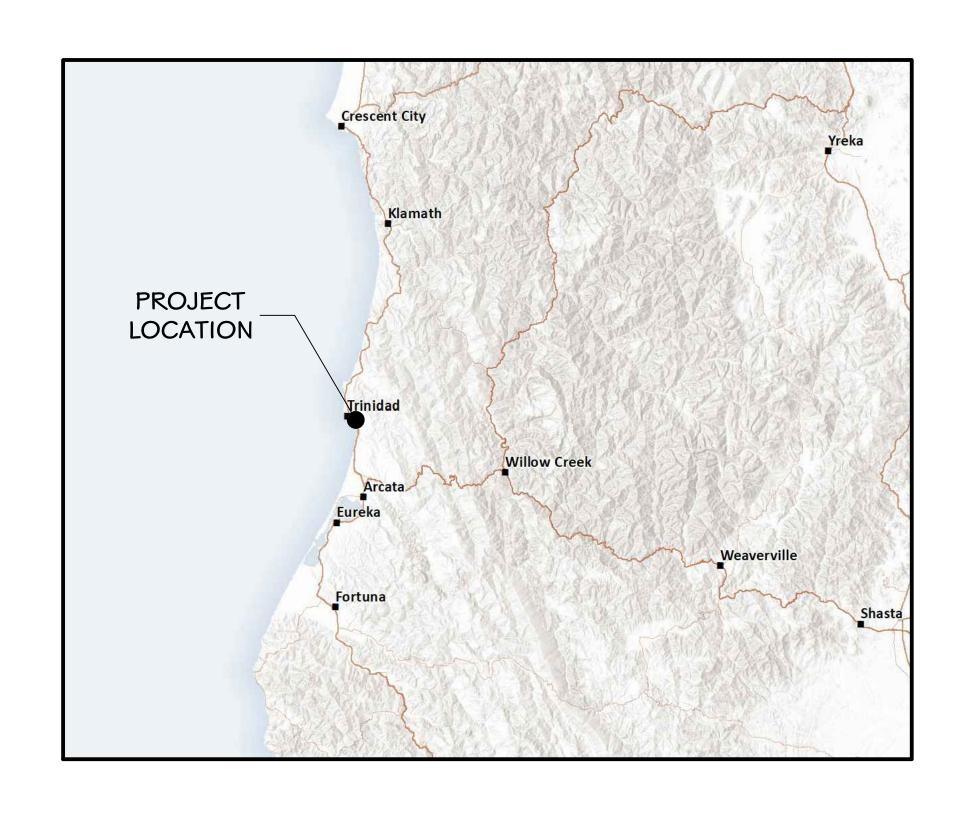

CHER-AE HEIGHTS INDIAN COMMUNITY OF THE TRINIDAD RANCHERIA POST OFFICE BOX 630 TRINIDAD, CA 95570

LESLIE SANDERS TRANSPORTATION AND LAND USE DIRECTOR PHONE: (707) 601-5754 LSANDERS@TRINIDADRANCHERIA.COM


STETSON ENGINEERS, INC. ALLAN RICHARDS, P.E. 2171 E. FRANCISCO BLVD. SUITE K SAN RAFAEL, CALIFORNIA 9490 I PHONE: (415) 457-0701 FACSIMILE: (415) 457-1638 ALLANR@STETSONENGINEERS.COM

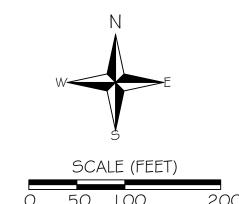

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Stetson Engineers Inc. 2171 E. Francisco Blvd., Suite San Rafael, CA. 94901 (415) 457-0701 ETSON GINEERS INC.



TRINIDAD RANCHERIA WATER TREATMENT FACILITY PROJECT PHASE I

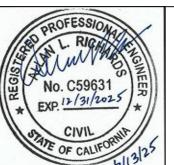ENTIRE PROJECT

<u> </u>	S
TITLE SHEET, LOCATION MAP	
TITLE SHEET; LOCATION MAP	PF

- :	DWG No.
JUNE 13, 2025	
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AS INDICATED	SHEET No.
IFCT No :	

2789-003

CHER-AE HEIGHTS INDIAN COMMUNITY OF THE TRINIDAD RANCHERIA - CALIFORNIA

FUNDED BY CALIFORNIA DEPARTMENT OF WATER RESOURCES, UNDER THE SMALL COMMUNITY DROUGHT RELIEF PROGRAM

ENTIRE PROJECT

GENERAL - ENTIRE PROJECT

SHEET	DWG.	DESCRIPTION
1.	G-1	TITLE SHEET; LOCATION MAP
2.	G-2	FULL PROJECT SHEET INDEX
3.	G-3	WTF FENCING PLAN

PART I - POTABLE WATER TANK

GENERAL - POTABLE WATER TANK

SHEET	DWG.	DESCRIPTION
4.	G-4	PART I POTABLE WATER TANK GENERAL NOTES;
		SURVEY NOTES; AND CULTURAL MONITORING

CIVIL - POTABLE WATER TANK

SHEET	DWG.	DESCRIPTION
5.	C-1	OVERVIEW TANK GRADING PLAN
6.	C-2	GRADING PLAN VIEW
7.	C-3	GRADING SECTIONS AND 2
8.	C-4	GRADING SECTIONS 3 AND 4
9.	C-5	DRAINAGE PLAN

CST TANK AND TANK FOUNDATION DETAILS

SHEET	DWG.	DESCRIPTION
10.	T- I	CST TANK DETAILS
11.	T-2	CST TANK DETAILS
12.	T-3	CST TANK DETAILS
13.	T-4	CST TANK GENERAL AND FOUNDATION NOTES
14.	T-5	CST TANK FOUNDATION DETAILS
ow what's belo	w.	

PART II - WATER TREATMENT FACILITY

GENERAL - WATER TREATMENT FACILITY

SHEET	DWG.	DESCRIPTION
15.	G-5	PART II WTF GENERAL NOTES; SURVEY NOTES; AND
		CULTURAL MONITORING
16.	G-6	PART II WTF ABBREVIATIONS; REFERENCE
17.	G-7	PROCESS SCHEMATIC
18.	G-8	SITE PLAN LAYOUT

CIVIL - WATER TREATMENT FACILITY

SHEET	DWG.	DESCRIPTION
19.	C-6	GRADING PLAN
20.	C-7	GRADING SECTIONS
21.	C-8	BUILDING FOUNDATION PLAN - PIER, FOUNDATION,
		SLAB, AND WALL
22.	C-9	WTF BUILDING FOUNDATION SECTION
23.	C-10	WTF BUILDING FOUNDATION DETAILS
24.	C-11	WTF BUILDING FOUNDATION DETAILS CONTINUED
25.	C-12	WTF BUILDING FOUNDATION - FLOOR DRAIN AND
		PIPE CHASE PLAN
26.	C-13	WTF BUILDING FOUNDATION - FLOOR DRAIN AND
		PIPE CHASE SECTIONS
27.	C-14	WTF BUILDING FOUNDATION - FLOOR DRAIN AND
		PIPE CHASE DETAILS
28.	C-15	WTF TANK FARM CONCRETE SLAB AND PIER PLAN
29.	C-16	WTF TANK FARM CONCRETE SLAB DETAILS
30.	C-17	WTF BUILDING FLOOR PLAN WITH SHEAR WALL /
		WINDOW / DOOR SCHEDULES
31.	C-18	WTF BUILDING EQUIPMENT LAYOUT
32.	C-19	WTF BUILDING PIPELINES LAYOUT
33.	C-20	WTF BUILDING EXTERIOR SIDE VIEWS

GENERAL - DISTRIBUTION PIPELINES

DESCRIPTION

PART III - PIPELINES AND WELLS

34.	C-21	WTF BUILDING ROOF PLAN	43.	G-9	GENERAL NOTES; SURVEY CONTROL NOTES;
35.	C-22	WTF BUILDING CROSS SECTIONS AND DETAILS			ABBREVIATIONS; SYMBOLS; AND REFERENCES
36.	C-23	SITE PIPING PLAN	44.	G-10	PIPELINE KEY PLAN
37.	C-24	WTF TANK FARM PLAN		CIVIII	DISTRIBUTION PIDING
38.	C-25	WTF TANK FARM PIPE CONNECTION DETAILS - STEEL		CIVIL	- DISTRIBUTION PIPING
		TUBING FRAME PIPE SUPPORT	SHEET	DWG	DESCRIPTION
39.	C-26	WTF TANK FARM PIPE CONNECTION DETAILS -	45.	C-28	RAW WATER PIPELINE FROM WELLS 3 AND 4
		RECYCLED WATER AND WASTE WATER TANKS	40.	C-20	RAW WATER TH LLINE FROM WELLS 3 AND 4
40.	C-27	WTF TANK FARM MISCELLANEOUS DETAILS	46.	C-29	TRENCH REPLACEMENT DETAILS
,	0 ,		47.	C-30	WELLS TYPICAL DETAILS
EL	ECTRICA	L - WATER TREATMENT FACILITY	48.	C-31	WELLS TYPICAL DETAILS (CONTINUED)

DWG. DESCRIPTION

DWG.

41.	E-1	BUILDING GENERAL ELECTRICAL PLAN
42.	E-2	ELECTRICAL DETAILS

CIVIL - WATER TREATMENT FACILITY (CONTINUED)

DESCRIPTION

Call before you dig.

No. DATE A.R. / R.F.

REVISION APPROVED DRAFTED: G.T. / T.Z. / R.F. CHECKED: A.R.



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TRINIDAD RANCHERIA WATER TREATMENT FACILITY PROJECT PHASE I

ENTIRE PROJECT


FULL PROJECT SHEET INDEX

JUNE 13, 2025 NOT TO SCALE

DWG No. G-2 SHEET No.

2 OF 48

PROJECT No.: 2789-003

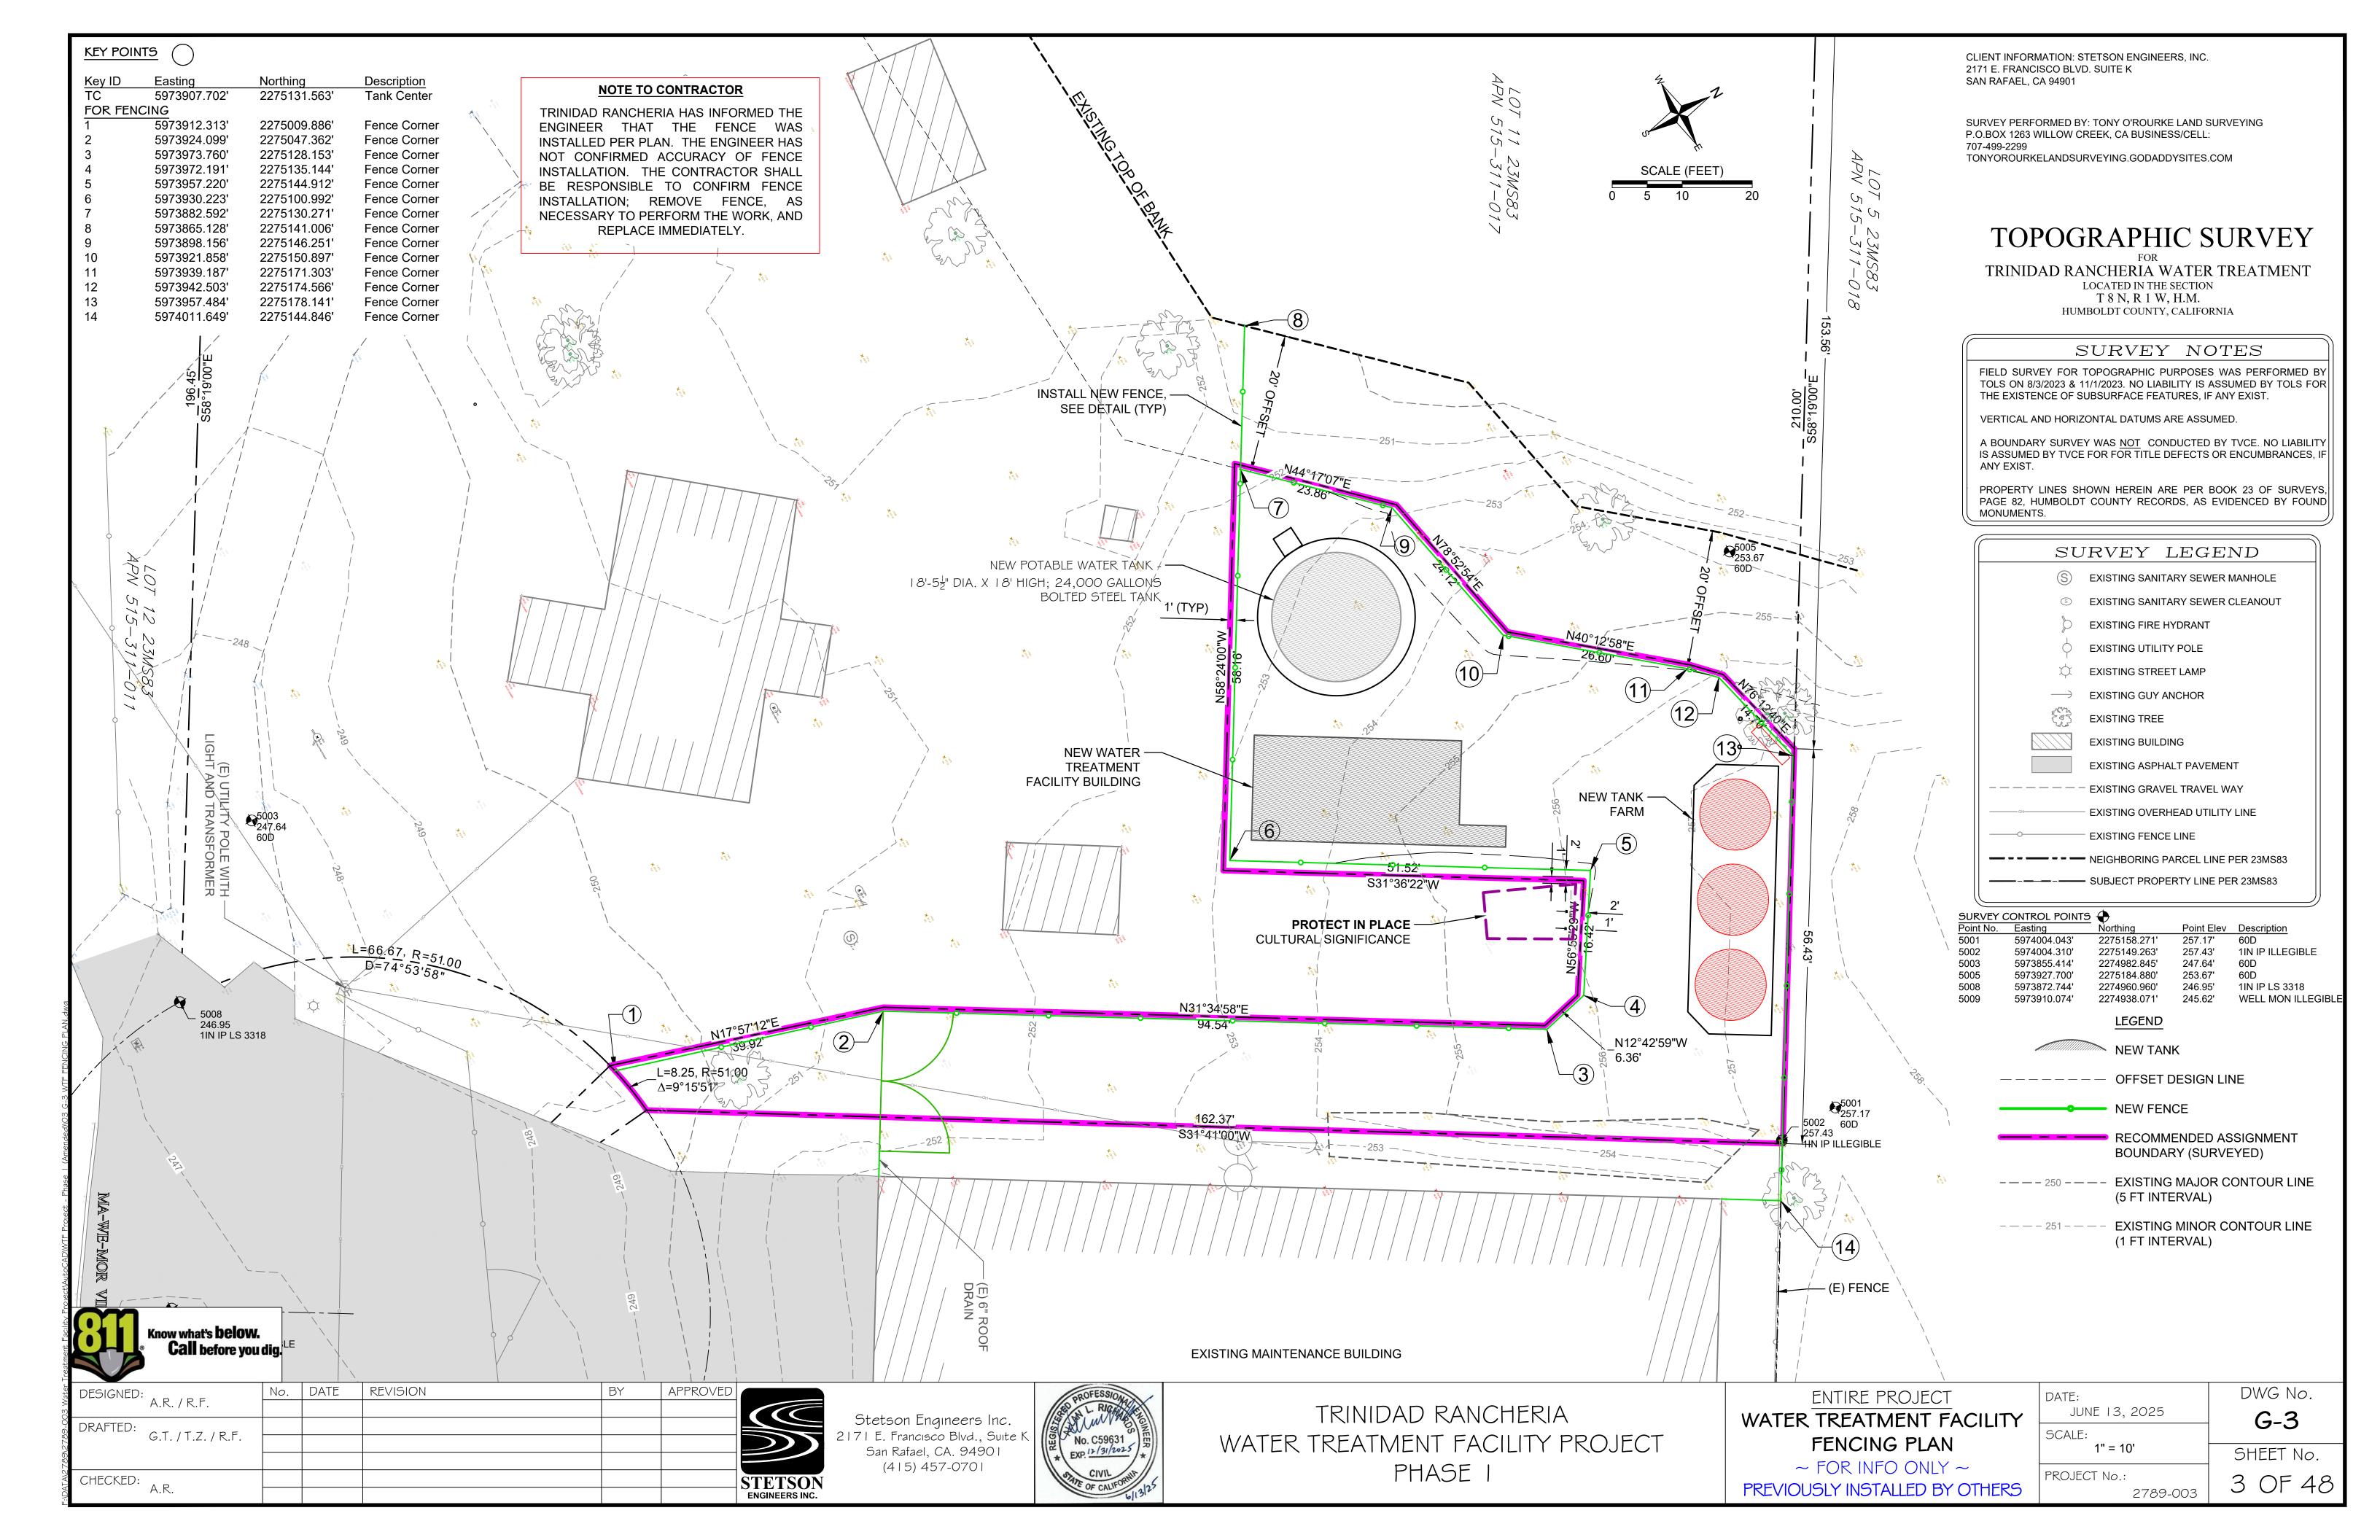

CHER-AE HEIGHTS INDIAN COMMUNITY OF THE TRINIDAD RANCHERIA - CALIFORNIA

FUNDED BY CALIFORNIA DEPARTMENT OF WATER RESOURCES, UNDER THE SMALL COMMUNITY DROUGHT RELIEF PROGRAM

PART I - POTABLE WATER TANK

GENERAL NOTES

- I. CULTURAL SIGNIFICANCE AREA SHALL BE PROTECTED AT ALL TIMES.
- 2. SITE FENCING WAS PREVIOUSLY INSTALLED. ALL WORK SHALL BE CONTAINED WITHIN THE PROJECT SITE BOUNDED BY THE SITE FENCING.
- 3. PRIOR TO START OF ANY WORK AT THE PROJECT SITE FOR PART I POTABLE WATER TANK, THE CONTRACTOR SHALL NOTIFY TRINIDAD RANCHERIA'S REPRESENTATIVE AND THE PROJECT ENGINEER, STETSON ENGINEERS INC., ATTN: ALLAN RICHARDS (415) 457-0701 / ALLANR@STETONENGINEERS.COM, TO ALLOW PROPER COORDINATION AND NOTIFICATION TO THE PROPERTY OWNERS.
- 4. THE PROJECT WORK SHALL CONSIST OF SITE PREPARATION; SITE GRADING; AND CONSTRUCTING NEW FOUNDATION FOR A 24,000 GALLONS CAPACITY POTABLE WATER TANK (WATER TANK WILL BE INSTALLED BY OTHERS), A 44 I S.F. WATER TREATMENT BUILDING, AND TANK FARM. PART I POTABLE WATER TANK FOUNDATION WORK INCLUDES INSTALLATION OF ANCHOR BOLTS.
- 5. INSTALLATION OF THE TANK SHALL BE PERFORMED BY CST INDUSTRIES, INC.
- 6. CONTRACTOR IS RESPONSIBLE FOR ASSEMBLY AND INSTALLATION OF EQUIPMENT THAT IS TO BE ATTACHED TO THE TANK THAT WAS PRE-PURCHASED FROM CST INDUSTRIES INC., WHICH MAY INCLUDE A GUARDRAIL, LIQUID LEVEL INDICATOR, LADDER, PROTECTIVE CAGES, ELECTRICAL WIRING, AND AS-NEEDED ALARMS, AND AS-NEED CONTROL AND LIGHTING PROTECTION. ALL CONNECTING PIPING, CONDUIT, WIRE, ETC., SHALL BE PURCHASED AND INSTALLED BY THE CONTRACTOR. SHOP DRAWING SUBMITTALS OF THE NEW EQUIPMENT, DEFINED BY THE LIMITS OF PIPING, CONDUIT, WIRE, ETC., PROVIDED BY CST INDUSTRIES, INC.
- 7. ALL ADDITIONAL MATERIALS REQUIRED BY THE PROJECT MANUAL AND CONTRACT DRAWINGS ARE REQUIRED FOR A FULLY OPERATION TANK SYSTEM SHALL BE PURCHASED AND INSTALLED BY THE CONTRACTOR.
- 8. CONTRACTOR SHALL COORDINATE CONSTRUCTION OF THE WATER TREATMENT FACILITY BUILDING (PART II WATER TREATMENT FACILITY) AROUND CONSTRUCTION OF THE POTABLE WATER TANK (PART I).
- 9. THE CONTRACTOR SHALL NOTIFY USA NORTH 811 AT WWW.USANORTH811.ORG, AT LEAST TWO (2) WORKING DAYS, NOT INCLUDING DAY OF NOTIFICATION, WHICHEVER IS LATER, HAS PASSED AND NOTIFY ALL UTILITY MEMBERS HAVE POSITIVELY RESPONDED TO REQUEST.
- IO. IT IS THE RESPONSIBILITY OF THE CONTRACTOR TO PERFORM UTILITY EXPLORATION TO VERIFY LOCATIONS OF EXISTING UTILITIES (INCLUDING BUT NOT LIMITED TO, GAS PIPELINES EXISTING WATER PIPELINES, ELECTRICAL, CABLE, AND TELECOMMUNICATIONS UTILITIES, BURIED OR ABOVE GROUND) BY POT-HOLING OR OTHER MEANS, AND PROTECT UTILITIES IN PLACE. CONTRACTOR SHALL REPORT TO THE ENGINEER ANY DISCREPANCIES FOUND OR ANY DETAILS NOT SHOWN ON THE DRAWINGS. EXPLORATORY EXCAVATIONS SHALL BE PERFORMED BY THE CONTRACTOR BEFORE THE

SUBMITTAL OF SHOP DRAWINGS.

- II. THIS PLAN DOES NOT AUTHORIZE ANY WORK WITHIN PUBLIC/PRIVATE RIGHT-OF-WAYS WITHOUT REQUIRED APPROVALS AND/OR PERMITS. CONTRACTOR SHALL WORK WITH TRINIDAD RANCHERIA TO OBTAIN PROPER APPROVAL(S) AND/OR PERMIT(S) AND SHALL SUBMIT TO TRINIDAD RANCHERIA AND PROJECT ENGINEER ALL APPROVAL(S)/PERMIT(S) WITH START OF WORK NOTIFICATION.
- 12. ALL WORK DETAILED HEREIN SHALL BE CONSTRUCTED IN ACCORDANCE WITH THE CONTRACT DOCUMENTS. IN THE CASE OF DISCREPANCY OR AMBIGUITY IN CONTRACT DOCUMENTS AND THIS SET OF DRAWINGS, THE CONTRACTOR IS REFERRED TO DOCUMENT 00700 GENERAL CONDITIONS ARTICLE 5.7 PRECEDENCE OF DOCUMENTS OF THE PROJECT MANUAL.
- 13. MECHANICAL AND ELECTRICAL EQUIPMENT SUPPORTS, ANCHORAGES, OPENINGS, RECESSES AND REVEALS NOT SHOWN ON THE PLANS BUT REQUIRED BY OTHER CONTRACT DRAWINGS OR APPROVED SUBMITTALS SHALL BE PROVIDED FOR PRIOR TO PLACING CONCRETE.
- 14. NO REVISIONS SHALL BE MADE TO THESE DRAWINGS WITHOUT THE APPROVAL OF THE PROJECT ENGINEER AND THE TRINIDAD RANCHERIA.
- 15. ANY DATA AND INFORMATION PROVIDED BY THE TRINIDAD RANCHERIA ARE FOR THE CONTRACTOR'S INFORMATION ONLY. ANY INTERPRETATIONS OR CONCLUSIONS DRAWN BY THE CONTRACTOR FROM THEM SHALL BE THE RESPONSIBILITY OF THE CONTRACTOR.
- 16. THE CONTRACTOR SHALL EXERCISE CARE AND SAFETY WHEN WORKING NEAR EXISTING UTILITIES ON SITE INCLUDING EXISTING WATER MAINS AND APPURTENANCES, AND ELECTRICAL UTILITIES, AND SHALL BE FULLY RESPONSIBLE FOR ANY DAMAGE, BREAKAGE, OR LEAKS CAUSED BY THE CONTRACTOR'S WORK.
- 17. THE CONTRACTOR SHALL RESTORE THE GROUND SURFACE OF EXCAVATED AREAS TO ORIGINAL GRADE AS REASONABLY POSSIBLE UNLESS OTHERWISE SHOWN OR DIRECTED.
- 18. THE CONTRACTOR SHALL TAKE PRECAUTIONARY MEASURES TO PROTECT EXISTING UTILITIES, STRUCTURES, FENCING, ETC. FROM DAMAGE. CONTRACTOR SHALL BEAR SOLE RESPONSIBILITY FOR ANY DAMAGE TO SUCH FACILITIES.
- 19. THE ENGINEER HAS, BY SEARCH OF KNOWN RECORDS, ENDEAVORED TO LOCATE AND INDICATE ON THE PLANS ALL THE UTILITIES WHICH EXIST WITHIN THE LIMITS OF THE WORK. HOWEVER, THE ACCURACY OR COMPLETENESS OF THE UTILITIES ON THE DRAWINGS IS NOT GUARANTEED.

SURVEY CONTROL NOTES

- 1. FIELD SURVEY FOR TOPOGRAPHIC PURPOSES WAS PERFORMED BY TOLS ON 8/3/2023 \$ 11/1/2023. NO LIABILITY IS ASSUMED BY TOLS FOR THE EXISTENCE OF SUBSURFACE FEATURES, IF ANY EXIST.
- 2. VERTICAL AND HORIZONTAL DATUMS ARE ASSUMED.
- 3. A BOUNDARY SURVEY WAS NOT CONDUCTED BY TVCE. NO LIABILITY IS ASSUMED BY TVCE FOR FOR TITLE DEFECTS OR ENCUMBRANCES, IF ANY EXIST.
- 4. PROPERTY LINES SHOWN HEREIN ARE PER BOOK 23 OF SURVEYS, PAGE 82, HUMBOLDT COUNTY RECORDS. AS EVIDENCED BY FOUND MONUMENTS.

CULTURAL MONITORING

- I. CULTURAL MONITORING IS REQUIRED UNDER THIS PROJECT AND CONTRACT AGREEMENT FOR ANY GROUND DISTURBING ACTIVITIES. DURING CONSTRUCTION, THE CONTRACTOR IS TO ADHERE TO THE REQUIREMENTS OF THE TRINIDAD RANCHERIA THPO AND CULTURAL MONITOR IN THE EVEN OF DISCOVERY OF SENSITIVE ITEMS AS DEFINED AND EXPLAINED HEREIN.
- 2. IT IS THE RESPONSIBILITY OF THE CONTRACTOR TO NOTIFY THE RANCHERIA SEVENTY-TWO (72) HOURS PRIOR TO CONDUCTING GROUND DISTURBANCE ACTIVITIES.
- 3. CONTRACTOR IS RESPONSIBLE FOR ALL COORDINATION WITH TRINIDAD RANCHERIA THPO TO ENSURE A TRINIDAD RANCHERIA CULTURAL MONITOR IS AVAILABLE DURING ANY GROUND DISTURBANCE ACTIVITIES.

ABBREVIATIONS AND SYMBOLS

ASBESTOS - CEMENT PIPE **APPROXIMATED** CENTER LINE CONCRETE CST CST INDUSTRIES, INC. CT CATHODIC TEST STATION CY CUBIC YARDS DUCTILE IRON DIAMETER DUCTILE IRON PIPE DRAWING DWG EXISTING ELECTRIC EXISTING GROUND ELEVATION FLANGE GALVANIZED GALLONS PER MINUTE INCHES LENGTH MAXIMUM MINIMUM MISC MISCELLANEOUS MECHANICAL JOINT MJ NOM. NOMINAL NOT TO SCALE NUMBER ON CENTER POTABLE WATER PW RADIUS REQUIRED REQ'D SQ.FT. / S.F. SQUARE FEET STAINLESS STEEL STD. STANDARD TBD TO BE DETERMINED T.R. CHER-AE HEIGHTS INDIAN COMMUNITY OF THE TRINIDAD RANCHERIA TYP TYPICAL WATER WITH WATER TREATMENT FACILITY FEET OR MINUTES INCHES OR SECONDS AND DIAMETER NUMBER PERCENT

REFERENCE

DETAIL / SECTION

DETAIL OR SECTION DRAWING

NUMERAL SHOWN INDICATES DRAWING NUMBER
ON WHICH DETAIL OR SECTION APPEARS

NUMERAL OR LETTER SHOWN INDICATES

Know what's **below.**Call before you dig.

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A A A	CHECKED:	A D						STETSON
$\Gamma: \bigvee_{\mathcal{F}}$		A.R.						ENGINEERS INC.

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TRINIDAD RANCHERIA
WATER TREATMENT FACILITY PROJECT
PHASE I

PART I - POTABLE WATER TANK
GENERAL NOTES; SURVEY
NOTES; CULTURAL MONITORING;
REFERENCE; ABBREVIATIONS
AND SYMBOLS

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JUNE 13,
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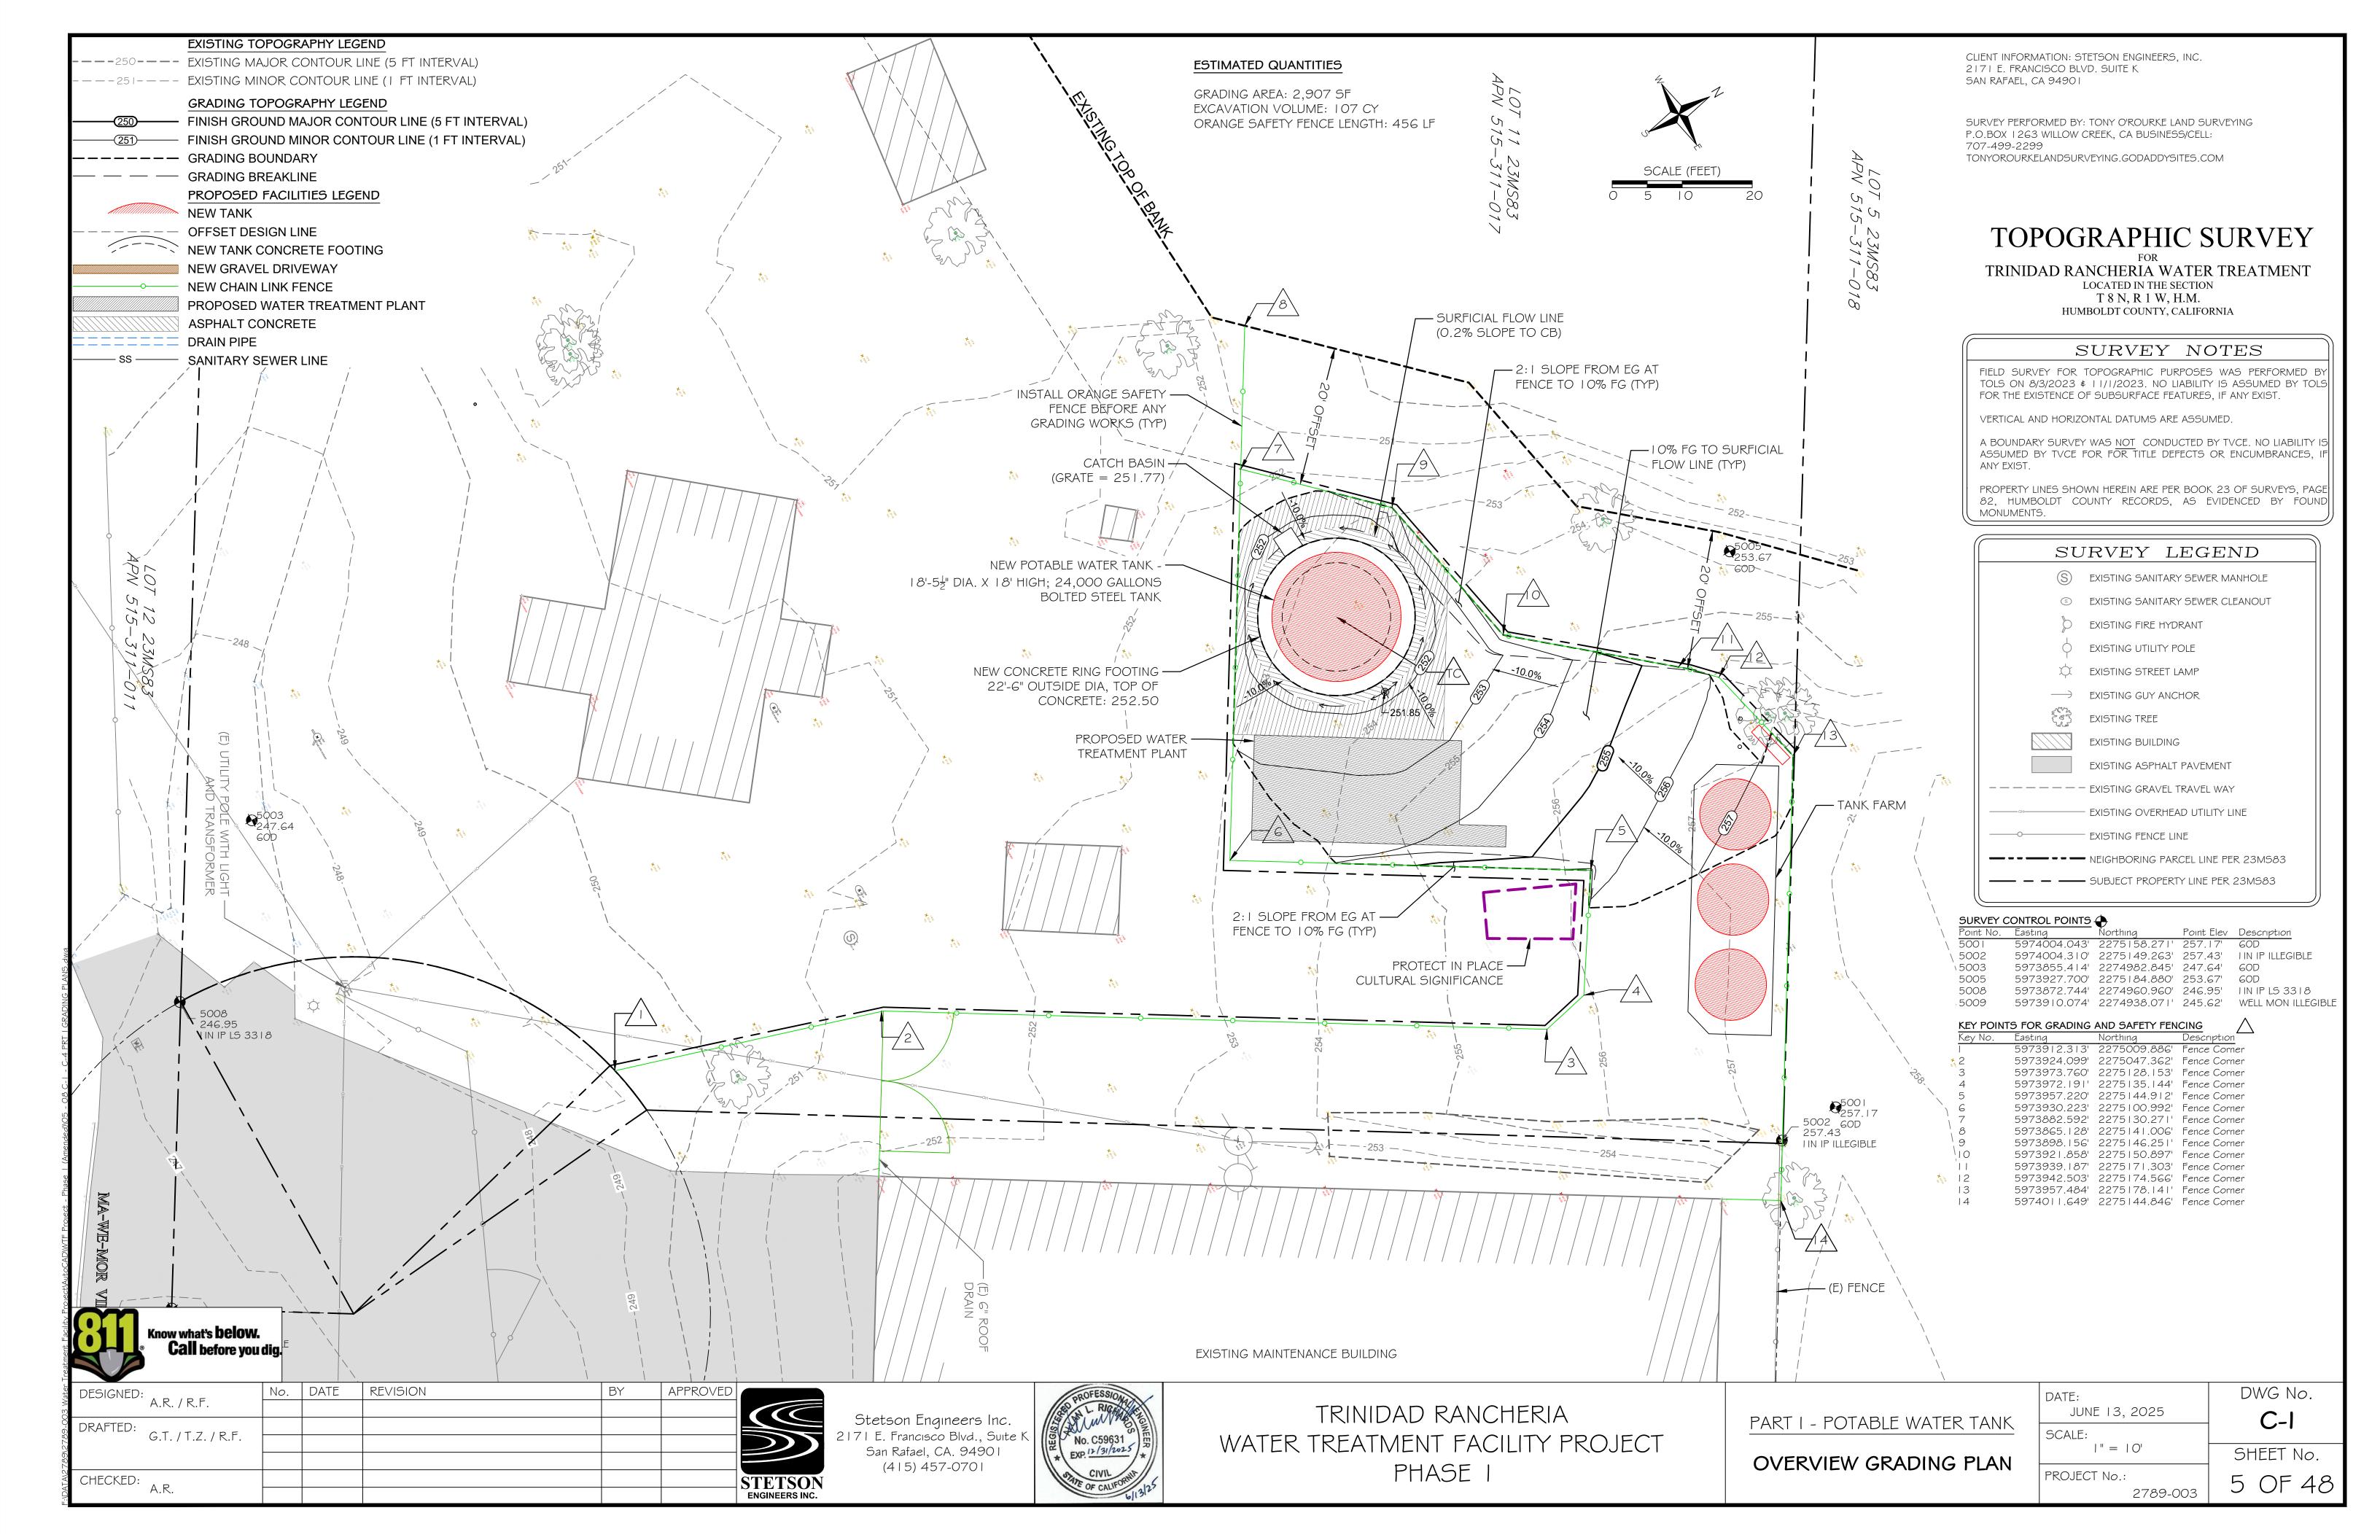
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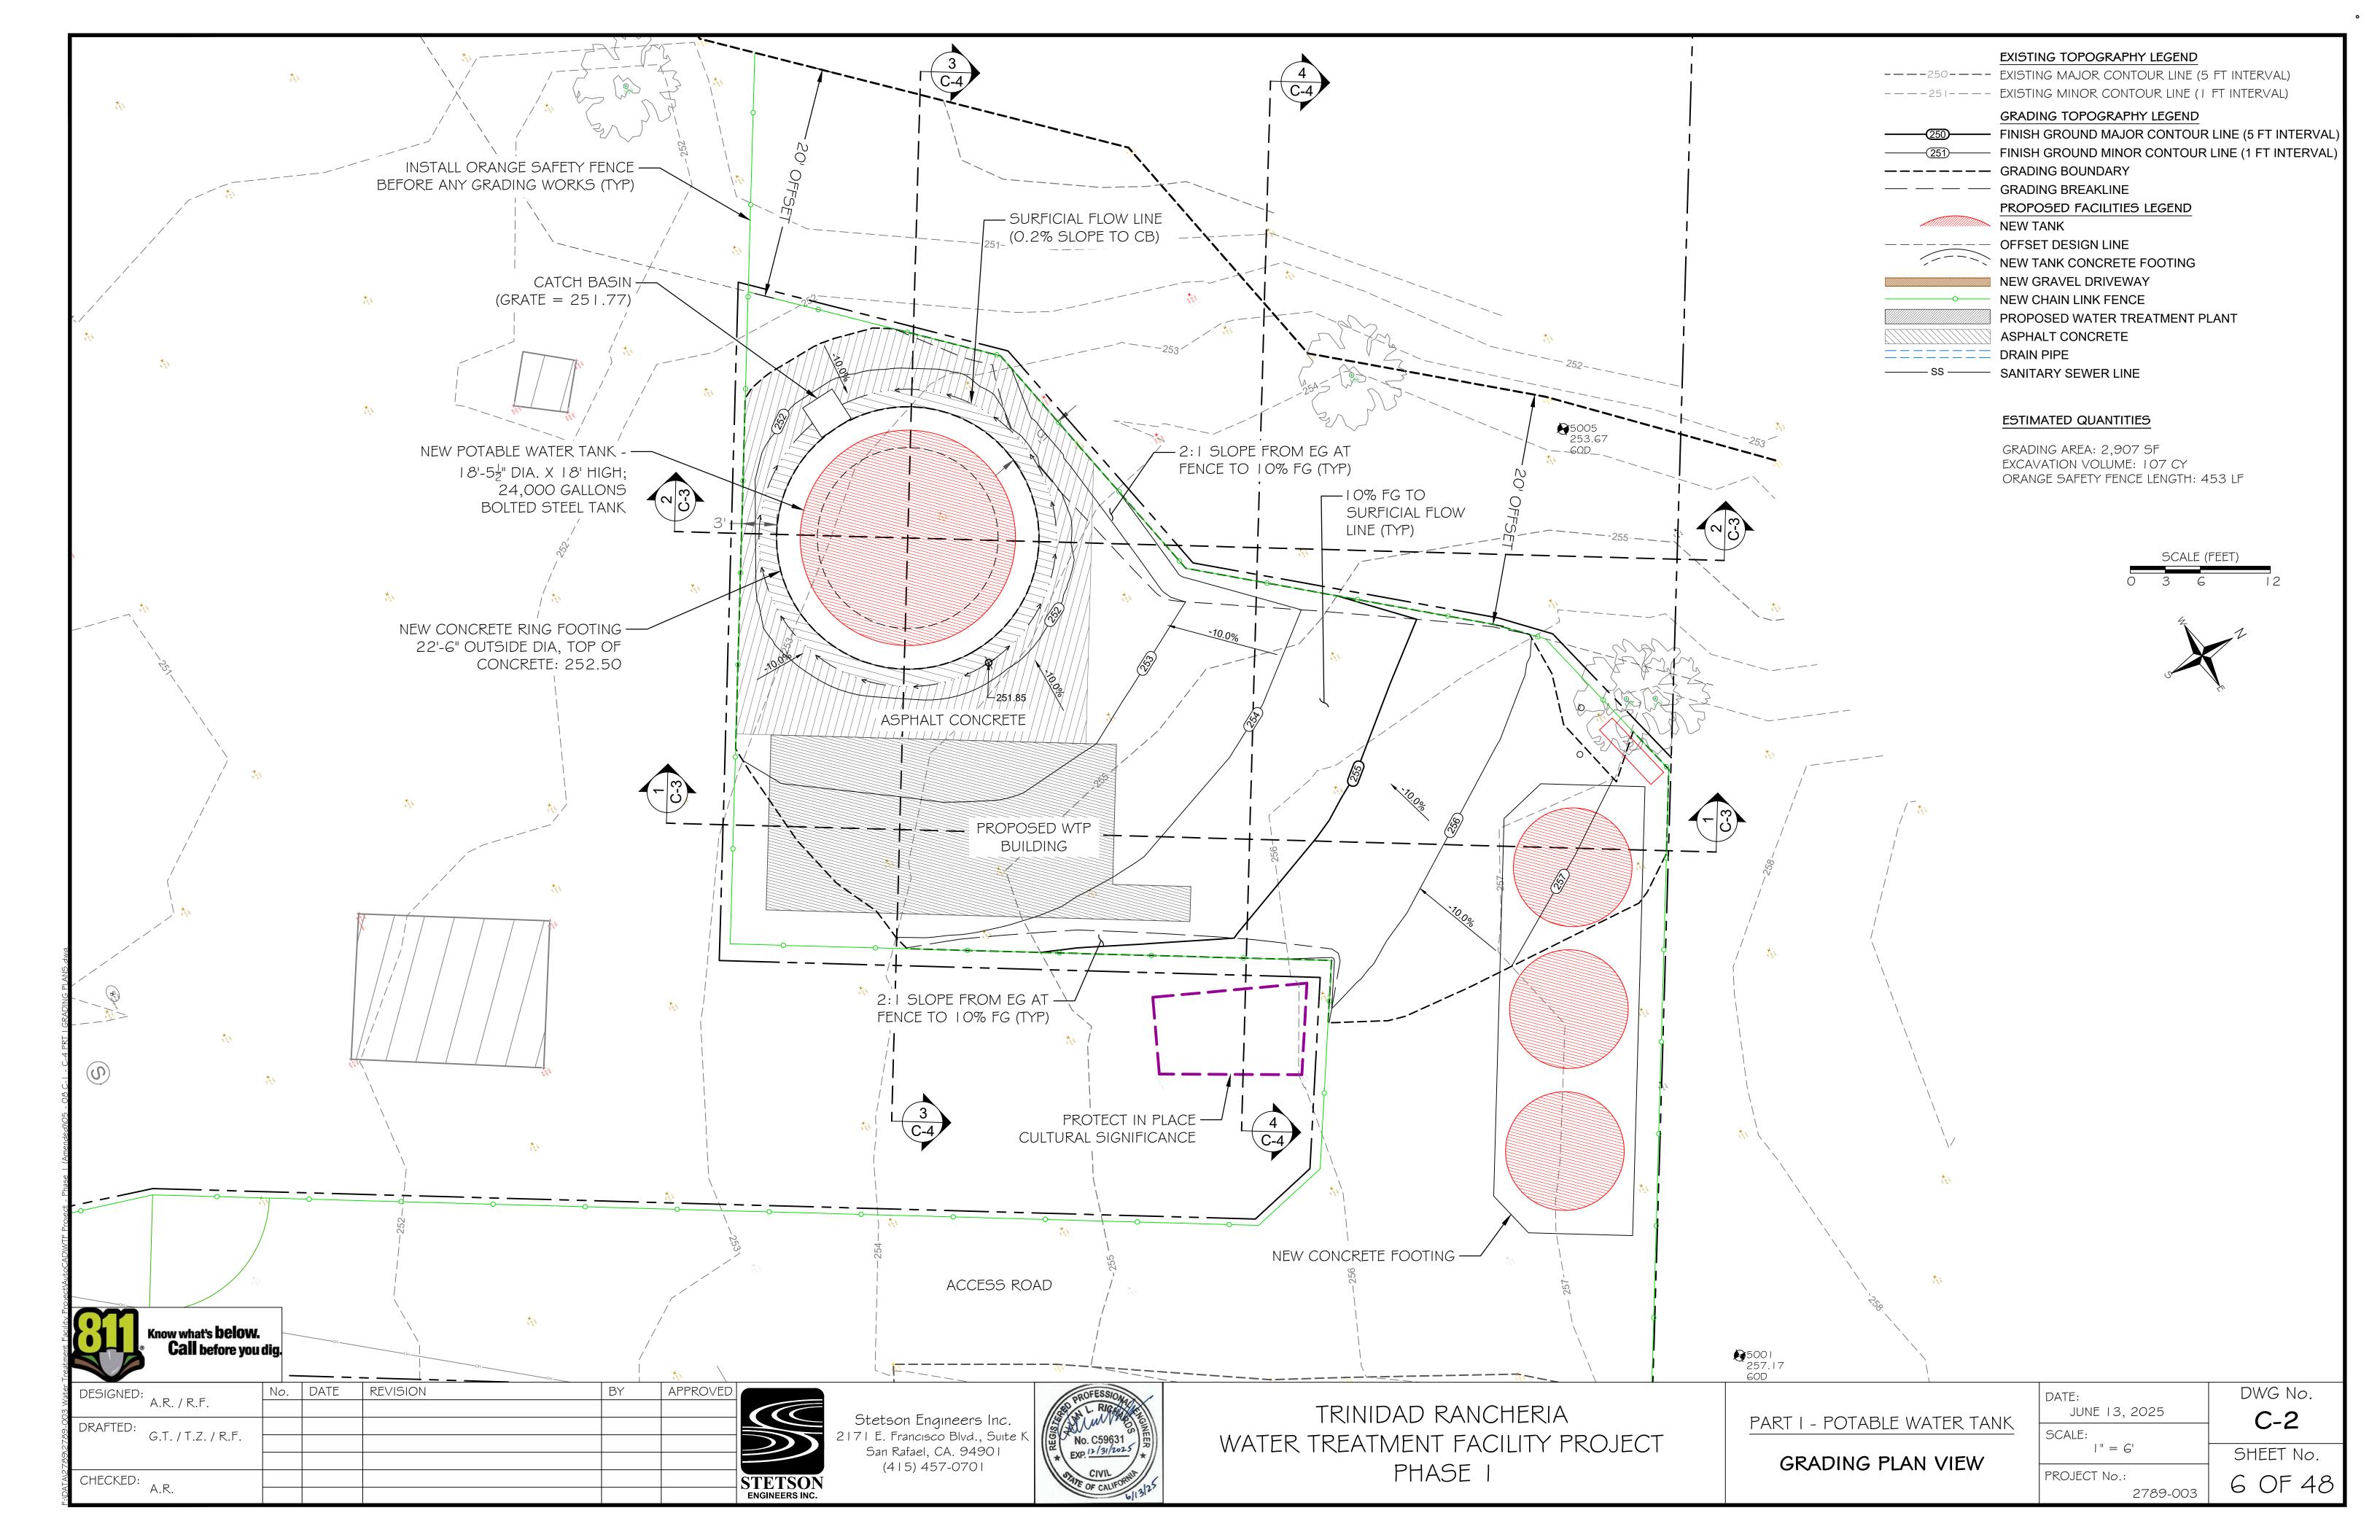
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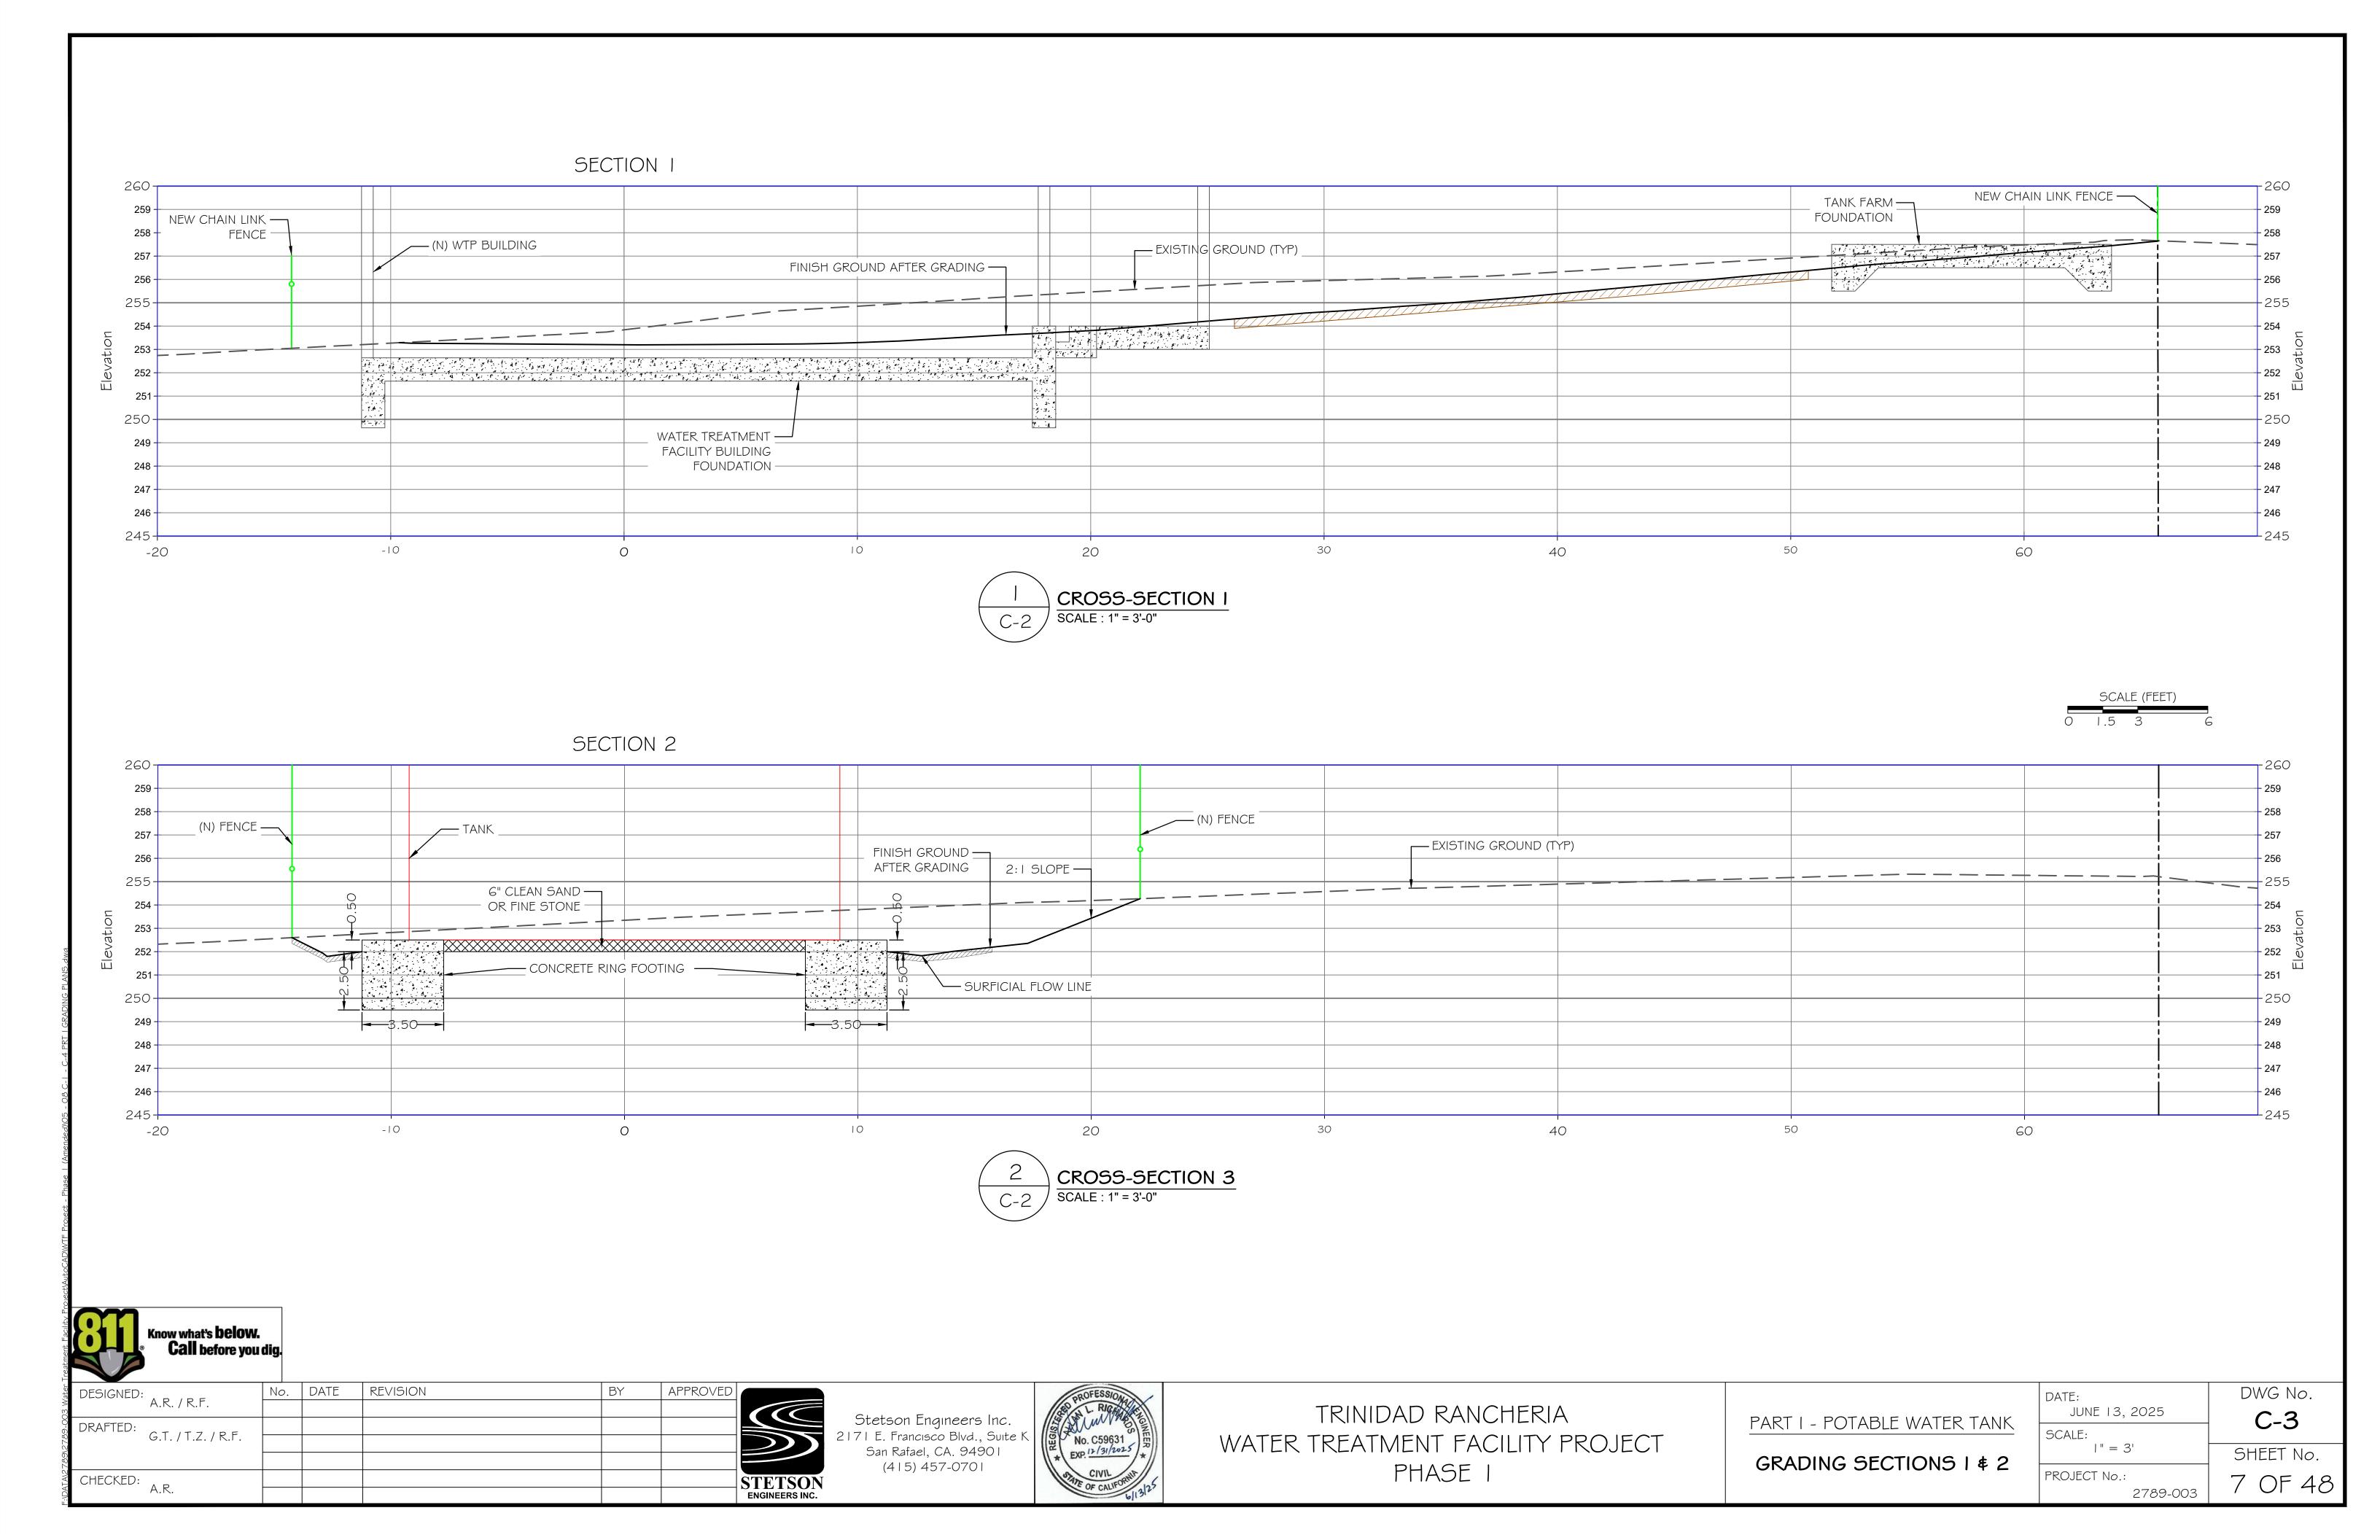
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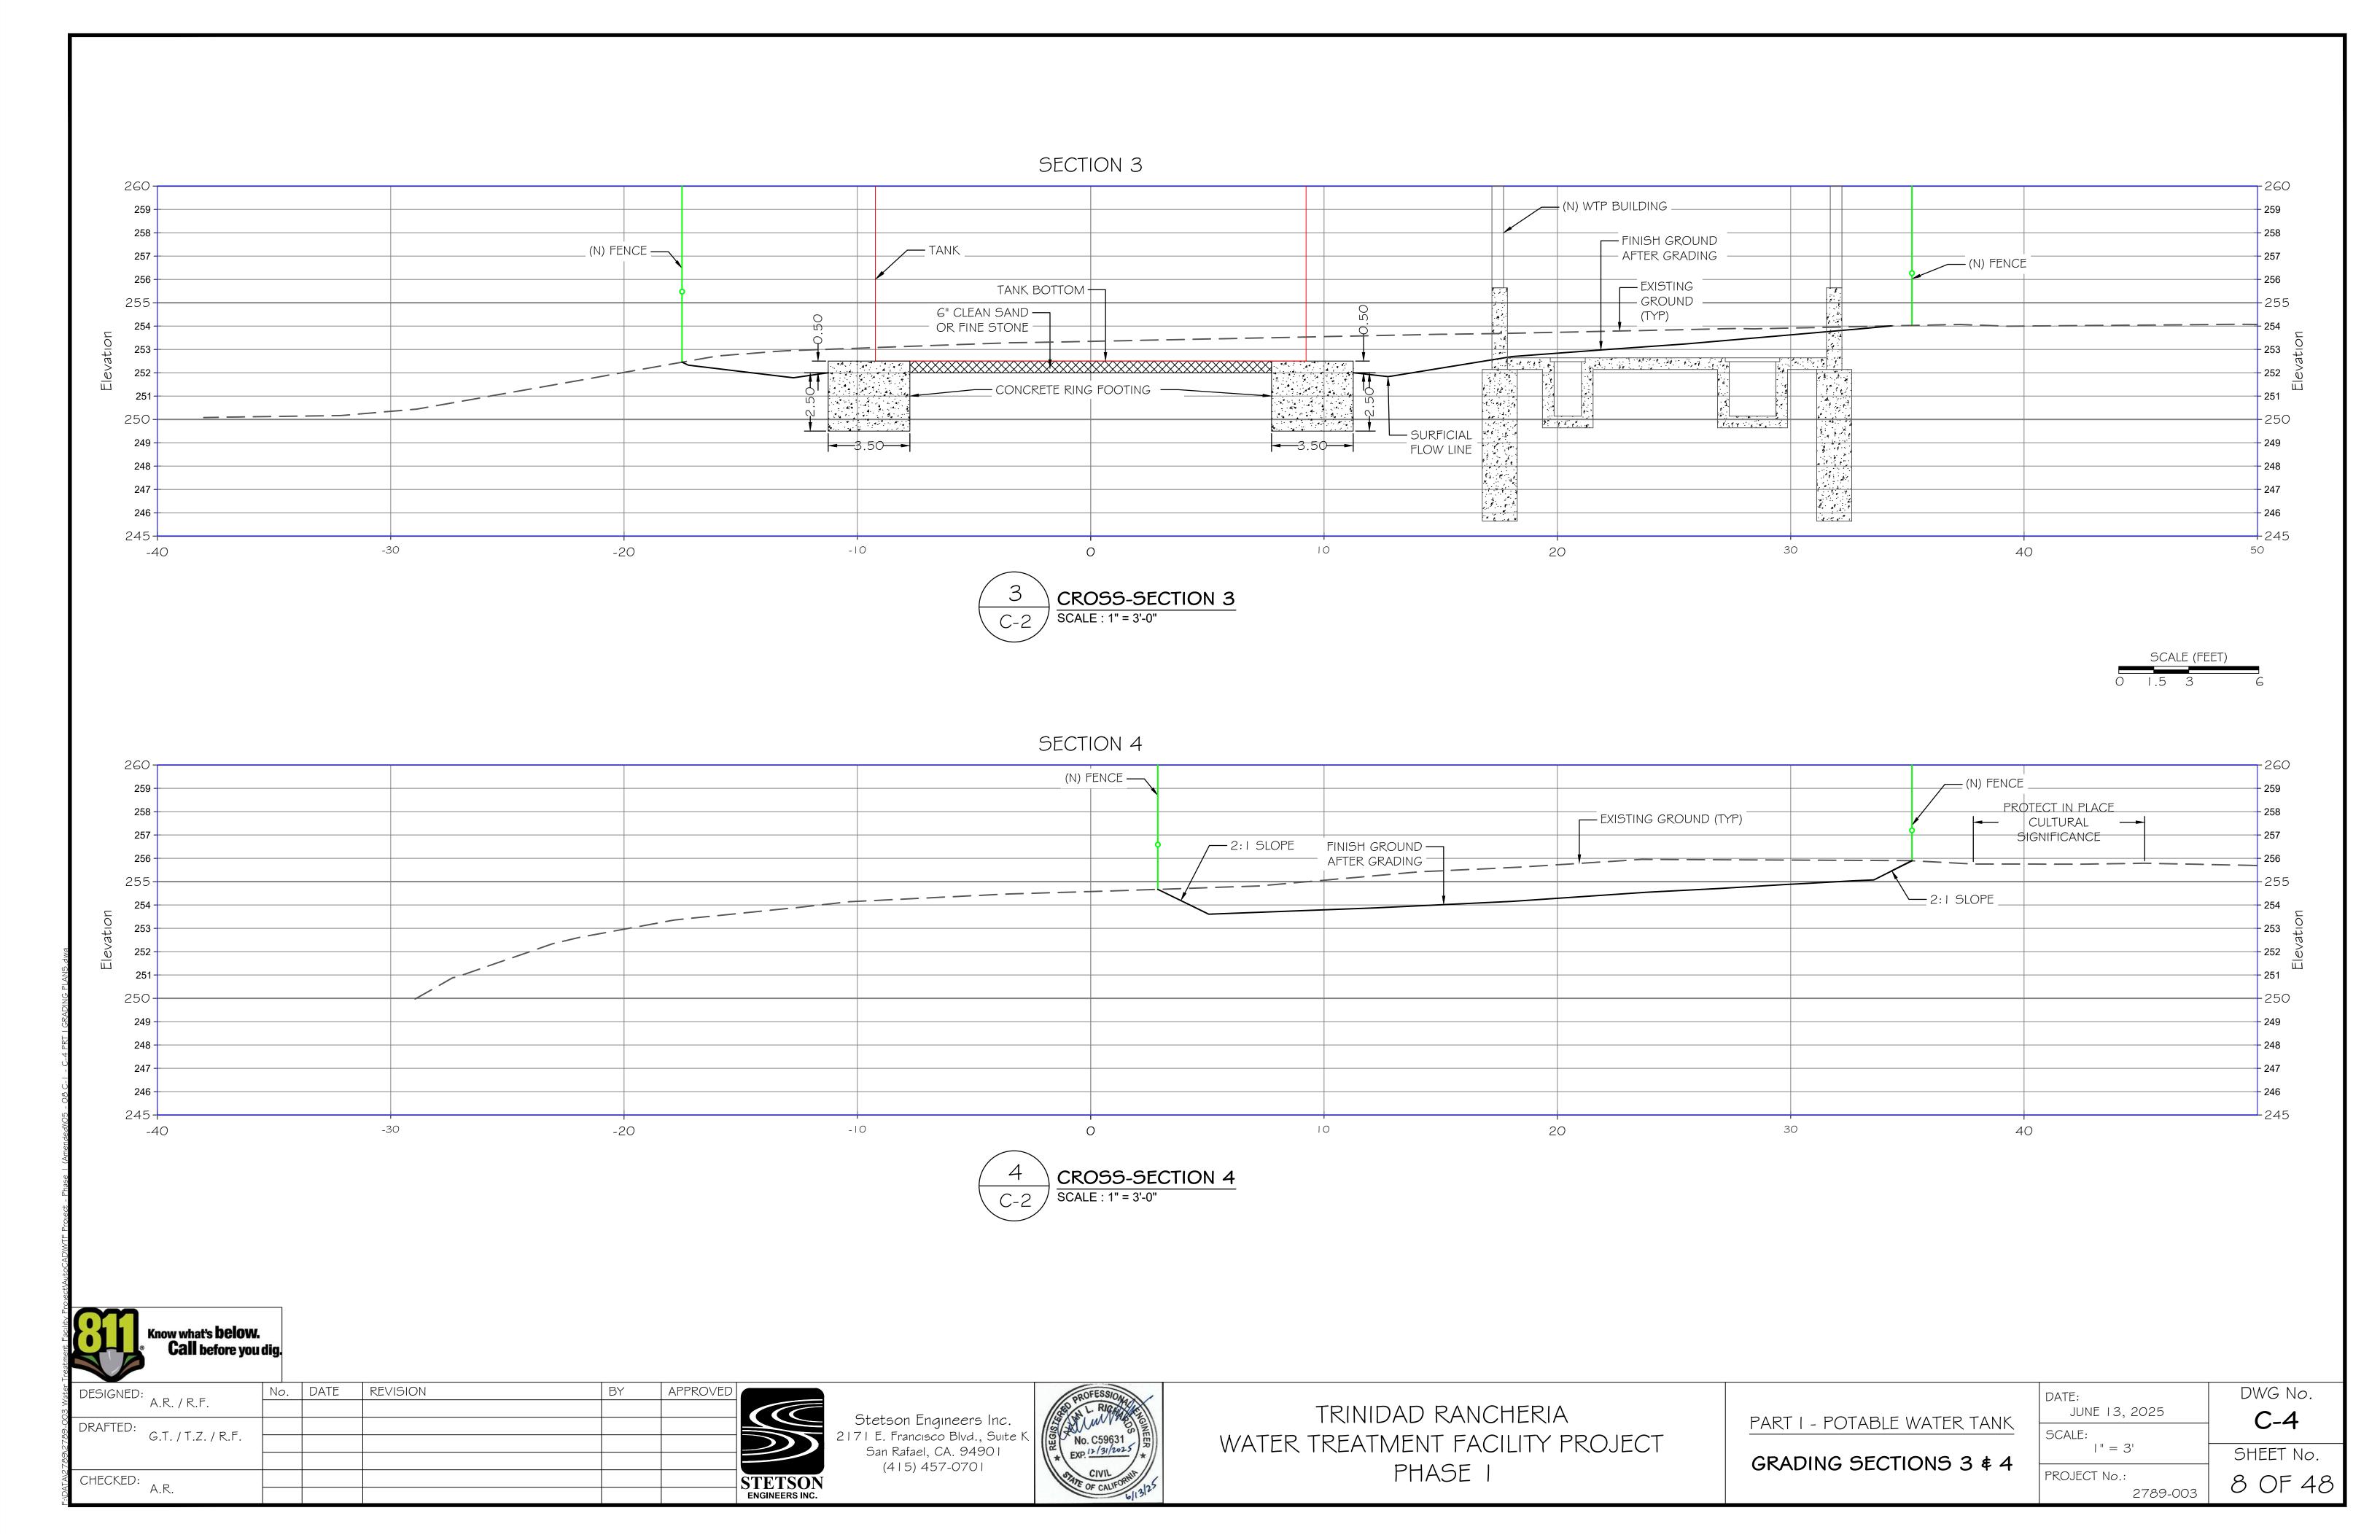
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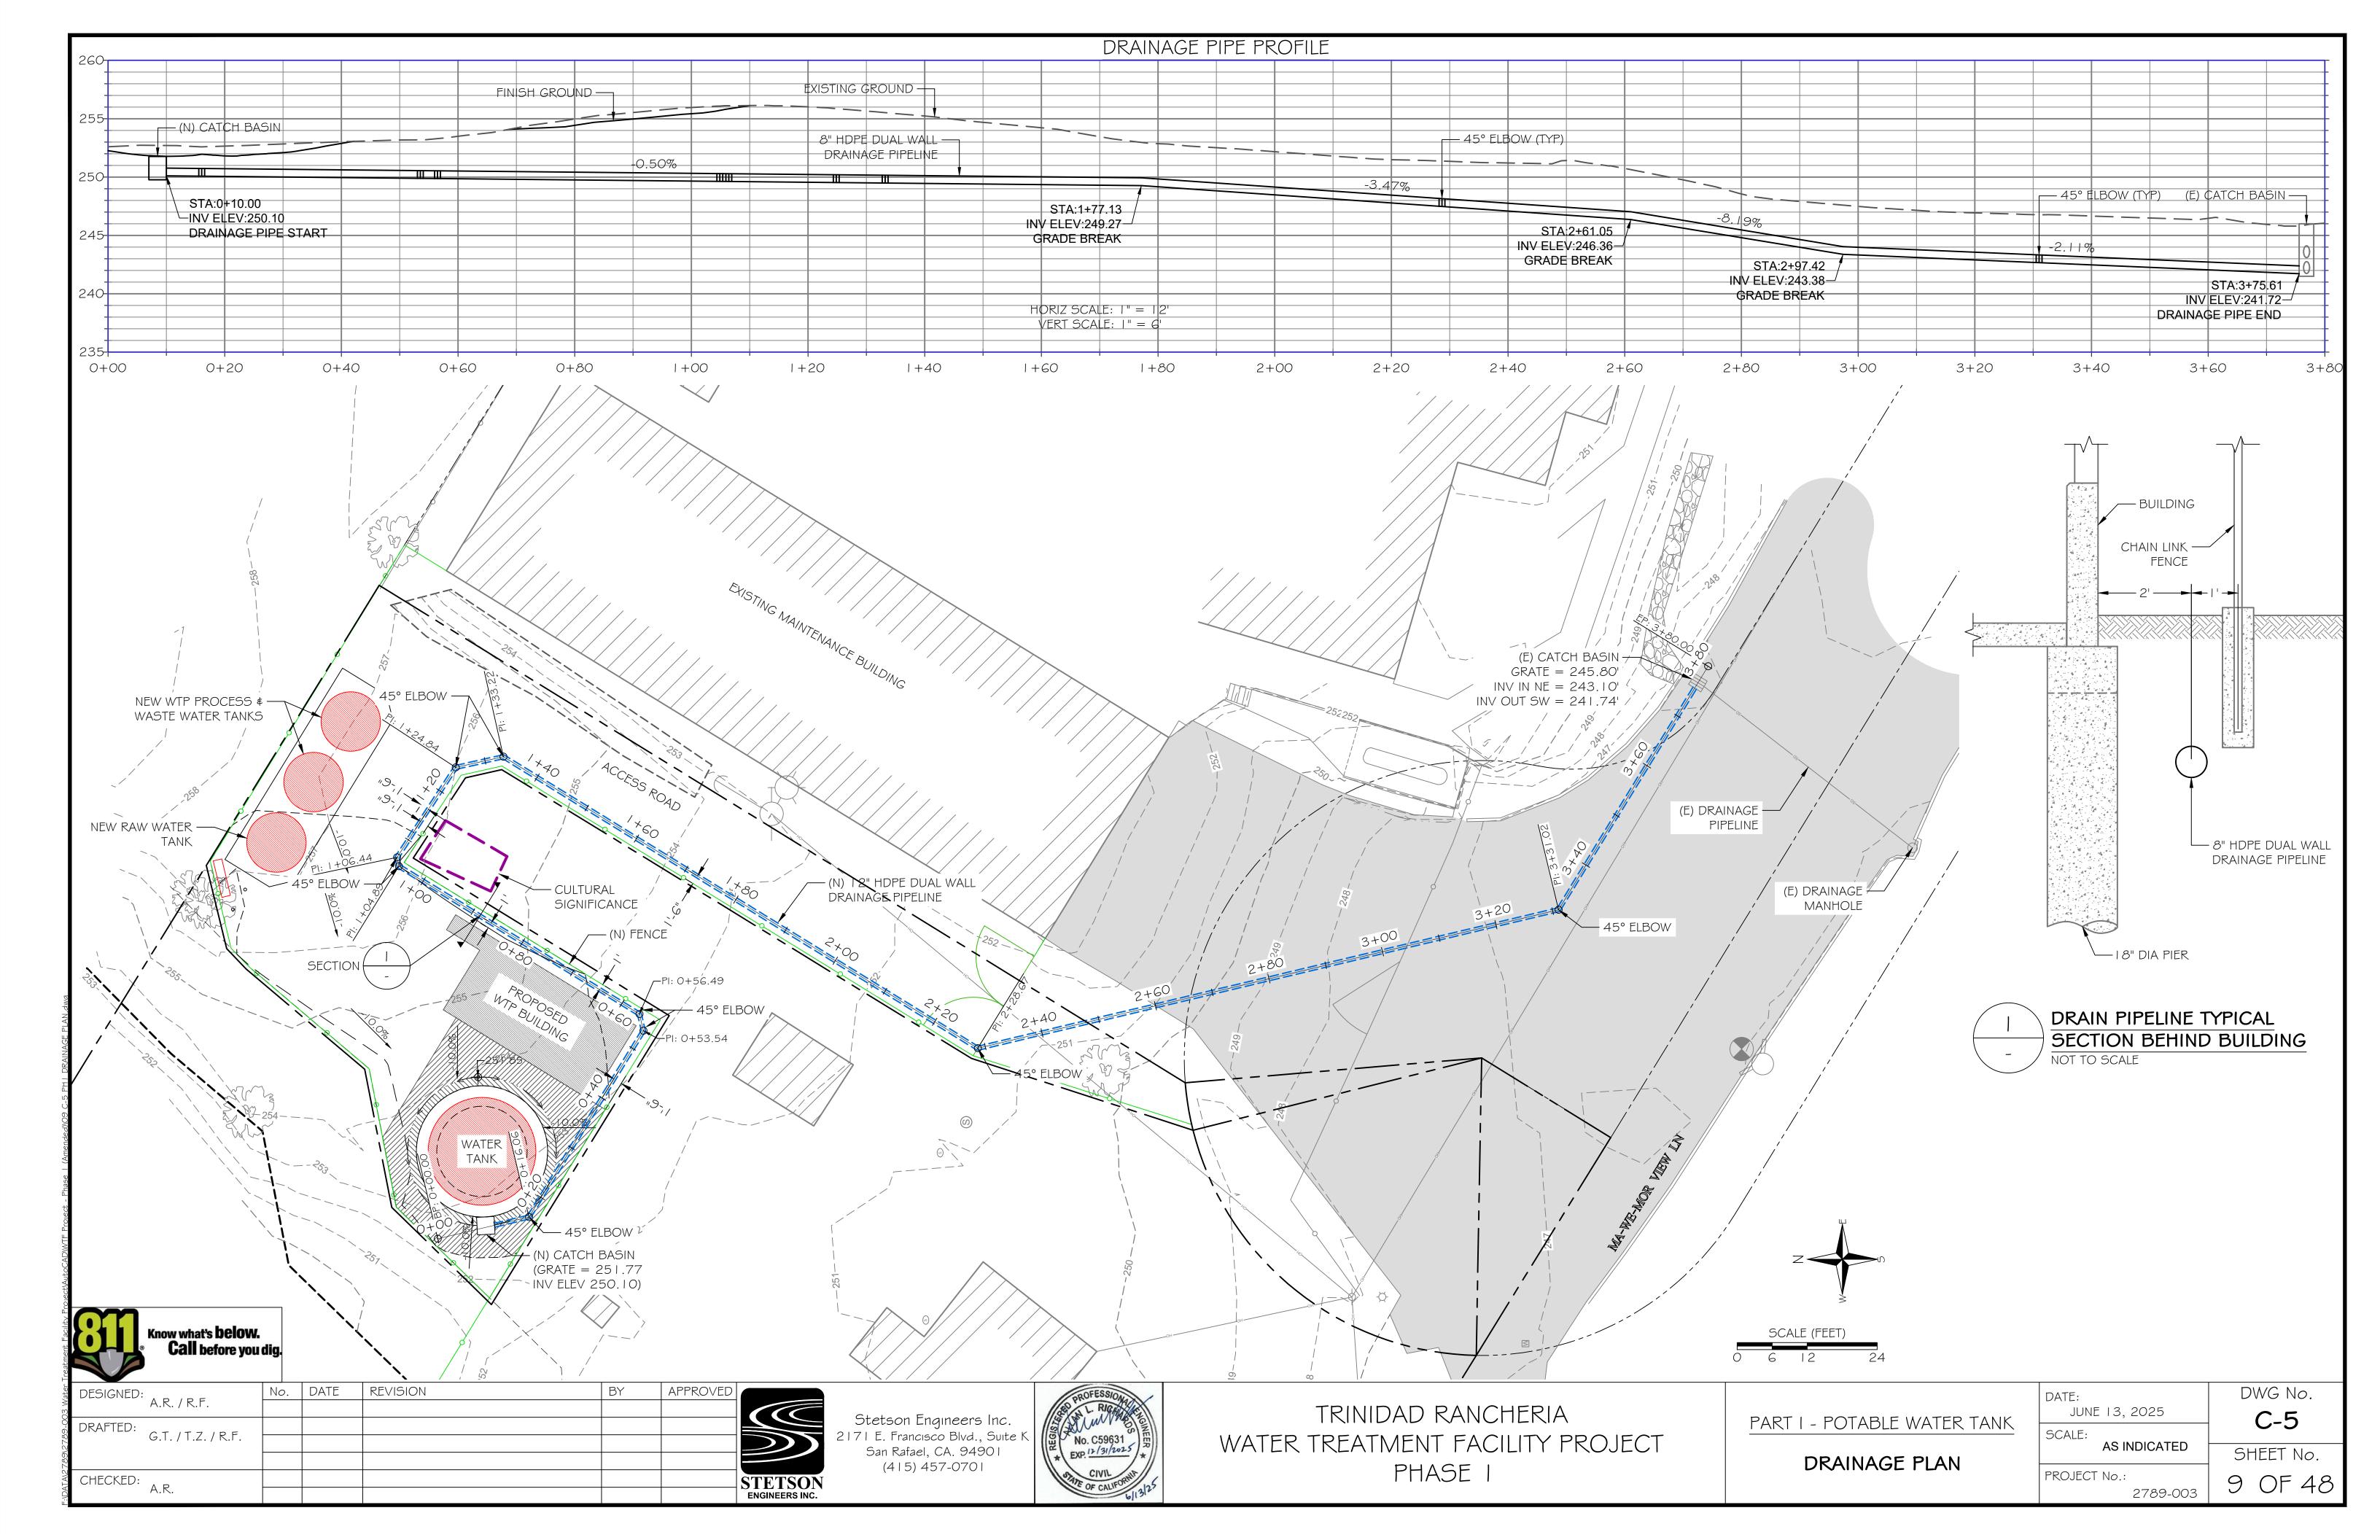
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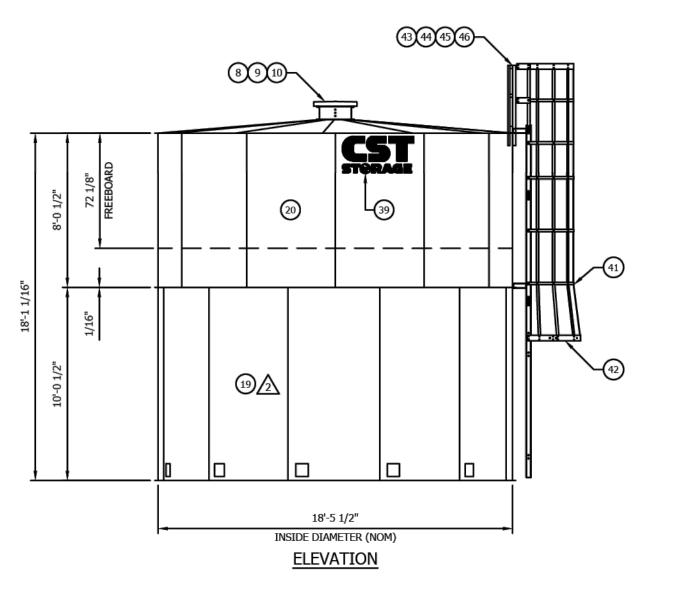














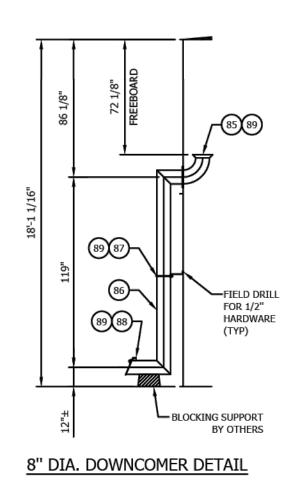


	MATERIALS O	F CONSTRUCTION	
<u>ITEM</u>	12 GA 7/32"	1/4" & HEAVIER	APPLIES TO THE FOLLOWING ITEM #'S:
SHELL/ROOF/FLOOR/PLATE/SHEET	ASTM A1011	ASTM A36, A656, A572	1, 2, 10, 11, 16, 19, 20, 22, 27, 28, 65-68
ANGLES	ASTM A572 GR 50	•	14, 17
ROUNDS	ASTM A500 GR B		
HRS CHANNEL	ASTM A572 GR 50		15
HRS WIDE FLANGE	ASTM A992 GR 50		
HSS ROUND & RECTANGULAR TUBE	ASTM A500 GR B		
PIPE	ASTM A53 GR B		
FLANGES	ASTM A105		
BOLTS - GALV	SAE J429 GR 5 (FU - 120 KSI))	
SAE J429 GR 8 (FU - 150 KSI))	
NUTS - GALV	SAE J429 GR 2		
	SAE J429 GR 8		

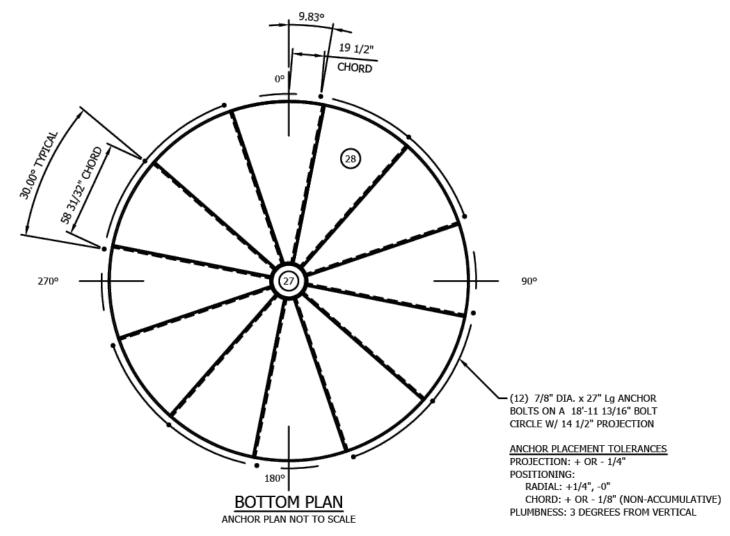

NOTES:

- 1. THIS BILL OF MATERIAL IS FOR ONE COMPLETE TANK.
- * 2. DRAWINGS REQUIRED FOR FIELD USE.
- 3. INTERIOR AND BOTH SIDES OF BOTTOM PAINTED ONE COAT TRICO THERMOSET CORROSION RESISTANT POWDER EPOXY BOND EP ® (7 MILS AVERAGE, DFT). EXTERIOR PAINTED ONE COAT OF TRICO THERMOSET CORROSION RESISTANT POWDER EPOXY BOND EP ® WITH FINISH COAT OF STANDARD WHITE (#V01726-100) PERFORMANCE URETHANE (4.5 MILS AVERAGE, DFT).
- 4. PORTABLE WATER STORAGE TANK DESIGNED IN ACCORDANCE WITH AWWA D103-09 SPEC. SS= 271.00%, S1= 109.00%, SEISMIC USE GROUP = 2, SITE CLASS= C, SEISMIC DESIGN CATEGORY = E, IMPORTANCE FACTOR IE = 1.25, TL = 8.00, 103 MPH WINDLOAD PER CBC 2022 w ASCE 7-16, RISK CATEGORY = 3, EXP = C, 25 PSF LIVE DECK LOAD, SPECIFIC GRAVITY = 1.00.
- 5. STANDARD CENTER DOME WITH VENT WILL RELIEVE 24 CFS (11,000 GPM). ADDITIONAL VENTING TO PREVENT A VACUUM GREATER THAN 0.4 OZ PER SQUARE INCH IS THE RESPONSIBILITY OF THE OWNER.
- 6. FIBERBOARD SHALL BE INSTALLED IN ACCORDANCE WITH AWWA D103-09, SECTION 13.4.
- 7. ALL BOLTED CONNECTIONS ARE BEARING CONNECTIONS. FOR CST MINIMUM AND MAXIMUM TORQUE VALUES FOR WATER-TIGHTNESS, REFERENCE CST ERECTION MANUAL. FOR CONNECTIONS NOT ADDRESSED IN THE CST ERECTION MANUAL, USE THE TURN-OF-THE-NUT METHOD.

	ITEM	D/S	PART NO.	QTY	DESCRIPTION		PAINT
$\sqrt{2}$	65	-	115T1018-209502E	1	10 GA x 60" SP STV x 120 1/2" w/1 STR PCH W/6" DIA. NZL OPNG		E/ET
$\sqrt{2}$	66	-	115T1018-209502F	1	10 GA x 60" SP STV x 120 1/2" w/1 STR PCH W/6" DIA. NZL OPNG		E/ET
$\sqrt{2}$	67	-	115T1018-209502G	1	10 GA x 60" SP STV x 120 1/2" w/1 STR PCH W/4" DIA. NZL OPNG		E/ET
	68	-	112T1218-209502D	1	12 GA X 60" SP STV X 96 1/2" W/8" DIA. O-FLOW OPNG		E/ET
	69	-		0			N
	70	-		0			N
	71	-		0			N
	72	-	734T00401	1	1/2" HALF COUPLING [SAMI	PLE TAP]	ET
	73	-	716B0500-208505A	1	1/2" DIA. SAMPLE TAP (BRASS) NON-THREADED [SAMI	PLE TAP]	N
	74	-	8734BPW010HW	1	1/4" - 1" DIA. NOZZLE EPDM KIT [SAMI	PLE TAP]	N
	75	-		0			N
	76	-	704T020F0080	2	2" DIA. EXTERIOR FF NOZZLE [EXTRA	NOZZLES]	ET
	77	-	8704BPW020HW	2	1 1/4" - 2" DIA. SINGLE NOZZLE EPDM KIT [EXTRA	NOZZLES]	N
	78	-		0			N
	79	-	704T040F0080	1	4" DIA. EXTERIOR FF NOZZLE [DI	RAIN]	ET
	80	-	8704BPW025HW	1	2 1/2" - 5" DIA. SINGLE NOZZLE EPDM KIT [DI	RAIN]	N
	81	-		0			N
	82	-	704T060F0080	2	6" DIA. EXTERIOR FF NOZZLE [INLET]	[OUTLET]	ET
	83	-	8704BPW060HW	2	6" DIA. SINGLE NOZZLE EPDM KIT [INLET]	[OUTLET]	N
	84	-		0			N
	85	-	320T08000	1	WEIR CONE W/ELBOW 8"DIA PIPE [OVE	RFLOW]	Е
	86	-	681T08-209502A	1	DOWNCOMER, 1 PC, 8" X 119" CL, SCH 10 [OVE	RFLOW]	ET
	87	-	683T10081	1	EXT. 8" DIA. PIPE BRACKET W/ 12 5/16" CL [OVE	RFLOW]	ET
	88	-	304T0108A	1	FLAP GATE 8" [OVE	RFLOW]	ET
	89	-	802BPW08161HW	1	8" OVERFLOW W/ DOWNCOMER HARDWARE KIT [OVE	RFLOW]	N
	90	-		0			N

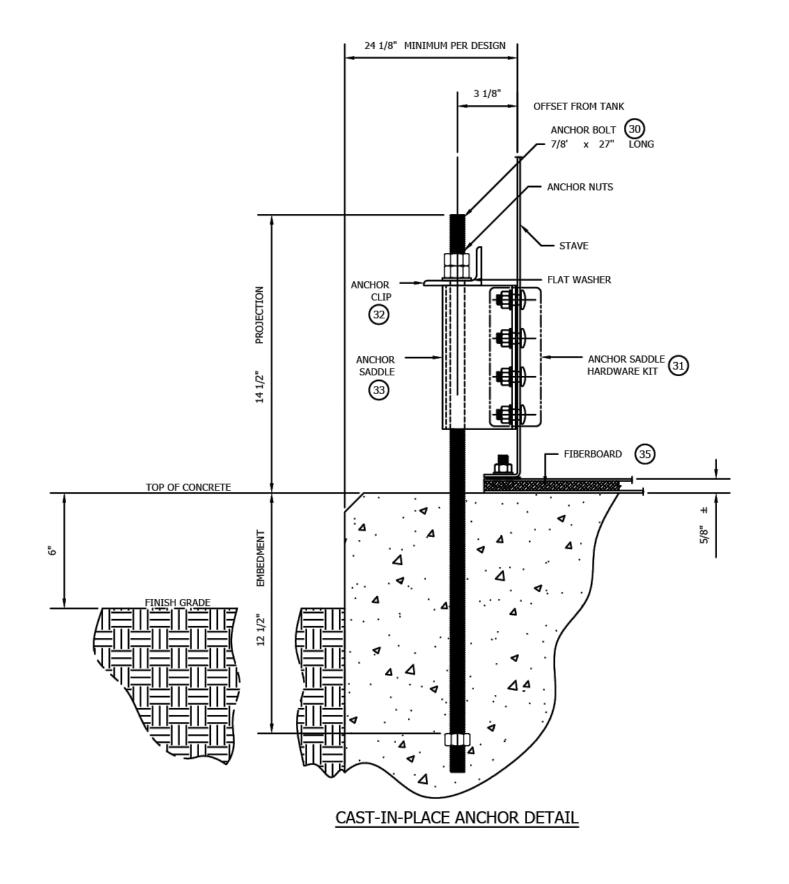

	1	-	201T12018	10	STD. 12 GA DECK SHEET	E/ET
	2	-	201T12618	1	12 ga deck sheet w/24" sq. manway opng	E/ET
*	3	-	35624	1	24" DECK MANWAY ASSEMBLY DRAWING	N
ı	4	-	356T10240	1	24" DECK MW CVR 10GA	E/ET
	5	-	356T102404	1	24" DECK MW FLG BX ASSY 10GA	E/ET
	6	Η-	8356BPW0024PHW	1	DECK MANWAY - 24" SQ. HARDWARE KIT	N
	7	\vdash	1002720	1	FREE FLOWING VENT ASSEMBLY - 304SS SCREEN 82% OPEN AREA	N N
	\vdash	_				
-	8	_	50-80-0306-10	1	20" VENT CAP LARGE SPUN 16GA ALUM	N
	9	-	1002659	1	HDW KIT, 20" DIA. VENT, 304SS SCREEN 82% OPEN AREA	N
	10	-	350T10009	1	MANHOLE COLLAR (36 DN / 28 UP HL)	E/ET
	11	-	201T12518	1	12 GA DECK SHEET W/ LIQUID LEVEL IND. OPNG	E/ET
*	12	-	715C10118	1	LIQUID LEVEL INDICATOR - 18' HIGH TANK 10,8	N
	13	-		0		N
ı	14	-	510T04119	2	MANHOLE SUPPORT. 2" X 2" X 1/4" ANGLE X 18 3/4" COPED	E
	15	\vdash	400T08219	1	DECK SUPT. CHANNEL C8 X 11.5 X 18'-3"LG	E
	-	Ė				
	16	_	378T05004	2	HANGER FOR DECK BEAM	E
	17	-	18-06-3049-00	12	DECK REINFORCEMENT ANGLE 1 1/2 X 1 1/2 X 97 1/4" LG	E
.	18	-		0		N
⇘	19	1	115T1011801	8	10 GA x 60" SP STV x 120 1/2" w/1 STR PCH	E/ET
╗	20	-	112T1211800	11	12 GA X 60" SP STV X 96 1/2"	E/ET
	21	-		0		N
۸l	22	_	115T1011801J	1	10 GA x 60" SP STV x 120 1/2" w/1 STR PCH W/24" DIA SHELL MW OPNG	E/ET
2\	23	\vdash	366T06004PS	1	3/8" X 33" OD MANWAY COVER	E/ET
ı	-	Ē				
	24	_	366T06218PS	1	24" DIA. SHELL MANWAY FRAME 2RV	E/ET
	25	-	8366BPW064HW	1	24" SHELL MW HARDWARE KIT	N
	26	-		0		N
	27	Ŀ	351T10004	1	10 GA BOTTOM CENTER COVER (36 HL)	Е
	28	ı	226T12018	12	12 GA FLAT BOTTOM SHEET	Е
1	29	-		0		N
	30	┢	81000757-407	12	ANCHOR HDW KIT - 7/8" X 27" LG F1554 GR36	N
	31	\vdash	8778BPW-HW	12	ANCHOR BOLT SADDLE HDW KIT 8HL PC EPDM	N
	-	Ė				
	32	_	50-80-0109-20G	12	ANCHOR CLIP FOR 7/8" DIA.	Z
	33	-	50-80-0112-37G	12	AB SADDLE 8HL LIQUID (HDG)	Z
	34	-		0		N
	35	-	795ASPEXJT48	18	ASPHALT IMPREGNATED FIBERBOARD 5'-0" X 48"	N
- 1	36	-		0		N
	37	-	341SS000L	1	LIQUID TANK - NAMEPLATE (341SS000L-209502A)	N
ı	38	-		0		N
	39	\vdash	10-00-0000-50	1	CST STORAGE LOGO	N N
	\vdash	Ē	10-00-0000-30		CST STORAGE LOGO	_
.	40	_		0		N
*	41	-	1008208-000	1	EXT LDR ASSY STD 18'	Z
*	42	-	1008436-000KIT	1	LOCKABLE HOOP ASSEMBLY	Z
	43	Ŀ	1010568-000	1	SWING GATE, 22" X 24" - FABENCO Z70-24	N
١	44	-	50-00-0000-99	1	GUARDRAIL OPNG KIT	Z
*	45	-	L50-18-9504-01	1	GUARDRAIL - 5' EACH SIDE OF LADDER W/ TOE BOARD (GALV)	Z
*	46	_	878G000-99	1	GUARDRAIL OPENING DETAILS	N
	47	-		0		T N
	\vdash	\vdash	20224E 000		EDECTION MANUAL	+
	48	Ě	282245-000	1	ERECTION MANUAL	N
. I	49	Ŀ		0		N
*	50	-	918T018-209502A	1	ELEVATION, BOTTOM PLAN & BILL OF MATERIAL	N
*	51	Ŀ	918T018-209502B	1	TANK STRETCH-OUT, STRUCTURE & DECK	N
*	52	-	918T018-209502C	1	TANK HARDWARE	N
	53	-		0		N
	54	-		0		N
ı	55	_		0		N
	56	\vdash		0		N N
	\vdash	Ē				+
ļ	57	_		0		N
	58	_		0		N
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١	60	-		0		N
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ı	62	-		0		N
	63	\vdash		0		+
	0.5	Ē				N N
-	64			0	1	N

DESCRIPTION

10 STD. 12 GA DECK SHEET

E/ET



"FINAL DRAWING: This drawing has been formally approved by both CST and the customer on the CST Sales Order for release to fabrication. Any change orders received by the customer are subject to a change order fee PLUS any additional material cost and/or fees/penalties associated with project management, engineering, manufacturing, and shipping. Also, changes after this milestone will delay shipment and require additional lead time. Any changes to loads and accessories may require engineering design changes with additional price impact and lead time. Engineering design changes are billable per CST's standard engineering hourly rate. THIS DRAWING HAS BEEN RELEASED FOR FABRICATION. Contact your CST Project Manager with any questions."

11/20/23

	3
CTODACE	2
903 E 104TH ST. SUITE #900	1
KANSAS CITY, MISSOURI 64131	RE

PART

TTEM D/S PAR
1 - 201T12018

							ELEVATION, BOTTOM PLAN AND BOM 18'-5 1/2" DIA. x 18' HIGH TANK
3	UPDATED DESIGN NOTES PER REVISED DESIGN		TGS	MMN	ZKM	11/10/2023	TRINIDAD RANCHERIA TRINIDAD, CA. USA
2	REVISED STAVE THICKNESS ON BOTTOM RING FROM 12GA TO 10GA CHANGE AFTER RELEASE		HML	NN	NN	05/20/22	BY: BWS DATE: 2/23/2021 NEXT ASSY: ORDER NO.:
1	UPDATED PER ECO-003586001-02 & ECO-003586001-03 RELEASED FOR FABRICATION		TQA	TGS	CKH	05/09/22	APPR: CKH DATE: 05/16/22 DWG#: RE
REV.	REVISION DESCRIPTION	ECN.	BY	CHKD.	APPR.	DATE	SCALE: NTS SHEET: OF 918T018-209502A
							D1110 11

CONTENTS ARE RODUCED,

	CC	ONFIDENTIAL, PROPI	RIETARY TRADE SECR	ETS OF CST STORAG	OF THIS DOCUMENT, F GE. NO PORTION OF T PERMISSION FROM CS	HIS DOCUMENT MAY	
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TRINIDAD RANCHERIA
WATER TREATMENT FACILITY PROJECT
PHASE I


ANSAS CITY, MISSOURI 64131 REV. REVISION DESCRIPTION	ECN. BY CHKD. APPR. DATE SCALE: NTS SHEET: OF	9101010-209302A
PART I - POTABLE WATER TANK	DATE:	DWG No.
	JUNE 13, 2025	T_I
CST TANK DETAILS	SCALE:	
	AS INDICATED	SHEET No.
ELEVATION, BOTTOM PLAN	PROJECT No.:	10 OF 48
AND BOM	2789-003	10 01 40



DESIGNED:	A.R. / R.F.	No.	DATE	REVISION	BY	APPROVED	
	A.R. / R.F.						
DRAFTED:	G.T. / T.Z. / R.F.						
	G.I. / I.Z. / K.F.						
CHECKED:	Λ D						STE
	A.R.						ENGII



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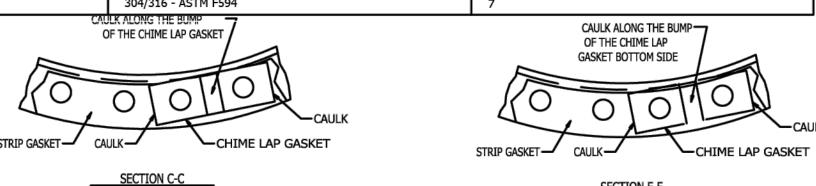
	RING 1: 12 GA 1RV	
LOCATION	DESCRIPTION	QTY
VERTICAL SEAM BOLTS	1/2 X 1 1/4 FN PC HD HDG	720
VERTICAL SEAM NUTS	1/2 HEX NUT	720
VERTICAL SEAM WASHERS	1/2 NEOP BKD STEEL GALV	720
VERT SEAM STRIP GASKET	STRIP GSKT - 1 HOLE EPDM	128
CHIME BOLTS	1/2 X 1 SQ HD HDG GR5	324
CHIME LAP BOLTS	1/2 X 1 1/4 SQ HD HDG GR5	24
CHIME WASHER	1/2 FLAT STEEL GALV	324
CHIME NUTS	1/2 HEX NUT	348
CHIME STRIP GASKET	STRIP GSKT - 1 HOLE EPDM	60
CHIME LAP GASKET	GSKT CH/LAP LT EPDM	24
RADIUS GASKET	GSKT LT RAD EPDM 1RV	24
CHIME LAP BOLT WSH REC	1/2 NEOP BKD STEEL GALV	48

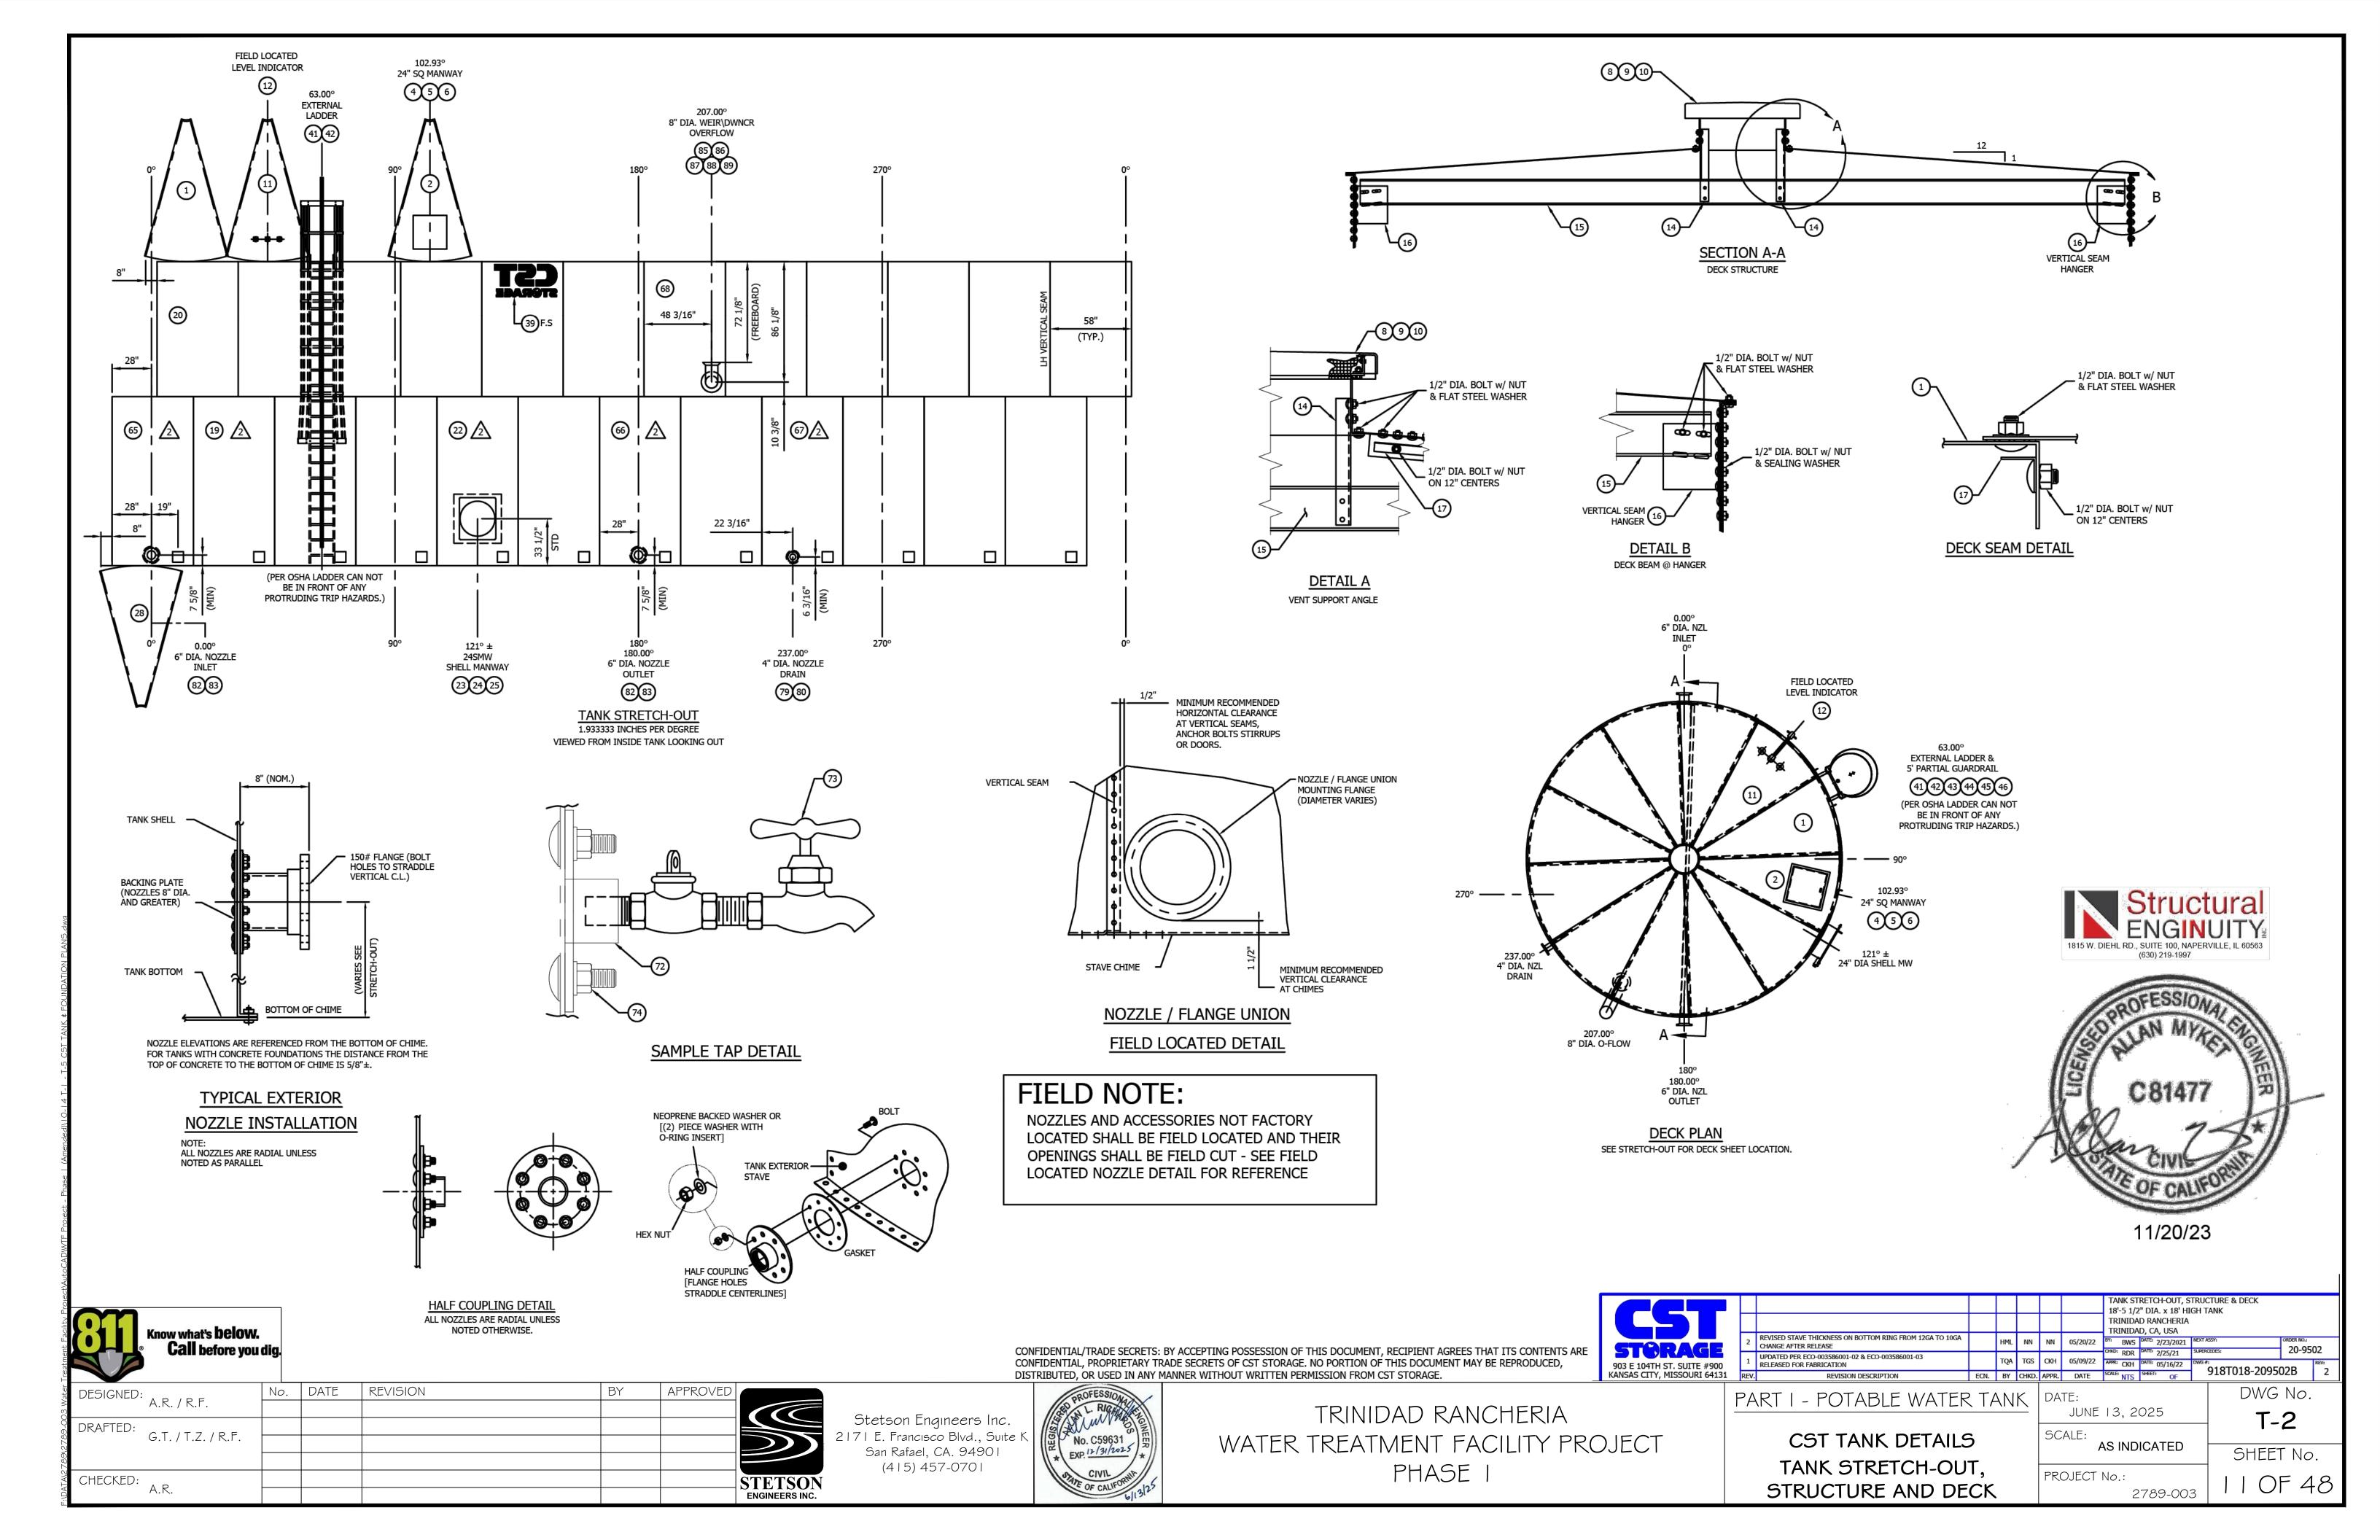
RING 2: 12 GA 1RV					
LOCATION	DESCRIPTION	QTY			
HGR TO SIDEWALL BOLTS	1/2 X 1 1/4 FN PC HD HDG	10			
VERTICAL SEAM BOLTS	1/2 X 1 1/4 FN PC HD HDG	566			
VERTICAL SEAM NUTS	1/2 HEX NUT	576			
VERTICAL SEAM WASHERS	1/2 NEOP BKD STEEL GALV	576			
VERT SEAM STRIP GASKET	STRIP GSKT - 1 HOLE EPDM	104			
CHIME BOLTS	1/2 X 1 SQ HD HDG GR5	324			
CHIME LAP BOLTS	1/2 X 1 1/4 SQ HD HDG GR5	24			
CHIME WASHER	1/2 FLAT STEEL GALV	324			
CHIME NUTS	1/2 HEX NUT	348			
CHIME STRIP GASKET	STRIP GSKT - 1 HOLE EPDM	60			
CHIME LAP GASKET	GSKT CH/LAP LT EPDM	24			
RADIUS GASKET	GSKT LT RAD EPDM 1RV	24			
CHIME LAP BOLT WSH REC	1/2 NEOP BKD STEEL GALV	48			

SECTION F-F

	MATERIALS O	F CONSTRUCTION			
<u>ITEM</u>	12 GA 7/32"	1/4" & HEAVIER	APPLIES TO THE FOLLOWING ITEM #'S:		
SHELL/ROOF/FLOOR/PLATE/SHEET	ASTM A1011	ASTM A36, A656, A572			
ANGLES	ASTM A572 GR 50				
ROUNDS	ASTM A500 GR B				
HRS CHANNEL	ASTM A572 GR 50				
HRS WIDE FLANGE	ASTM A992 GR 50				
HSS ROUND & RECTANGULAR TUBE	ASTM A500 GR B				
PIPE	ASTM A53 GR B				
FLANGES	ASTM A105				
BOLTS - GALV	SAE J429 GR 5 (FU - 120 KSI)		1, 2, 3		
	SAE J429 GR 8 (FU - 150 KSI)				
NUTS - GALV	SAE J429 GR 2		5, 6		
	SAE J429 GR 8				

<u>ITEM</u>	MATERIALS OF CONSTRUCTION	APPLIES TO THE FOLLOWING ITEM #'S:
SHELL/ROOF/FLOOR/PLATE/SHEET	304/304L/316/316L - A240	
ANGLE & CHANNEL	304/304L/316/316L - A276	
ROUND TUBE	304/304L/316/316L - A269	
RECTANGULAR TUBE	304/304L/316/316L - A554	
PIPE	304/304L/316/316L - A312	
BOLTS	304/316 - ASTM F593	4
NUTS	304/316 - ASTM F594	7
	CAULK ALONG THE BUMP 7	CALLIK ALONG THE RUMP



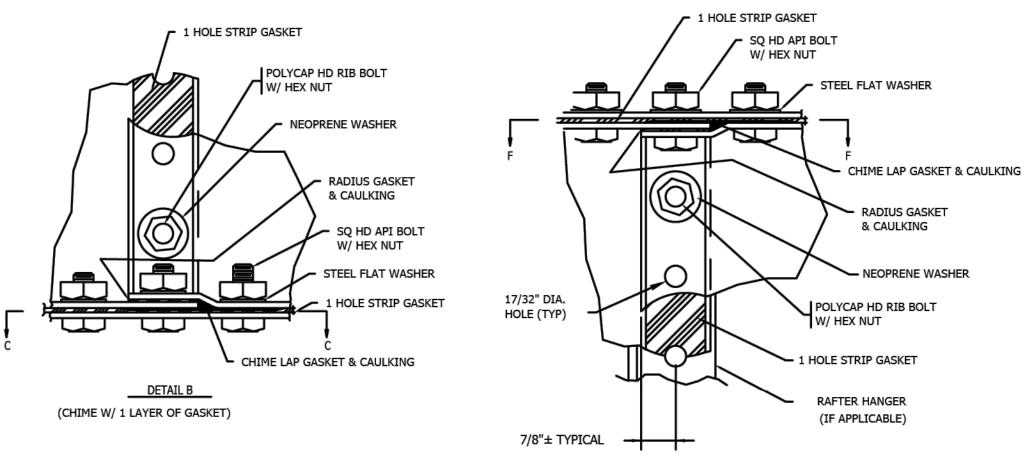

STRIP GASKET MUST LAP TWO BOLTS MINIMUM FLAT WASHER STRIP GASKET SECTION A-A CHIME STRIP GASKET OVERLAP DETAIL

		_	/TE ADDI		
			(IF APPL	ICADLE)	
	 				
ETA	<u>IL E</u>				
			l P	OLYCAP HD RIB BOLT	
				// HEX NUT	
			/		
			/		
		/	/	- 1 HOLE STRIP GASKET	
			\leq /		
	5			==	
			$\supset \setminus$,	
				NEOPRENE WASHER	
		CECTI	N D D	HEO! KEIL WASHER	
		SECTIO	ט-ט אכ	_	


FLAT BOTTOM SECTION: 12 GA CENTER PLATE: 10 GA					
LOCATION	DESCRIPTION	QTY			
CENTER PLATE BOLTS	1/2 X 1 SQ HD HDG GR5	24			
CENTER PLATE LAP BOLTS	1/2 X 1 1/4 SQ HD HDG GR5	12			
CENTER PLATE NUTS	1/2 ENCAP NUT	36			
CEN PLATE BOLT CHANNEL	2 HL	18			
CENTER PLATE GSKT	MANHOLE GASKET 36 HL	1			
RADIAL SEAM BOLTS	1/2 X 1 SQ HD HDG GR5	588			
RADIAL SEAM NUTS	1/2 ENCAP NUT	588			
RADIAL SEAM STRIP GSKT	STRIP GSKT - 1 HOLE EPDM	103			
RADIAL SEAM BOLT CHAN	48 HL	12			
BOTTOM LAP GASKET	GSKT CH/LAP LT EPDM	12			
BOTTOM CHIME STRIP GSKT	STRIP GSKT - 1 HOLE EPDM	60			
BOTTOM CHIME LAP GSKT	GSKT CH/LAP LT EPDM	12			
BOTTOM CHIME BOLT	1/2 X 1 SQ HD HDG GR5	324			
BOTTOM CHIME LAP BOLT	1/2 X 1 1/4 SQ HD HDG GR5	24			
BOTTOM CHIME NUT	1/2 HEX NUT	348			
BOTTOM CHIME WASHER	1/2 FLAT STEEL GALV	348			
BTM LAP BOLT WAHSER	1/2 NEOP BKD STEEL GALV	48			

	DECK: 12 GA
LOCATION	DESCRIPTION
CENTER DOME BOLTS	1/2 X 1 1/4 FN PC HD HDG
CENTER DOME LAP BOLTS	1/2 X 1 1/4 FN PC HD HDG
CENTER DOME WASHERS	1/2 FLAT STEEL GALV
CENTER DOME NUTS	1/2 HEX NUT
CENTER DOME GSKT	MANHOLE GASKET 36 HL
RADIAL SEAM BOLTS	1/2 X 1 1/4 FN PC HD HDG
RADIAL SEAM WASHERS	1/2 FLAT STEEL GALV
RADIAL SEAM NUTS	1/2 HEX NUT
RADIAL SEAM STRIP GSKT	STRIP GSKT - 1 HOLE EPDM
TOTAL LAP GSKT	GSKT CH/LAP LT EPDM
DEC	K SUPPORT - SELF SUPPORT
LOCATION	DESCRIPTION


DECK SU	JPPORT - SELF SUPPORT	
LOCATION	DESCRIPTION	QTY
CHANNEL SUPPORT BOLTS	BLT HH 1/2"X 1-1/4" SS/304	4
DOME SUPPORT BOLTS	BLT HH 1/2"X 1-1/4" SS/304	10
RETAINER ANGLE BOLTS	BLT HH 1/2"X 1-1/4" SS/304	108
HGR LAP GSKT	GSKT CH/LAP HVY EPDM	4
INTERIOR FLAT WASHERS	1/2 FLAT 304 SS	122
INTERIOR NUTS	NUT HX 1/2" *WAXED* SS/304	122


- 1	QTY						
\dashv	24	ITEM	D/S	PART NO.	QTY	DESCRIPTION	PAINT
\dashv	12	1	-	775G00810	1682	BOLT - 1/2 X 1 LG SQUARE HEAD HDG GR5	N
┪	36	2	-	775G00812	137	BOLT - 1/2 X 1 1/4 LG SQUARE HEAD HDG GR5	N
┪	36	3	-	777GR0812	2028	BOLT - 1/2 X 1 1/4 LG FIN POLYCAP HDG	N
ヿ	1	4	-	772S00812	176	BLT HH 1/2"X 1-1/4" SS/304	N
コ	588	5	-	279856-004	3103	NUT - 1/2 HEX GALVANIZED	N
	588	6	-	784NE0800	693	NUT - 1/2 ENCAPSULATED	N
	588	7	-	279856-002	176	NUT - 1/2 304SS HEX WAXED	N
_	103	8	-	791M04125	1701	WASHER - 1/2 FLAT STEEL GALVANIZED	N
	24	9	-	790Z04000	1512	Washer - 1/2 Neoprene Backed Galvanized Steel	N
		10	-	791MR4000	52	WASHER - 1/2 RECESSED GALVANIZED STEEL	N
		11	-	795NR4000	52	WASHER - 1/2 NEOPRENE O RING	N
_		12	-	50-27-0304-08	128	WASHER - FLAT 1/2 304SS	N
4	QTY	13	-	751W00002	637	STRIP GASKET - 1 HOLE EPDM	N
\dashv	4	14	-	752W00012	49	GASKET RADIUS FILLET LIGHT EPDM 1RV	N
\dashv	10	15	-	753W00003	99	GASKET - CHIME LAP LIGHT EPDM	N
\dashv	4	16	-	753W00103	4	GASKET - CHIME LAP HEAVY BUMP EPDM	N
┥	122	17	-	375G14003	19	2 HL BOLT CHANNEL GALVANIZED	N
\dashv	122	18	-	375G14095	12	48 HL BOLT CHANNEL GALVANIZED	N
_		19	-	754W00136	2	MANHOLE GASKET 36 HL EPDM	N
		20	-	756A00000	4	MANUS BOND CAULK	N


HARDWARE LIST FOR TANK - DOMESTIC OVERAGE

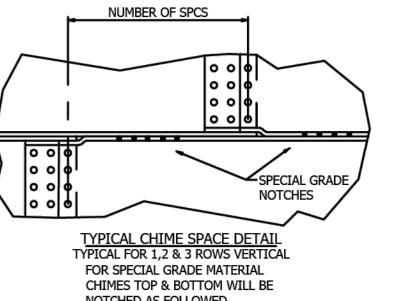



NOTCHED AS FOLLOWED. GRADE 50 - 1 NOTCH GRADE 55 - 2 NOTCHES GRADE 60 - 3 NOTCHES GRADE 65 - 4 NOTCHES GRADE 70 - 5 NOTCHES

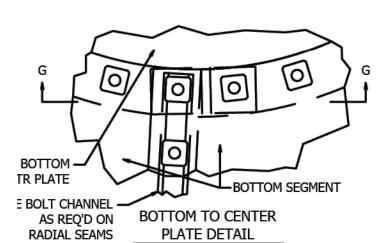


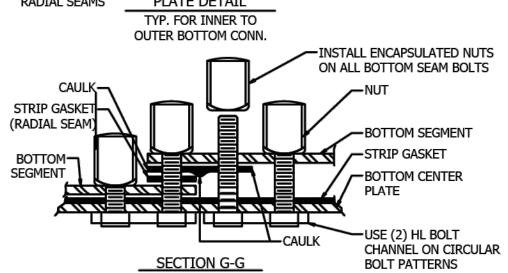

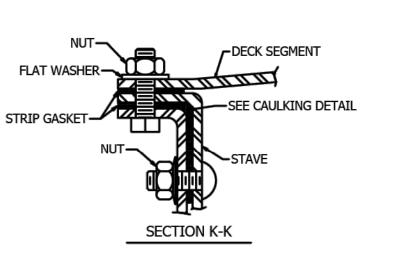


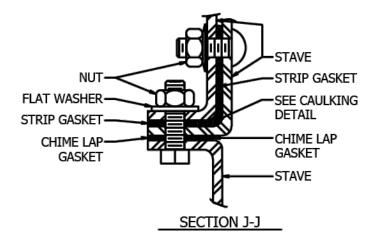

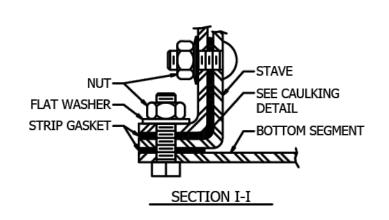


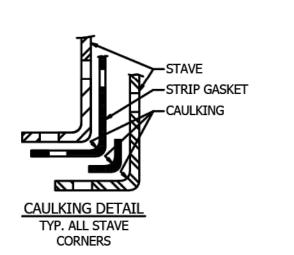

903 E 104TH ST. SUITE #900 KANSAS CITY, MISSOURI 64131

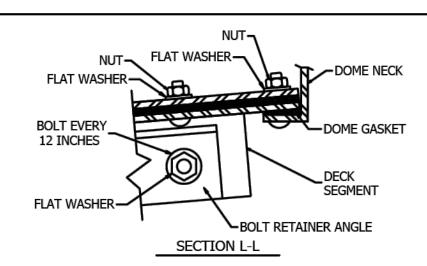

USE CHIME LAP GASKETS AT DECK SEAM LAPS AT CENTER DOME, APPLY CAULKING ALONG THE BUMP OF EACH CHIME LAP GASKET.

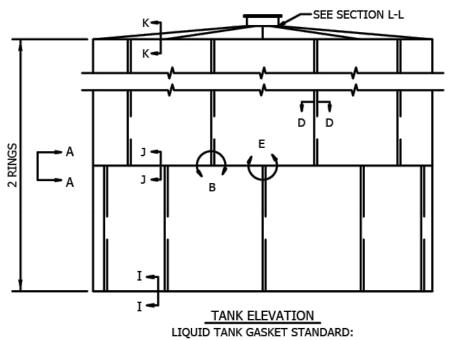

1 ROW VERTICAL: SINGLE PUNCH GASKET 2 ROW VERTICAL: DOUBLE PUNCH GASKET 3 ROW VERTICAL: TRIPLE PUNCH GASKET SUBSTITUTION:

SINGLE PUNCH GASKET (X 2) OR (X 3) MAY BE SUBSTITUTED FOR 2 ROW AND 3 ROW VERTICAL



11/20/23


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DESIGNED: A.R. / R.F.	No	DATE	REVISION	BY	APPROVED	
A.R. / R.F.						
DRAFTED: G.T. / T.Z. / R.I	=					
G.I./I.Z./R.I						
CHECKED:						STETSON
A.R.						

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TRINIDAD RANCHERIA WATER TREATMENT FACILITY PROJECT PHASE I

PART I - POTABLE WATER TANK	
CST TANK DETAILS	

TANK HARDWARE

UPDATED PER ECO-003586001-02 & ECO-003586001-RELEASED FOR FABRICATION

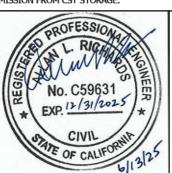PROJECT No.:

20-9502 918T018-209502C DWG No. JUNE 13, 2025 T-3 AS INDICATED SHEET No.

TANK HARDWARE 18'-5 1/2" DIA. x 18' HIGH TANK

TRINIDAD, CA, USA

2789-003

GENERAL NOTES:

- TANK DESIGN: AWWA D103-09
- 2. BUILDING CODE: CBC 2022 w ASCE 7-16
- CONCRETE DESIGN: 318-19
- RISK CATEGORY: 3
- ROOF SERVICE LIVE LOAD: 25 PSF
- WIND VELOCITY: 103 MPH
- EXPOSURE CATEGORY: C
- SEISMIC SHORT PERIOD ACCELERATION Ss = 271.00 %g
- SEISMIC 1 SEC PERIOD ACCELERATION S1 = 109.00 %g
- 10. SITE CLASS: C
- 11. SEISMIC DESIGN CATEGORY: E
- 12. TRANSITION PERIOD TL: 8.00
- 13. PROVIDE ½" MIN CANE FIBER JOINT FILLER PER ASTM D1751 BENEATH TANK BOTTOM ABOVE RINGWALL FOOTING PER AWWA D103-09.

FOUNDATION NOTES:

- 1. THE FOUNDATION SHALL BE CONSTRUCTED ACCORDING TO THE REQUIREMENTS OF SECTION 13 OF AWWA D103-09 FOR A TYPE 1 FOUNDATION (STEEL-BOTTOM TANKS SUPPORTED ON RINGWALLS).
- 2. THE SITE SHALL BE CLEARED OF ALL VEGETATION, ORGANIC MATERIALS, RUBBISH, DEBRIS, AND OTHER FOREIGN OR OBJECTIONABLE MATERIALS ABOVE THE GROUND SURFACE. REMOVE ALL TOP SOIL, STUMPS, LARGE ROOTS, BURIED LOGS, AND OTHER OBJECTIONABLE MATERIALS BELOW THE GROUND SURFACE.
- THE FOUNDATION DESIGN AND DRAWINGS ARE BASED ON THE RECOMMENDATIONS IN THE GEOTECHNICAL REPORT DATED OCTOBER 16, 2023 BY MILLER PACIFIC ENGINEERING GROUP, PROJECT NUMBER 960.109. THE RECOMMENDATIONS CONTAINED IN THAT REPORT AND ALL SUPPLEMENTAL REPORTS SHALL BE FOLLOWED.
- 4. NOT USED.

APPROVED

iem Huynh , 11/14/2023 ,5:17:07 Pl

Know what's **below**.

Call before you dig.

- SOIL BENEATH THE ENTIRE TANK AND FOUNDATION SHALL BE INSPECTED AND CERTIFIED BY A LICENSED GEOTECHNICAL ENGINEER PRIOR TO CONSTRUCTION OF THE FOUNDATION TO VERIFY THAT THE FOLLOWING CRITERIA HAVE BEEN MET. IF THE SOIL IS NOT VERIFIED, OR IF THE SOIL DOES NOT MEET ALL OF THESE CRITERIA, THE FOUNDATION DESIGN AND DRAWINGS SHALL BE NULL AND
- THE SOIL SHALL BE UNDISTURBED SOIL OR COMPACTED FILL.
- THE SOIL SHALL HAVE A MINIMUM ALLOWABLE BEARING CAPACITY OF 2500 PSF AT 2'-6" BELOW GRADE. ALL SOIL BENEATH THE ENTIRE TANK AND FOUNDATION SHALL MEET OR EXCEED THE MINIMUM BEARING CAPACITY.
- THE SOIL SHALL PROVIDE UNIFORM SUPPORT FOR THE ENTIRE FOUNDATION.
- THE SOIL SHALL BE SUITABLE IN ALL RESPECTS TO PROPERLY SUPPORT THE TANK.
- 6. THE SOILS SHALL BE INSPECTED AND CERTIFIED AS SUITABLE IMMEDIATELY PRIOR TO PLACING OF CONCRETE.
- 7. ALL COMPACTED FILL SHALL BE PLACED AS RECOMMENDED BY THE GEOTECHNICAL REPORT. IF NO COMPACTION IS


- SPECIFIED OR OTHERWISE DIRECTED BY THE ONSITE GEOTECHNICAL ENGINEER, ALL COMPACTED FILL SHALL BE PLACED IN LAYERS NOT EXCEEDING 6" IN LOOSE THICKNESS AND SHALL BE COMPACTED TO A MINIMUM DENSITY OF 95% OF THE MATERIAL'S MAXIMUM DRY DENSITY PER ASTM D698 OR ASTM D1557. IN THE EVENT OF CONFLICTS THE MOST STRINGENT SHALL APPLY.
- 8. NOT USED.
- 9. NOT USED.
- 10. NO WATER-SOLUBLE SULFATE TESTING AVAILABLE. CONTRACTOR TO INSURE THAT SOIL SULFATE LEVELS ARE NEGLIGIBLE OR SHALL UPGRADE CONCRETE IN CONTACT WITH SOILS AS NECESSARY.
- 11. IF CONDITIONS EXIST WHICH REQUIRE FOOTING AND/OR SLAB DESIGN DETAILS DIFFERING FROM THOSE SHOWN ON THE DRAWINGS, SUCH NEW DESIGN AND DETAILS SHALL BE PROVIDED BY THE OWNER OR THE OWNER'S DESIGNATED AGENT. CST STORAGE CANNOT SHOW DETAILS ON ITS DRAWINGS OTHER THAN THOSE DERIVED AS A RESULT OF THE DESIGN EFFORTS OF ITS OWN ENGINEERING DEPARTMENT.

CONCRETE NOTES:

- 1. RINGWALLS AND SLABS, BEFORE PLACING THE CANE JOINT FIBER FILLER, SHALL BE LEVEL WITHIN +/- 1/8" IN ANY 30 FT CIRCUMFERENCE UNDER THE SHELL. THE LEVELNESS OF THE CIRCUMFERENCE SHALL NOT VARY BY MORE THAN +/- 1/4" FROM AN ESTABLISHED PLANE.
- CONCRETE WORK SHALL CONFORM TO THE REQUIREMENTS OF ACI 301-16 EXCEPT AS MODIFIED BY THE SUPPLEMENTAL REQUIREMENTS NOTED BELOW.
- 3. CONCRETE SHALL ATTAIN AN ULTIMATE 28-DAY COMPRESSIVE STRENGTH (F'C) OF 4,000 PSI.
- 4. REINFORCING BARS SHALL CONFORM TO ASTM A615, GRADE 60. WELDING OF BARS IS NOT PERMITTED. FIELD BENDING OF PARTIALLY EMBEDDED REINFORCING BARS SHALL CONFORM TO SECTION 3.3.2.8 OF ACI 301-16
- CEMENT SHALL CONFORM TO ASTM C150, TYPE 2 WITH AIR ENTRAINING ADMIXTURE PER ASTM C260 ADDED AT THE MIXER TO ACHIEVE 4%±2% BY VOLUME OF ENTRAINED AIR AT THE POINT OF CONCRETE PLACEMENT.
- MAXIMUM WATER CEMENT RATIO: 0.45
- MAXIMUM AGGREGATE SIZE SHALL BE 11/2". FINE AND COARSE AGGREGATES SHALL CONFORM TO ASTM C33. AND THE RESTRICTIONS ON REACTIVE MATERIALS SPECIFIED IN ASTM C33, PARAGRAPHS 7.3 AND 11.2, SHALL APPLY.
- READY MIX CONCRETE SHALL CONFORM TO ASTM C94, OPTION A. THE SUPPLIER SHALL BE RESPONSIBLE FOR DETERMINING THE PROPORTIONS USED IN THE CONCRETE
- EARTH CUTS MAY BE USED AS FORMWORK FOR FOOTINGS ONLY, PROVIDED THE FOOTING DEPTH DOES NOT EXCEED
- 10. THE FOLLOWING SECTIONS OF ACI 301-16 DO NOT APPLY: ARCHITECTURAL CONCRETE, LIGHTWEIGHT CONCRETE, MASS CONCRETE, PRESTRESSED CONCRETE, AND SHRINKAGE—COMPENSATING CONCRETE.
- 11. MINIMUM COVER FOR REINFORCING STEEL SHALL BE 3" CLEAR UNLESS NOTED OTHERWISE.
- 12. ALL REINFORCING SHALL BE BENT COLD.

- 13. LAP SPLICES OF REINFORCING STEEL SHALL BE PER THE REBAR SPLICE SCHEDULE UNLESS NOTED OTHERWISE. MINIMUM STAGGER OF SPLICES SHALL BE THE GREATER OF ONE LAP LENGTH OR 24".
- 14. FABRICATE AND PLACE REINFORCEMENT IN ACCORDANCE WITH THE CRSI MANUAL OF STANDARD PRACTICE.
- 15. ALL BENDS SHALL BE ACI STANDARD HOOKS. TIES AND STIRRUPS SHALL USE ACI STIRRUP AND TIE HOOKS UNLESS OTHERWISE NOTED.



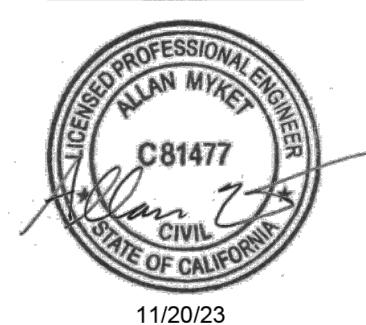

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ANY MANNER WITHOUT WRITTEN PERMISSION FROM CST STORAGE

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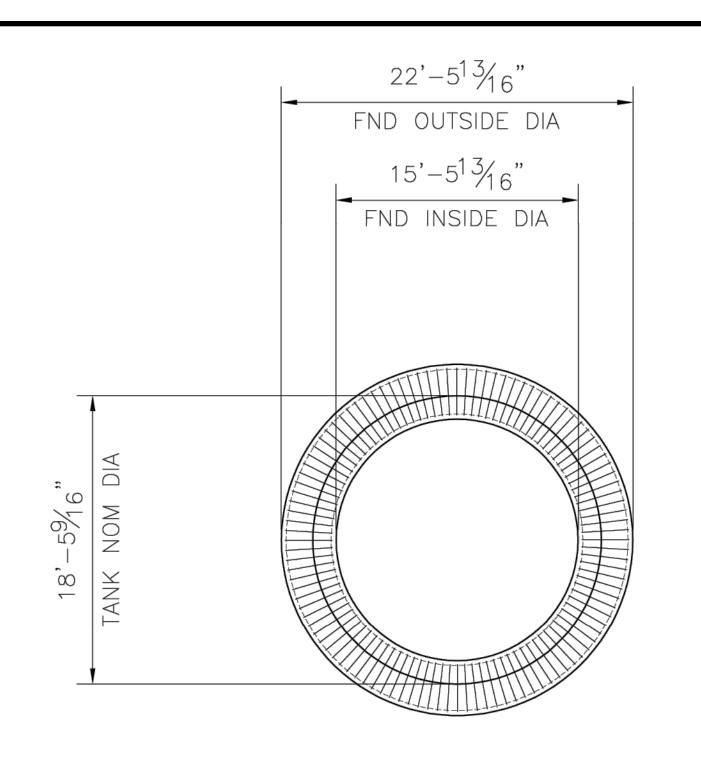



TRINIDAD RANCHERIA WATER TREATMENT FACILITY PROJECT PHASE I

PART I - POTABLE WATER TANK **CST FOUNDATION NOTES**

DWG No. JUNE 13, 2025 T-4 NO SCALE SHEET No. PROJECT No.: 13 OF 48

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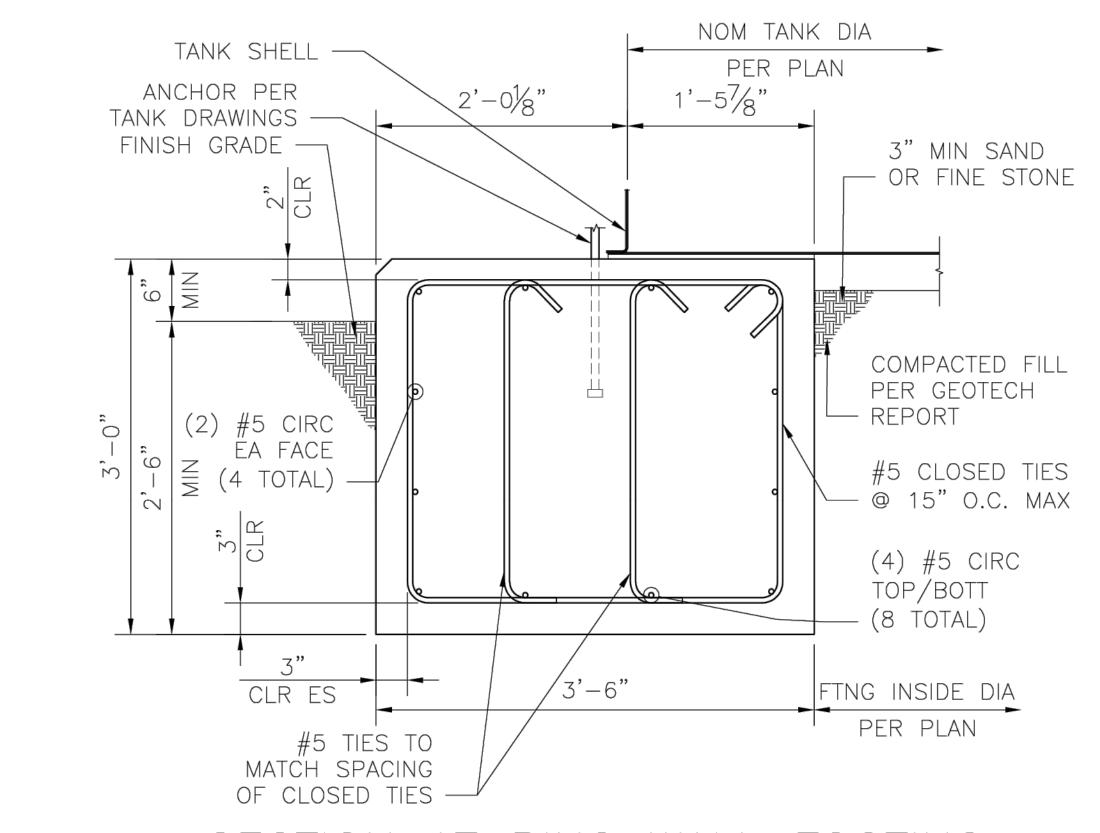


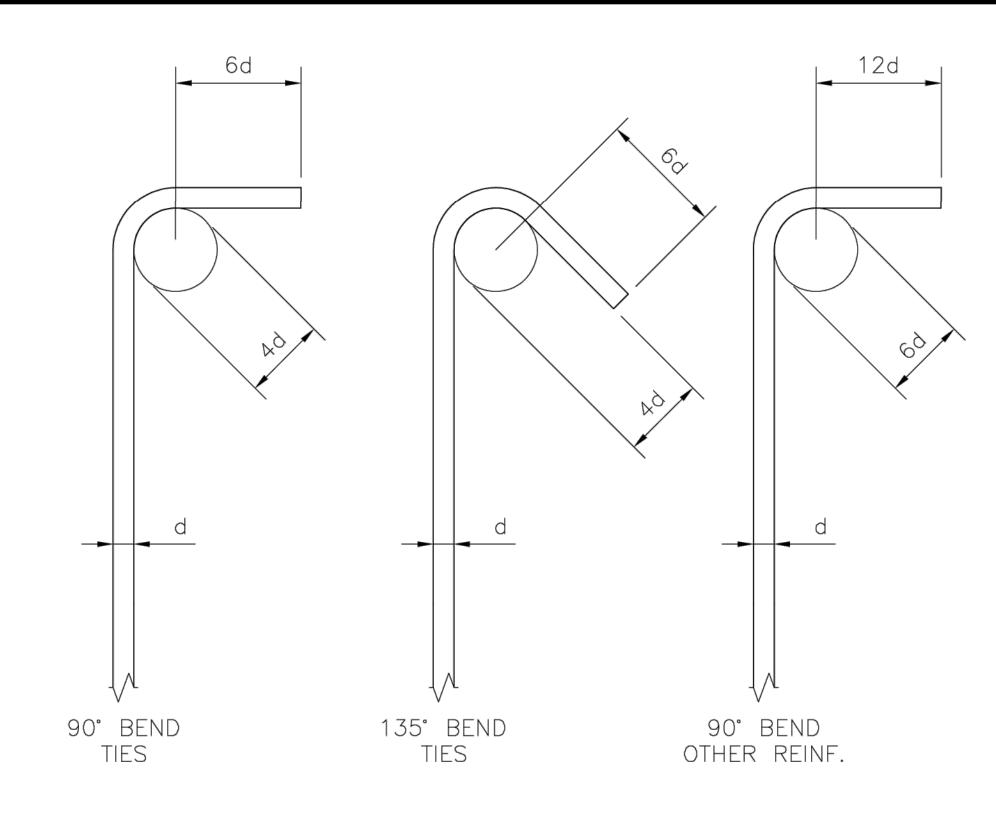

REBAR SPL	ICE SCHEDULE		
REBAR SIZE	SPLICE LENGTH		
#4	32"		
#5	40"		
#6	48"		
#7	70"		
#8	80"		

FOUNDATION PLAN

STANDARD HOOKS



SECTION AT RING WALL FOOTING





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Stetson Engineers Inc. 2171 E. Francisco Blvd., Suite K San Rafael, CA. 94901 (415) 457-0701



TRINIDAD RANCHERIA WATER TREATMENT FACILITY PROJECT PHASE I

PART I - POTABLE WATER TANK

DATE:	DWG No.
JUNE 13, 2025	T-5
SCALE:	
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PROJECT No.:	

CST FOUNDATION PLAN AND DETAILS

T-5 SHEET No. 14 OF 48

CHER-AE HEIGHTS INDIAN COMMUNITY OF THE TRINIDAD RANCHERIA - CALIFORNIA

FUNDED BY CALIFORNIA DEPARTMENT OF WATER RESOURCES, UNDER THE SMALL COMMUNITY DROUGHT RELIEF PROGRAM

PART II - WATER TREATMENT FACILITY

GENERAL NOTES

- I. PRIOR TO START OF ANY PHASE II (WATER TREATMENT FACILITY) WORK AT THE PROJECT SITE. THE CONTRACTOR SHALL NOTIFY TRINIDAD RANCHERIA'S REPRESENTATIVE AND, THE PROJECT ENGINEER, STETSON ENGINEERS INC., ATTN: ALLAN RICHARDS (415) 457-0701 / ALLANR@STETONENGINEERS.COM, TO ALLOW PROPER COORDINATION AND NOTIFICATION TO THE TRINIDAD RANCHERIA AND PROPERTY OWNERS.
- 2. THE PROJECT'S PART II WATER TREATMENT FACILITY (WTF) WORK SHALL CONSIST OF SITE PREPARATION, COMPLETE CONSTRUCTION OF 44 L S.F. BUILDING, AND A NEW TANK FARM TO HOUSE THREE (3) 4,600-GAL. TANKS. THE NEW WTF BUILDING SHALL INCLUDE COMPLETE INSTALLATION OF NEW WATER TREATMENT EQUIPMENT (DELIVERED AND INSTALLED BY OTHERS), ELECTRICAL, ASSOCIATED PIPING, AND CONNECTIONS. THE COMPLETED WORK OF THE WTF WILL INCLUDE SITE PIPING, UTILITIES, GRADING, PAVING, AND HYDROSTATIC PRESSURE TEST AND DISINFECTION OF ALL PIPE.
- 3. WATER TREATMENT EQUIPMENT, PRE-PURCHASED FROM TRINIDAD RANCHERIA, SHALL BE DELIVERED AND INSTALLED BY PUREFLOW FILTRATION DIVISION.
- 4. CONTRACTOR IS RESPONSIBLE FOR COORDINATION WITH PUREFLOW FILTRATION DIVISION REPRESENTATIVE DURING PART II CONSTRUCTION FOR WATER TREATMENT EQUIPMENT AND ALL NECESSARY ELECTRICAL AND PLUMBING CONNECTIONS TO ALLOW WATER TREATMENT EQUIPMENT TO BE FULLY OPERATIONAL. ALL CONNECTING PIPING. CONDUIT. WIRE. ETC.. SHALL BE PURCHASED AND INSTALLED BY THE CONTRACTOR. TREATMENT EQUIPMENT CONNECTING PIPING, CONDUIT, WIRE, ETC., DEFINED THE LIMITS OF PIPING. MAY BE DEFINED BY SHOP DRAWINGS PROVIDED BY WATER TREATMENT EQUIPMENT VENDOR. ALL ADDITIONAL MATERIALS REQUIRED BY THE PROJECT MANUAL AND CONTRACT DRAWINGS ARE REQUIRED FOR A FULLY OPERATIONAL WATER TREATMENT SYSTEM SHALL BE PURCHASED AND INSTALLED BY THE CONTRACTOR.
- 5. THE CONTRACTOR SHALL ADHERE TO ALL PERTINENT SECTIONS OF THE INTERNATIONAL BLOCK CONSTRUCTION, WOODEN ROOF AND TRUSS SYSTEMS, AND CONNECTIONS BETWEEN CONCRETE BLOCK CONSTRUCTION ITEMS AND WOODEN ROOF/TRUSS SYSTEMS.
- 6. THE PROJECT WORK SHALL ALSO CONSIST OF INSTALLING PIPE THAT WILL CONNECT WITH OFF-SITE PIPING DURING PART III - DISTRIBUTION PIPELINES. PIPING SHALL BE FLANGED CAPPED FOR FUTURE CONNECTION AT THE FOLLOWING LOCATIONS: ONE (1) RAW WATER TIE-IN CONNECTION NEAR THE NORTH-EAST SIDE OF THE PROJECT SITE. PLEASE SEE PLANS FOR APPROXIMATE CONNECTION LOCATIONS. EXACT CONNECTION LOCATIONS SHALL BE DETERMINED IN THE FIELD.
- 7. ALL PIPING SHALL BE INSTALLED BY OPEN-CUT TRENCH METHOD OVER EXISTING UNIMPROVED AREAS. INCLUDING PIPE BEDDING. INSTALLATION OF FITTINGS AND AS-NEEDED VALVES. AND APPURTENANCES.
- 8. THE CONTRACTOR SHALL NOTIFY USA NORTH 811 AT WWW.USANORTH811.ORG. AT LEAST TWO (2) WORKING DAYS NOT INCLUDING DAY OF NOTIFICATION. WHICHEVER IS LATER. HAS PASSED AND ALL NOTIFIED UTILITY MEMBERS HAVE POSITIVELY RESPONDED TO REQUEST.
- 9. IT IS THE RESPONSIBILITY OF THE CONTRACTOR TO PERFORM UTILITY EXPLORATION TO VERIFY LOCATIONS OF EXISTING UTILITIES (INCLUDING BUT NOT LIMITED TO, GAS PIPELINES EXISTING WATER PIPELINES, ELECTRICAL, CABLE, AND TELECOMMUNICATIONS UTILITIES, BURIED OR ABOVE GROUND) BY POT-HOLING OR OTHER MEANS, AND PROTECT UTILITIES IN PLACE. CONTRACTOR SHALL REPORT TO THE ENGINEER ANY DISCREPANCIES FOUND OR ANY DETAILS NOT SHOWN ON THE DRAWINGS. EXPLORATORY EXCAVATIONS SHALL BE PERFORMED BY THE CONTRACTOR BEFORE THE SUBMITTAL OF SHOP DRAWINGS FOR THE PIPE AND SPECIAL PIPE SECTIONS.

- 10. THIS PLAN DOES NOT AUTHORIZE ANY WORK WITHIN PUBLIC / PRIVATE RIGHT-OF-WAYS WITHOUT REQUIRED APPROVALS AND / OR PERMITS. CONTRACTOR SHALL WORK WITH TRINIDAD RANCHERIA TO OBTAIN PROPER APPROVAL(S) AND/OR PERMIT(S) AND SHALL SUBMIT TO TRINIDAD RANCHERIA AND PROJECT ENGINEER ALL APPROVAL(S) / PERMIT(S) WITH START OF WORK NOTIFICATION.
- II. THE LOCATION OF THE EXISTING WATER PIPELINES FOR TIE-INS ARE APPROXIMATED IN THESE DRAWINGS AND IT IS THE CONTRACTOR'S RESPONSIBILITY TO IDENTIFY ACTUAL LOCATIONS AND ALIGNMENT OF EXISTING WATER PIPELINES PRIOR TO START OF THE WORK. THE CONTRACTOR IS RESPONSIBLE FOR ANY DAMAGE TO EXISTING UTILITIES.
- 12. ALL WORK DETAILED HEREIN SHALL BE CONSTRUCTED IN ACCORDANCE WITH THE CONTRACT DOCUMENTS. IN THE CASE OF DISCREPANCY OR AMBIGUITY IN CONTRACT DOCUMENTS AND THIS SET OF DRAWINGS, THE CONTRACTOR IS REFERRED TO DOCUMENT 00700 - GENERAL CONDITIONS ARTICLE 5.7 - PRECEDENCE OF DOCUMENTS OF THE PROJECT MANUAL.
- 13. STRUCTURAL DIMENSIONS CONTROLLED BY OR RELATED TO MECHANICAL OR ELECTRICAL EQUIPMENT SHALL BE VERIFIED BY THE CONTRACTOR AGAINST THE APPROVED EQUIPMENT SUBMITTAL PRIOR TO CONSTRUCTION.
- 14. MECHANICAL AND ELECTRICAL EQUIPMENT SUPPORTS, ANCHORAGES, OPENINGS, RECESSES AND REVEALS NOT SHOWN ON THE PLANS BUT REQUIRED BY OTHER CONTRACT DRAWINGS OR APPROVED SUBMITTALS SHALL BE PROVIDED FOR PRIOR TO PLACING CONCRETE.
- 15. NO REVISIONS SHALL BE MADE TO THESE DRAWINGS WITHOUT THE APPROVAL OF THE PROJECT ENGINEER AND THE TRINIDAD RANCHERIA.
- 16. ANY DATA AND INFORMATION PROVIDED BY THE TRINIDAD RANCHERIA ARE FOR THE CONTRACTOR'S INFORMATION ONLY. ANY INTERPRETATIONS OR CONCLUSIONS DRAWN BY THE CONTRACTOR FROM THEM SHALL BE THE RESPONSIBILITY OF THE CONTRACTOR.
- 17. DURING CONSTRUCTION. THE STRUCTURES INSTALLED SHALL BE PROTECTED BY BRACING AND BALANCING WHEREVER EXCESSIVE CONSTRUCTION LOADS MAY OCCUR.
- 18. THE CONTRACTOR SHALL TAKE PRECAUTIONARY MEASURES TO PROTECT EXISTING STRUCTURES, UTILITIES, FENCING, ETC., FROM DAMAGE. CONTRACTOR SHALL BEAR SOLE RESPONSIBILITY FOR ANY DAMAGE TO SUCH FACILITIES.
- 19. CIVIL DRAWINGS WHERE STRUCTURES ARE PROVIDED SHALL BE USED IN COORDINATION WITH OTHER CIVIL OR ELECTRICAL DRAWINGS, AND SHOP DRAWINGS PROVIDED BY MANUFACTURERS OF EQUIPMENT.
- 20. THE CONTRACTOR SHALL EXERCISE CARE AND SAFETY WHEN WORKING NEAR EXISTING UTILITIES ON SITE INCLUDING EXISTING WATER MAINS AND APPURTENANCES. AND ELECTRICAL UTILITIES, AND SHALL BE FULLY RESPONSIBLE FOR ANY DAMAGE. BREAKAGE. OR LEAKS CAUSED BY THE CONTRACTOR'S WORK.
- 21. THE CONTRACTOR SHALL RESTORE THE GROUND SURFACE OF EXCAVATED AREAS TO ORIGINAL GRADE AS REASONABLY POSSIBLE UNLESS OTHERWISE SHOWN OR DIRECTED.
- 22. THE CONTRACTOR SHALL TAKE PRECAUTIONARY MEASURES TO PROTECT EXISTING UTILITIES, STRUCTURES, FENCING, ETC. FROM DAMAGE. CONTRACTOR SHALL BEAR SOLE RESPONSIBILITY FOR ANY DAMAGE TO SUCH FACILITIES.
- 23. THE ENGINEER HAS, BY SEARCH OF KNOWN RECORDS, ENDEAVORED TO LOCATE AND INDICATE ON THE PLANS ALL THE UTILITIES WHICH EXIST WITHIN THE LIMITS OF THE WORK. HOWEVER, THE ACCURACY OR COMPLETENESS OF THE UTILITIES ON THE DRAWINGS IS NOT GUARANTEED.
- 24. STATIONS SHOWN ON THE DRAWINGS ARE ALONG OR ON A LINE NORMAL OR RADIAL TO THE CENTER LINE OF THE WATER LINE.

- 25. ALL BURIED STEEL AND IRON PIPE FITTINGS AND VALVES SHALL BE COATED AS INDICATED AND DOUBLE WRAPPED WITH 4-MIL HIGH DENSITY POLYETHYLENE.
- 26. ALL WATER LINES SHALL HAVE A MINIMUM OF THIRTY (30") INCHES OF COVER OR HAVE SUFFICIENT INSULATION TO PREVENT FREEZING. UNLESS OTHERWISE SHOWN. ALL WATER LINES SHALL MAINTAIN A TEN (10') FOOT HORIZONTAL AND ONE (1') VERTICAL (ABOVE) SEPARATION FROM SEWER AND RAW WATER PIPELINES.
- 27. ALL BURIED VALVES SHALL BE INSTALLED WITHIN A VALVE BOX AND VALVE STEM
- 28. WATER LINES SHALL BE PRESSURE TESTED AND DISINFECTED PER THE AWWA STANDARDS PRIOR TO PLACING THE NEW WATER PIPELINE INTO SERVICE.

SURVEY CONTROL NOTES

- I. FIELD SURVEY FOR TOPOGRAPHIC PURPOSES WAS PERFORMED BY TOLS ON 8/3/2023 \$ 11/1/2023. NO LIABILITY IS ASSUMED BY TOLS FOR THE EXISTENCE OF SUBSURFACE FEATURES, IF ANY EXIST.
- 2. VERTICAL AND HORIZONTAL DATUMS ARE ASSUMED
- 3. A BOUNDARY SURVEY WAS NOT CONDUCTED BY TVCE. NO LIABILITY IS ASSUMED BY TVCE FOR FOR TITLE DEFECTS OR ENCUMBRANCES, IF ANY EXIST.
- 4. PROPERTY LINES SHOWN HEREIN ARE PER BOOK 23 OF SURVEYS, PAGE 82, HUMBOLDT COUNTY RECORDS. AS EVIDENCED BY FOUND MONUMENTS.

CULTURAL MONITORING

- I. CULTURAL MONITORING IS REQUIRED UNDER THIS PROJECT AND CONTRACT AGREEMENT FOR ANY GROUND DISTURBING ACTIVITIES. DURING CONSTRUCTION, THE CONTRACTOR IS TO ADHERE TO THE REQUIREMENTS OF THE TRINIDAD RANCHERIA THPO AND CULTURAL MONITOR IN THE EVEN OF DISCOVERY OF SENSITIVE ITEMS AS DEFINED AND EXPLAINED HEREIN
- 2. IT IS THE RESPONSIBILITY OF THE CONTRACTOR TO NOTIFY THE RANCHERIA SEVENTY-TWO (72) HOURS PRIOR TO CONDUCTING GROUND DISTURBANCE
- 3. CONTRACTOR IS RESPONSIBLE FOR ALL COORDINATION WITH TRINIDAD RANCHERIA THPO TO ENSURE A TRINIDAD RANCHERIA CULTURAL MONITOR IS AVAILABLE DURING ANY GROUND DISTURBANCE ACTIVITIES.

Know what's **below**. **Call** before you dig.

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TRINIDAD RANCHERIA WATER TREATMENT FACILITY PROJECT PHASE I

GENERAL NOTES; SURVEY NOTES; AND CULTURAL

MONITORING

PART II - WATER TREATMENT FACILITY DATE: JUNE 13, 2025 AS INDICATED

PROJECT No.:

G-5 SHEET No.

DWG No.

5 OF 48 2789-003

CHER-AE HEIGHTS INDIAN COMMUNITY OF THE TRINIDAD RANCHERIA - CALIFORNIA


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PART II - WATER TREATMENT FACILITY


ABBREVIATIONS

ASBESTOS - CEMENT PIPE APPROX APPROXIMATED CENTER LINE CONC CONCRETE CTS CATHODIC TEST STATION CY CUBIC YARDS DI DUCTILE IRON DIAMETER DIAM DUCTILE IRON PIPE DIP EXISTING ELECTRIC EG EXISTING GROUND ELEVATION FLANGE FL FEET GALV GALVANIZED IN INCHES LENGTH MAX MAXIMUM MINIMUM MISCELLANEOUS MISC MECHANICAL JOINT MJ (N) NOM NOMINAL NTS NOT TO SCALE NO. NUMBER O.C. ON CENTER PW POTABLE WATER RADIUS REQ'D REQUIRED SQ.FT. / S.F. SQUARE FEET STAINLESS STEEL STD. STANDARD TBD TO BE DETERMINED T.R. CHER-AE HEIGHTS INDIAN COMMUNITY OF THE TRINIDAD RANCHERIA TYP TYPICAL WATER W/ WATER TREATMENT FACILITY DEGREES FEET OR MINUTES INCHES OR SECONDS

REFERENCE



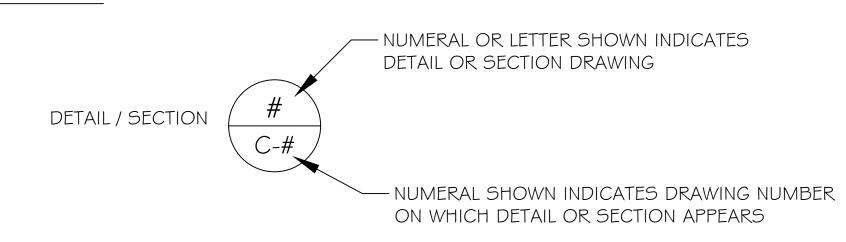

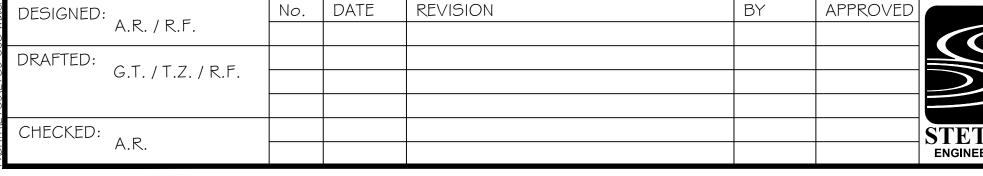




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TRINIDAD RANCHERIA WATER TREATMENT FACILITY PROJECT PHASE I

PART II - WATER TREATMENT FACILITY	_ (
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PROJECT No.: 2789-003

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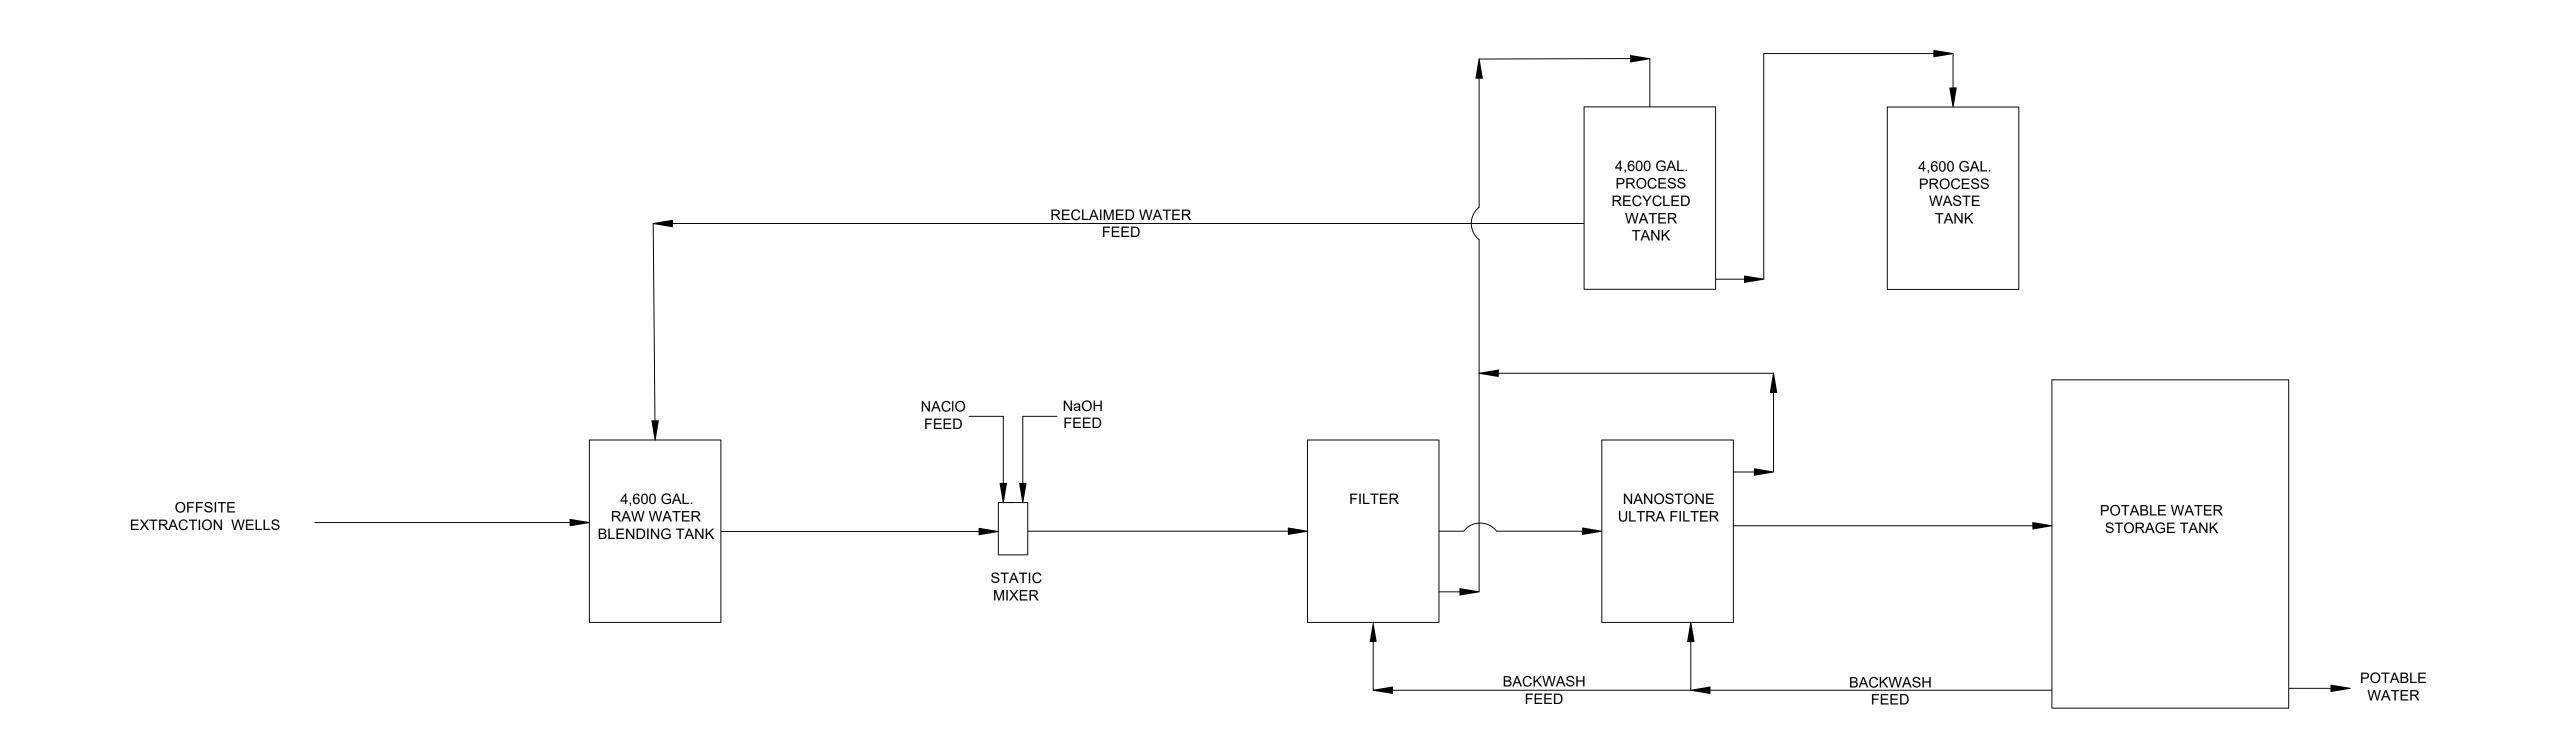
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CHER-AE HEIGHTS INDIAN COMMUNITY OF THE TRINIDAD RANCHERIA - CALIFORNIA

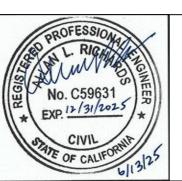FUNDED BY CALIFORNIA DEPARTMENT OF WATER RESOURCES, UNDER THE SMALL COMMUNITY DROUGHT RELIEF PROGRAM

PART II - WATER TREATMENT FACILITY





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TRINIDAD RANCHERIA
WATER TREATMENT FACILITY PROJECT
PHASE I

PART II - WATER TREATMENT FACILITY

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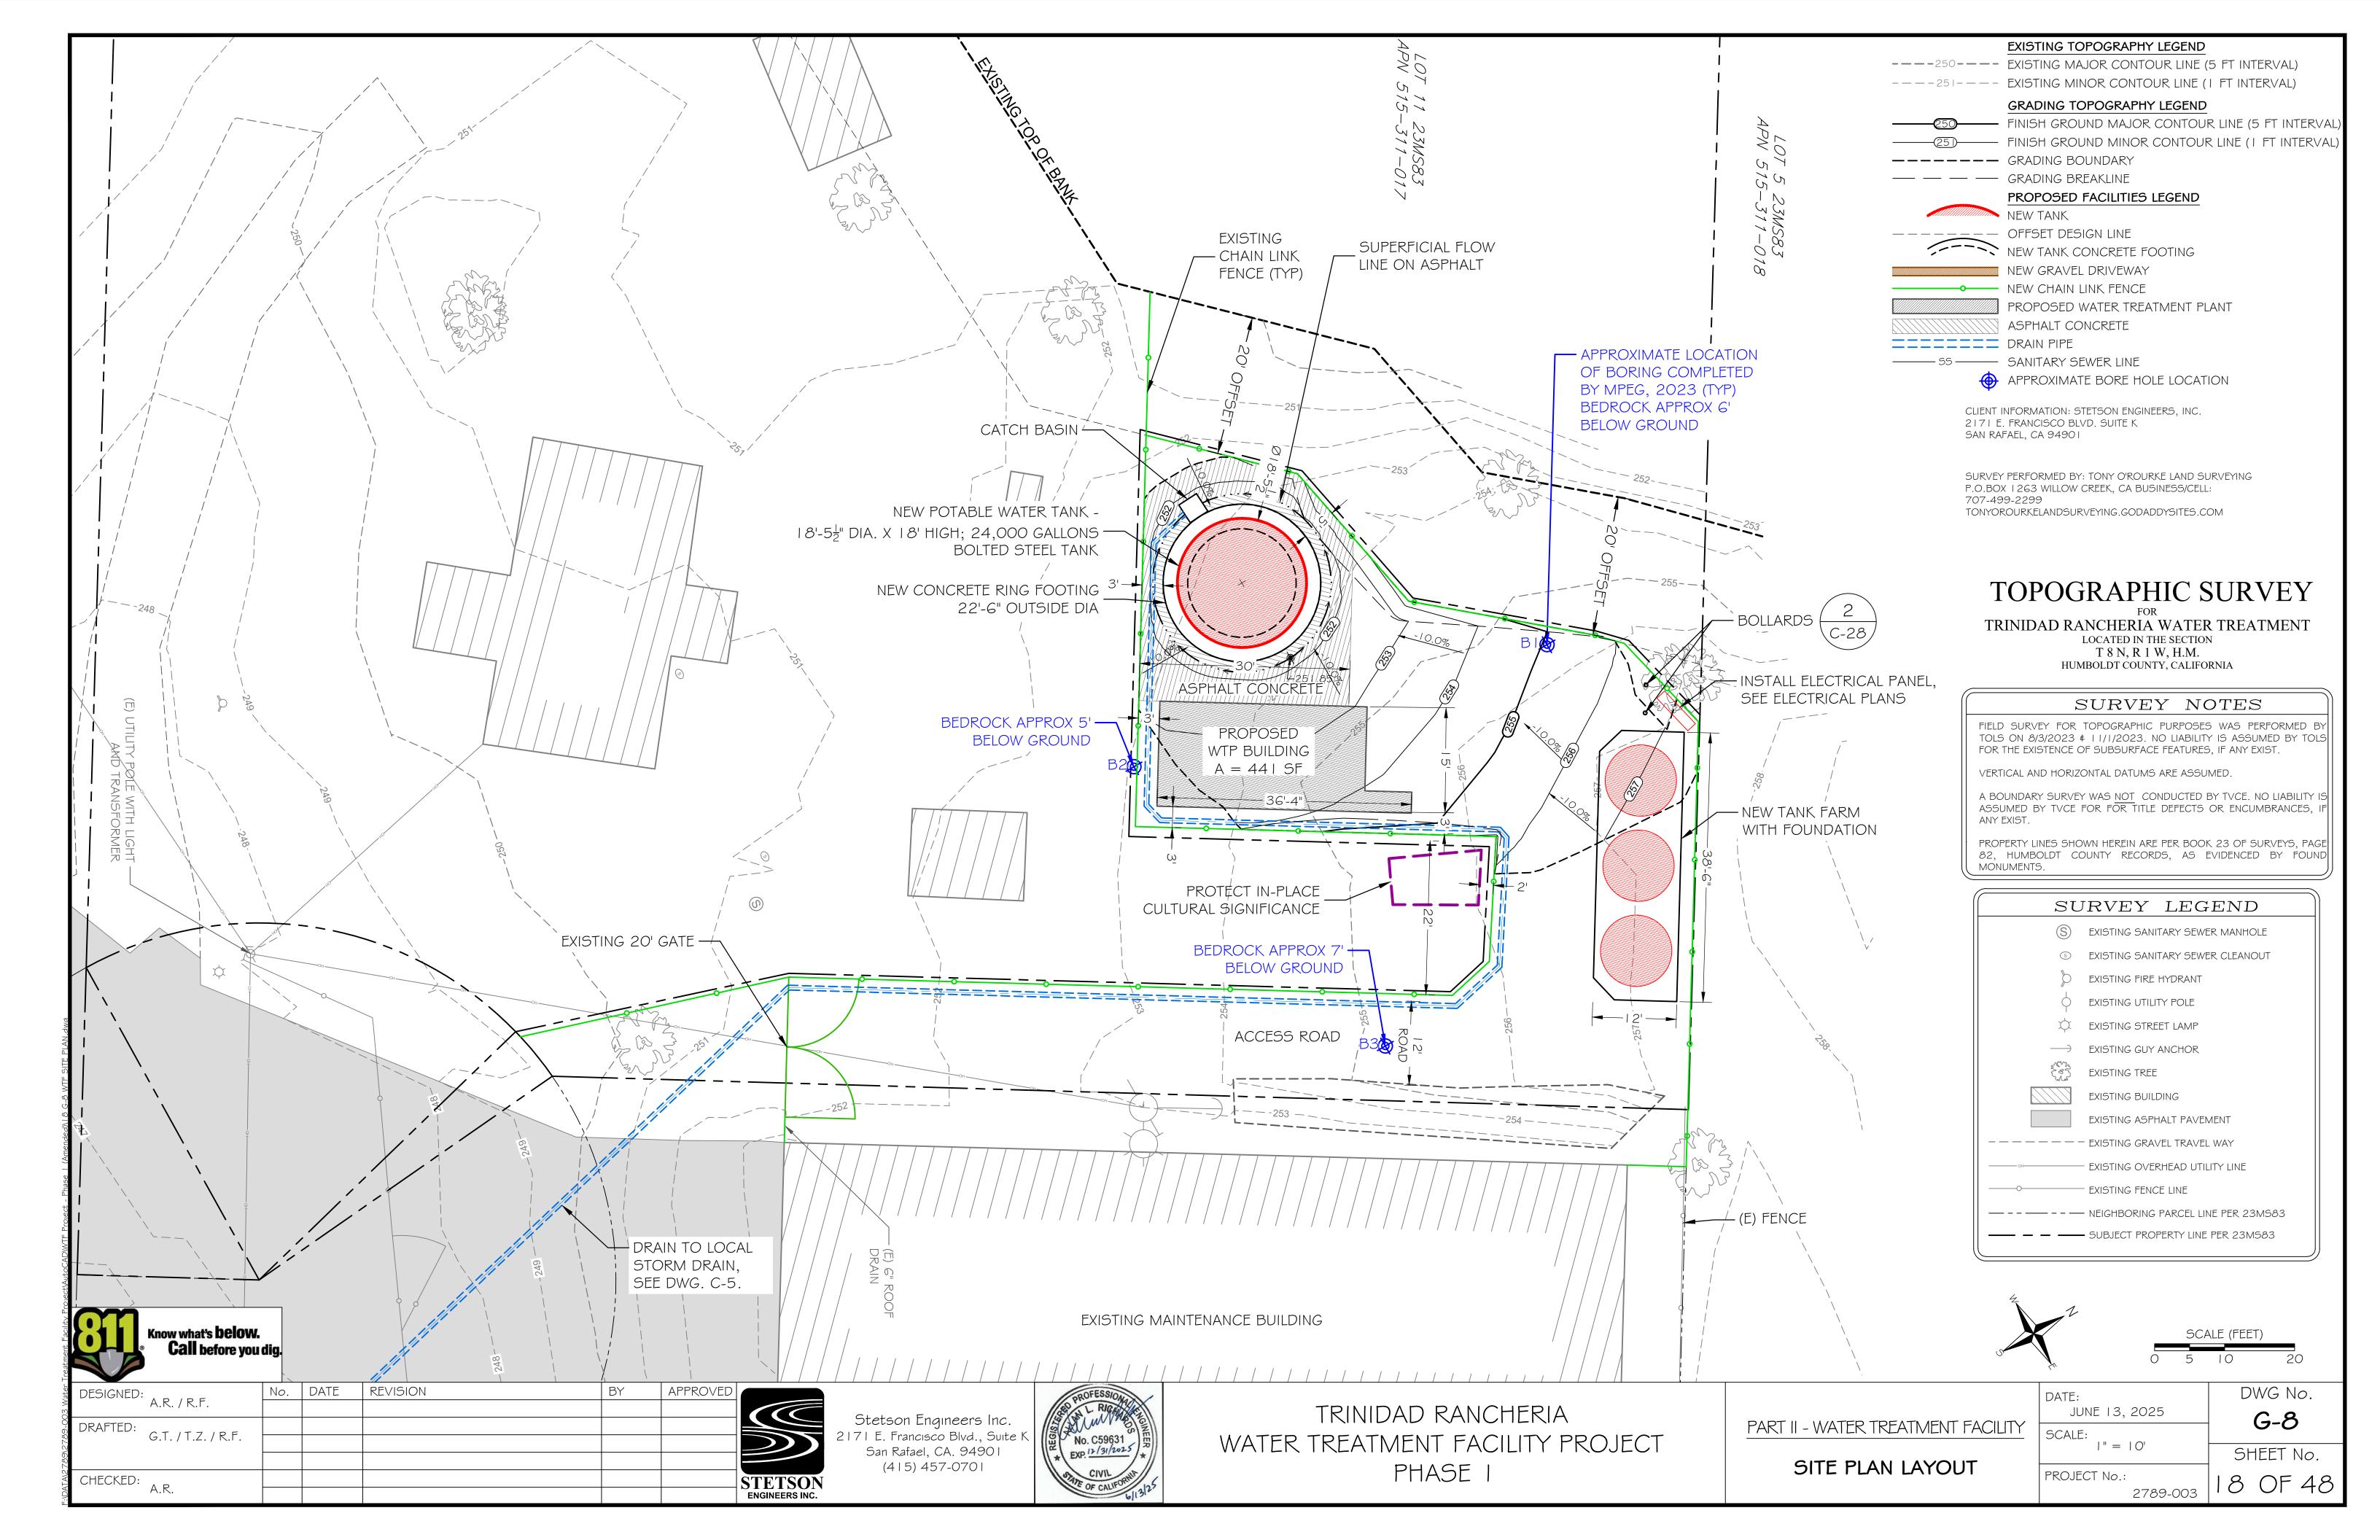
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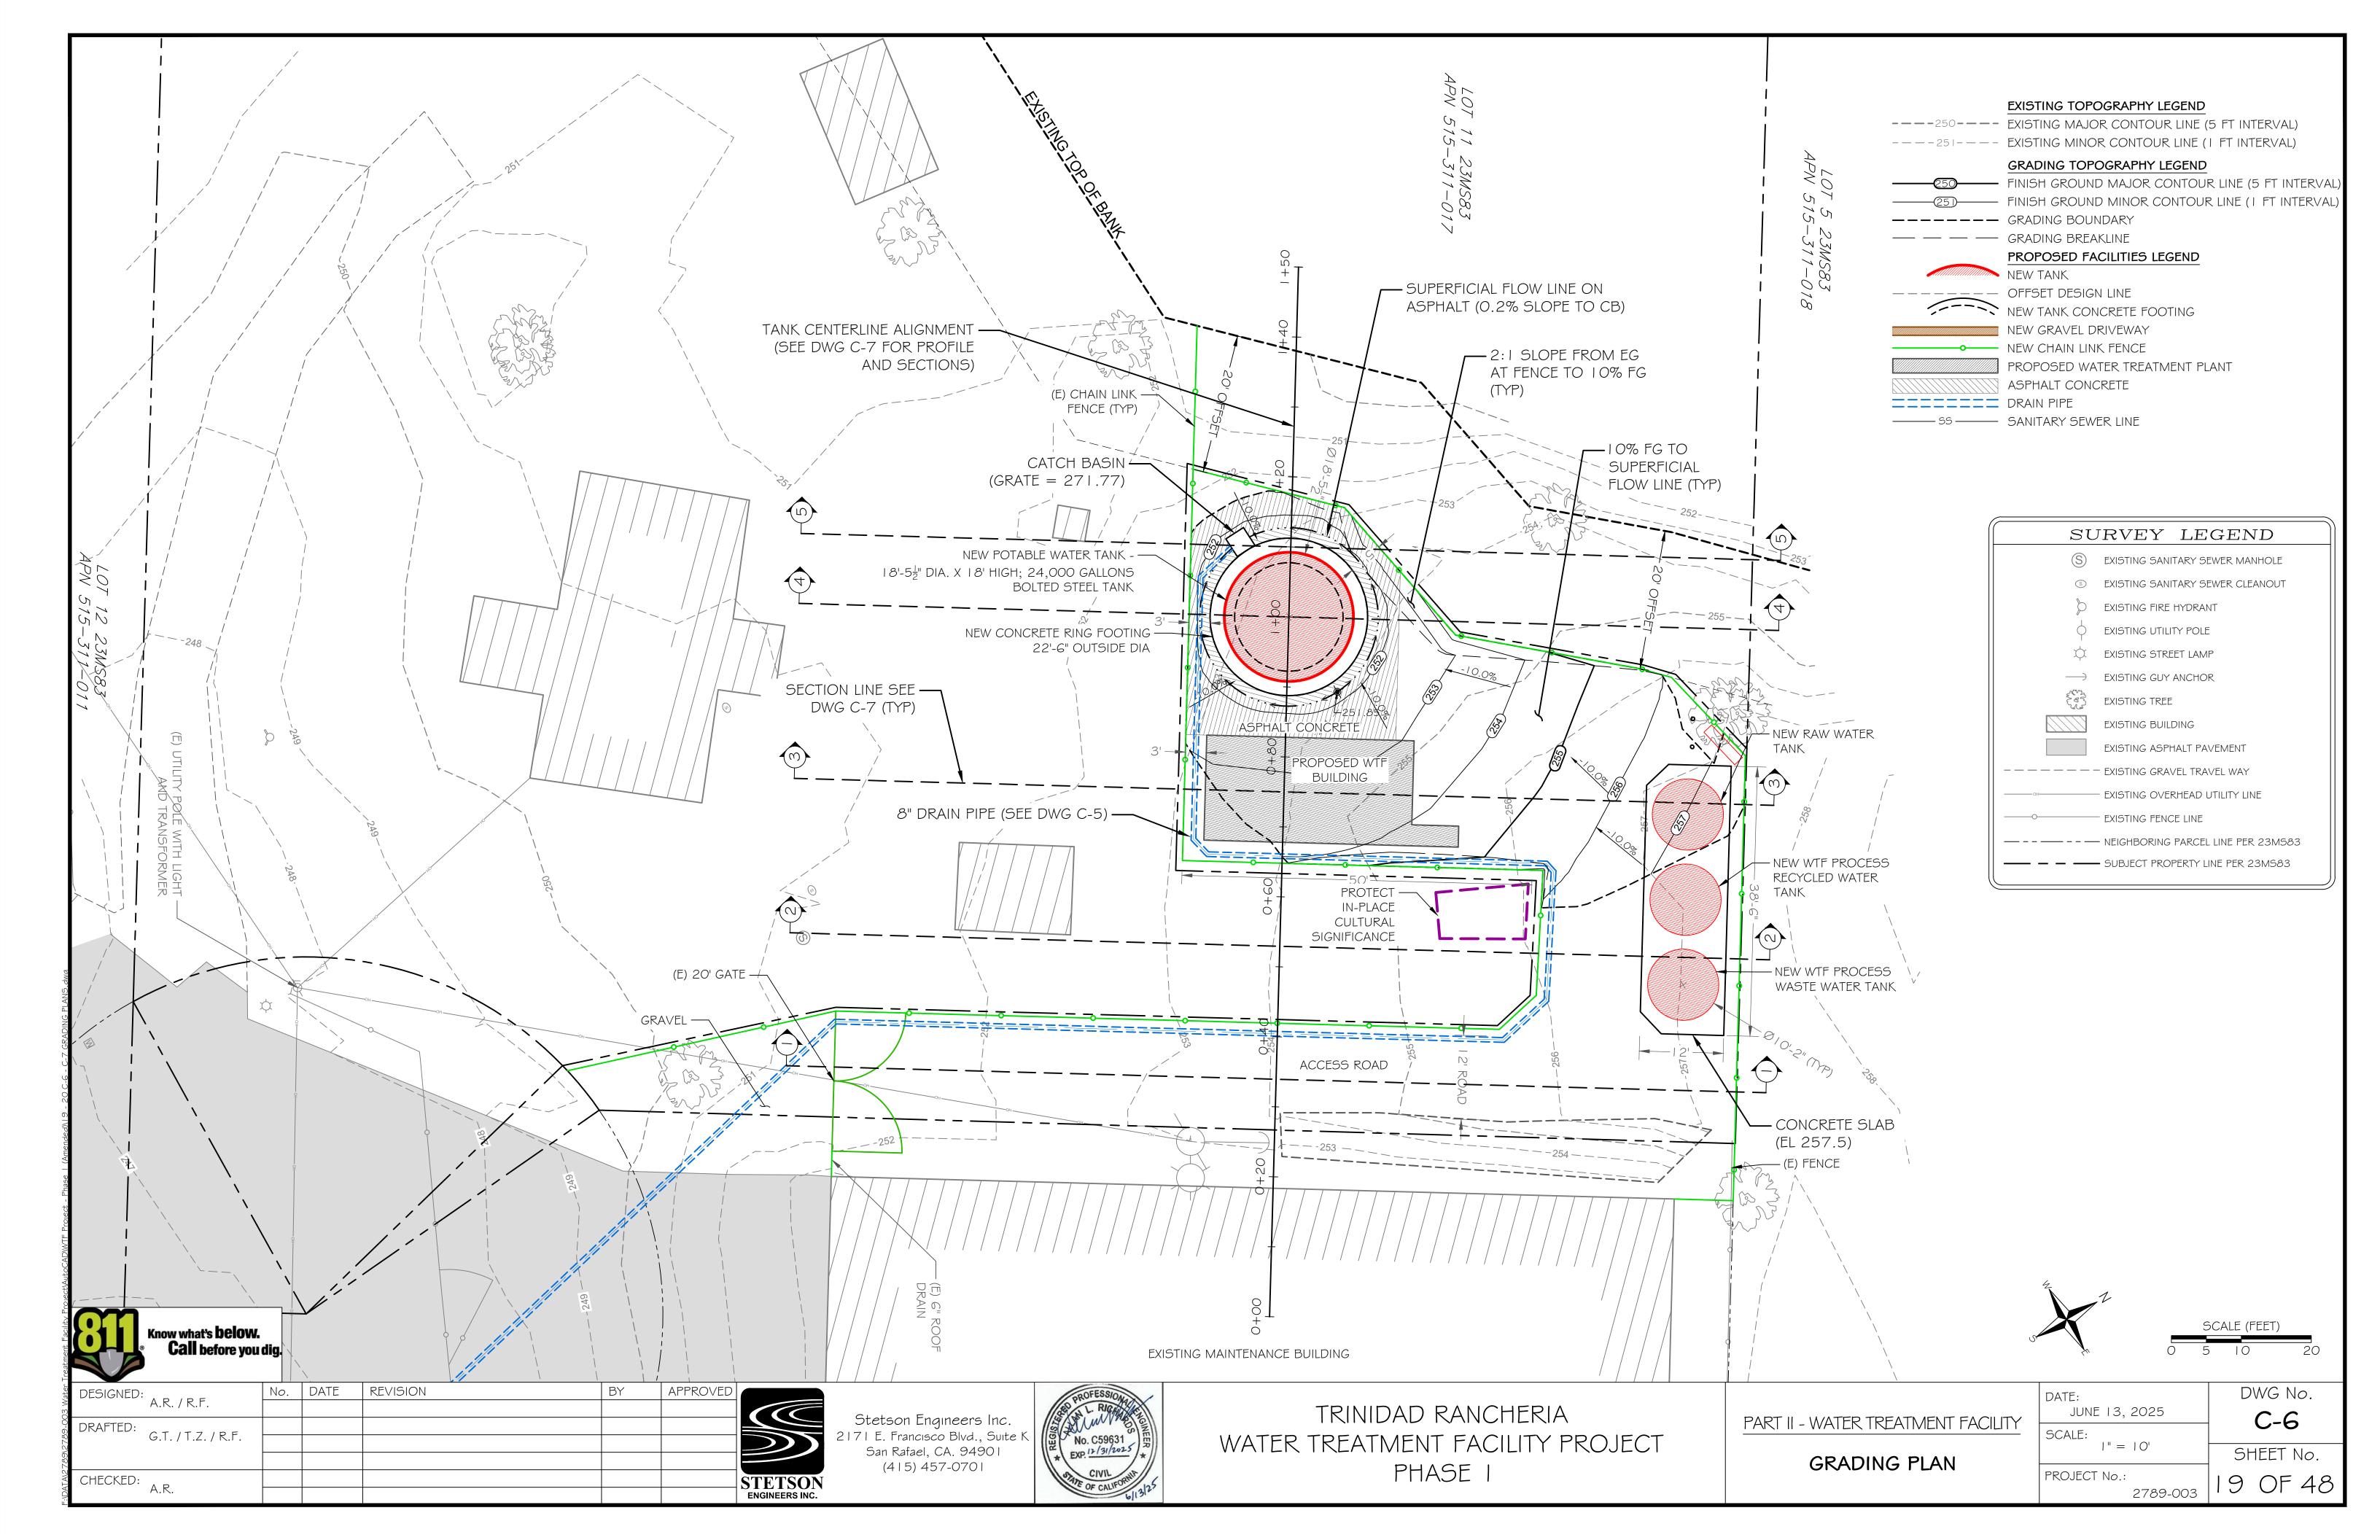
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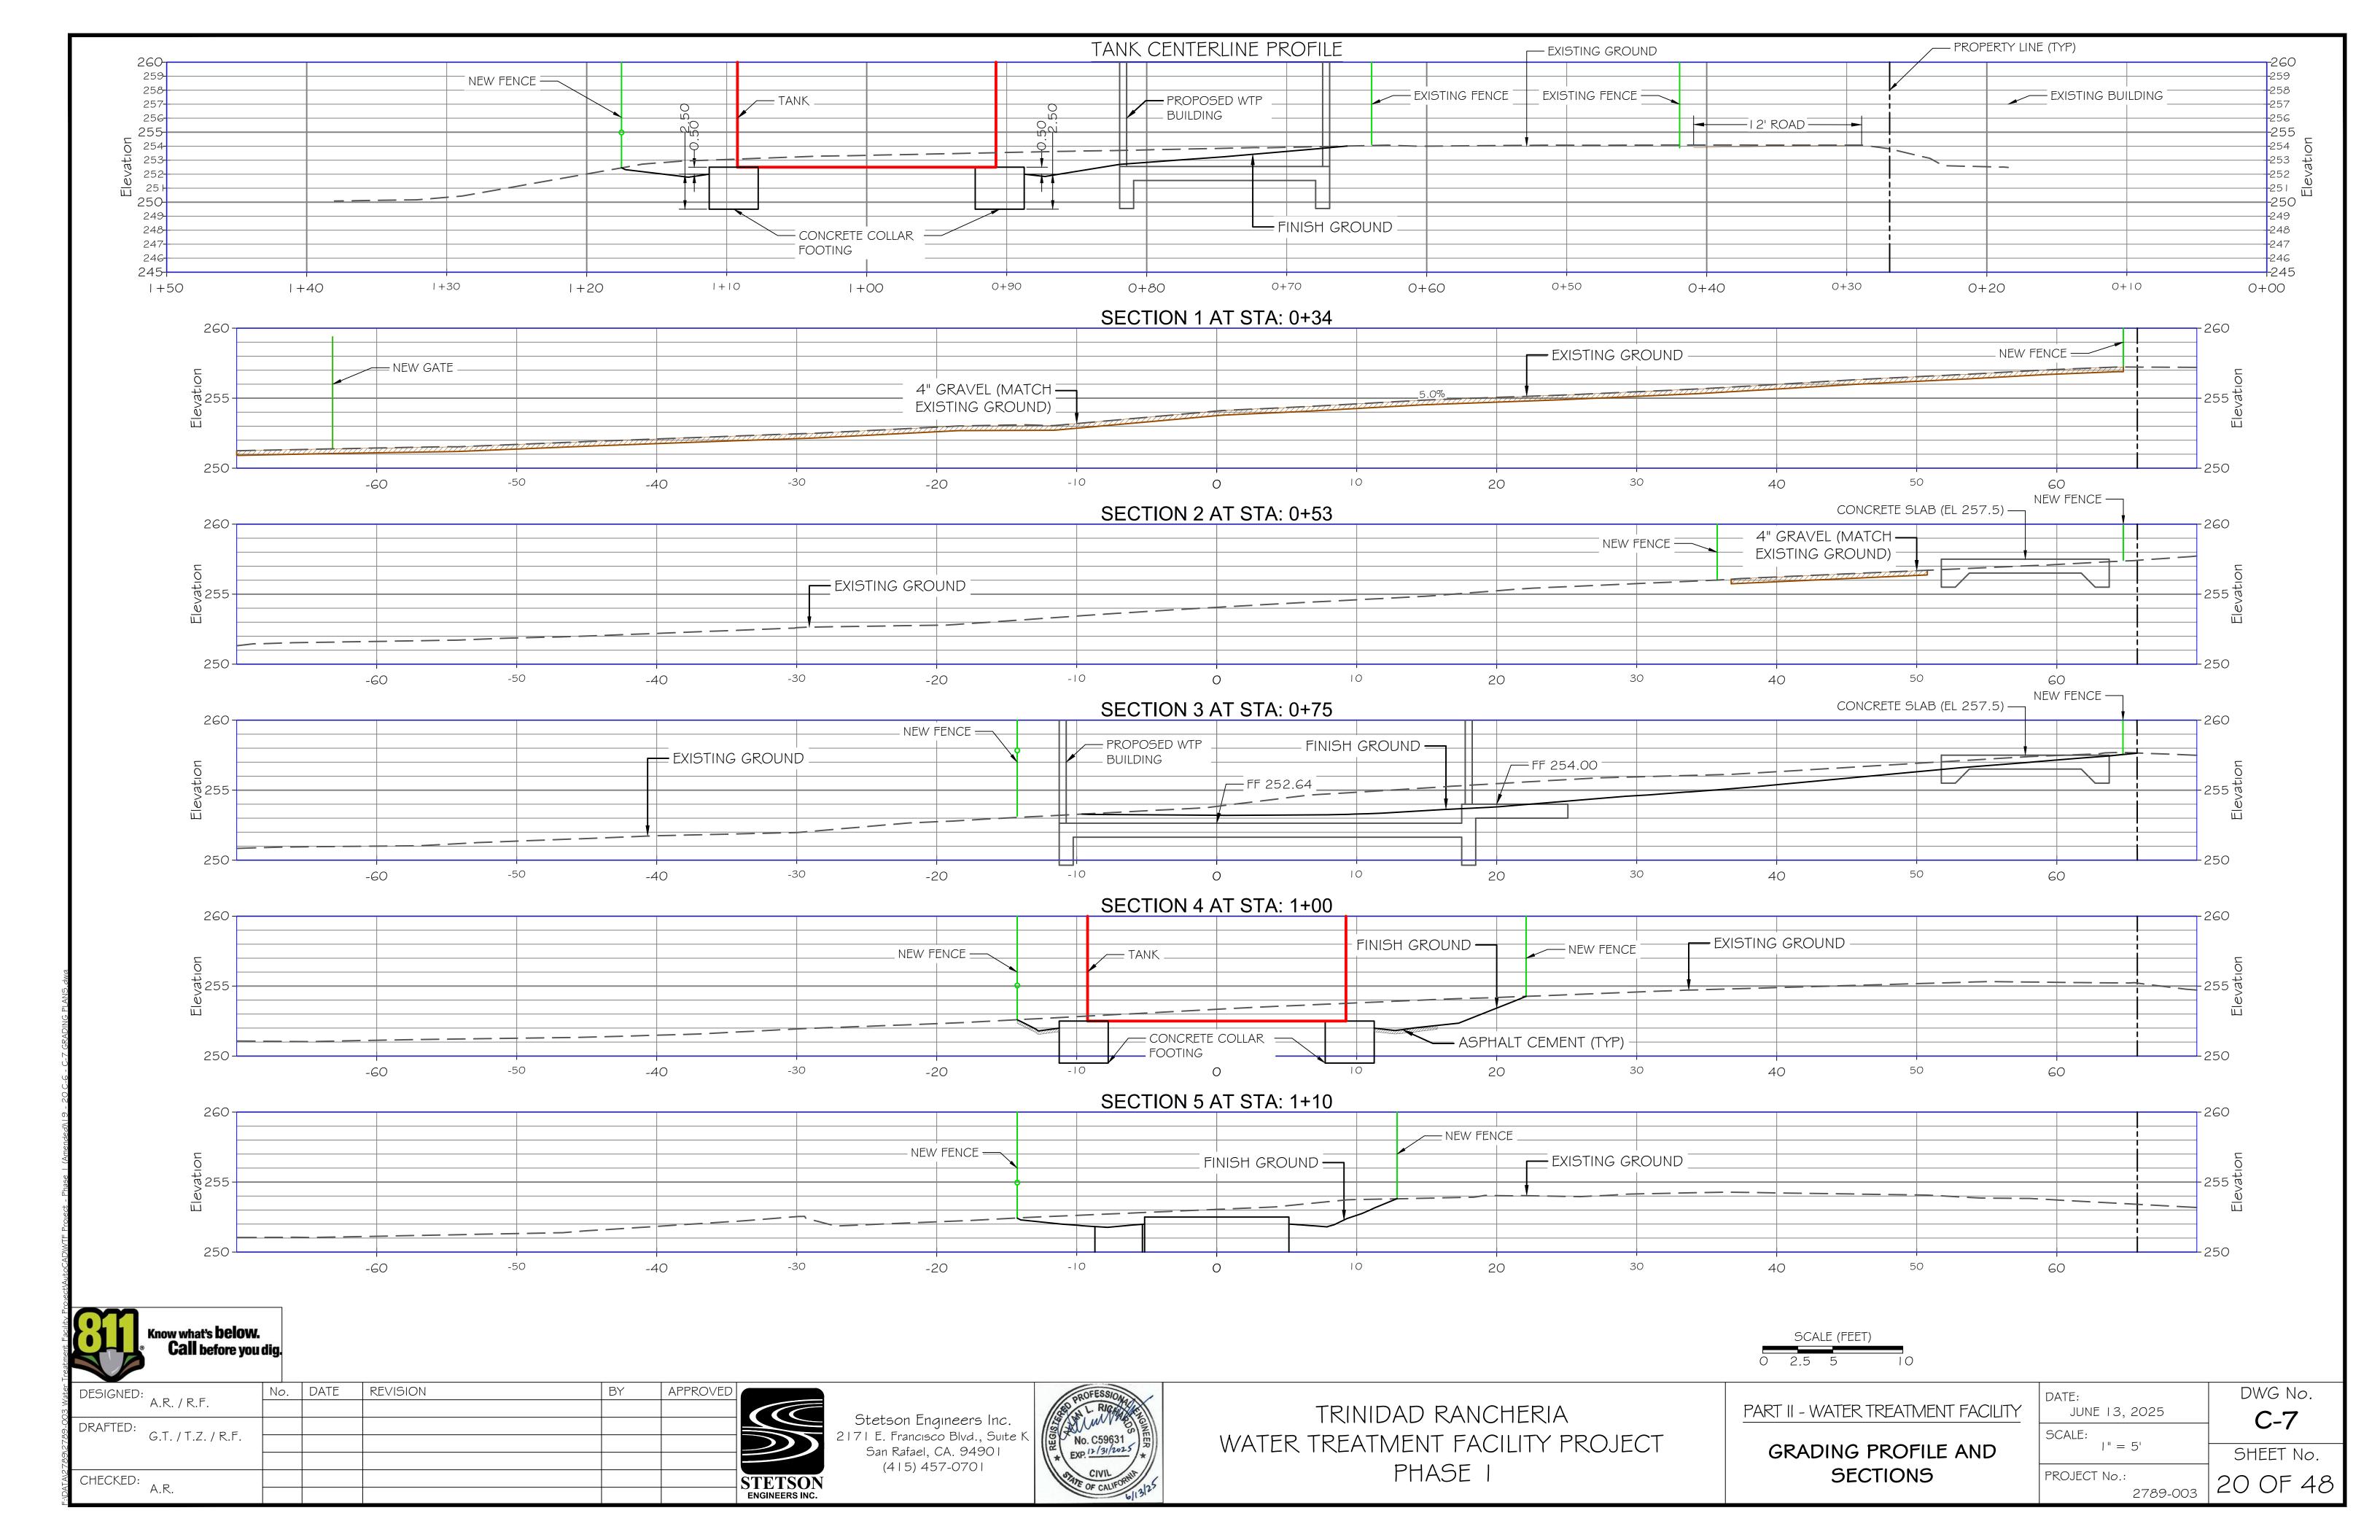
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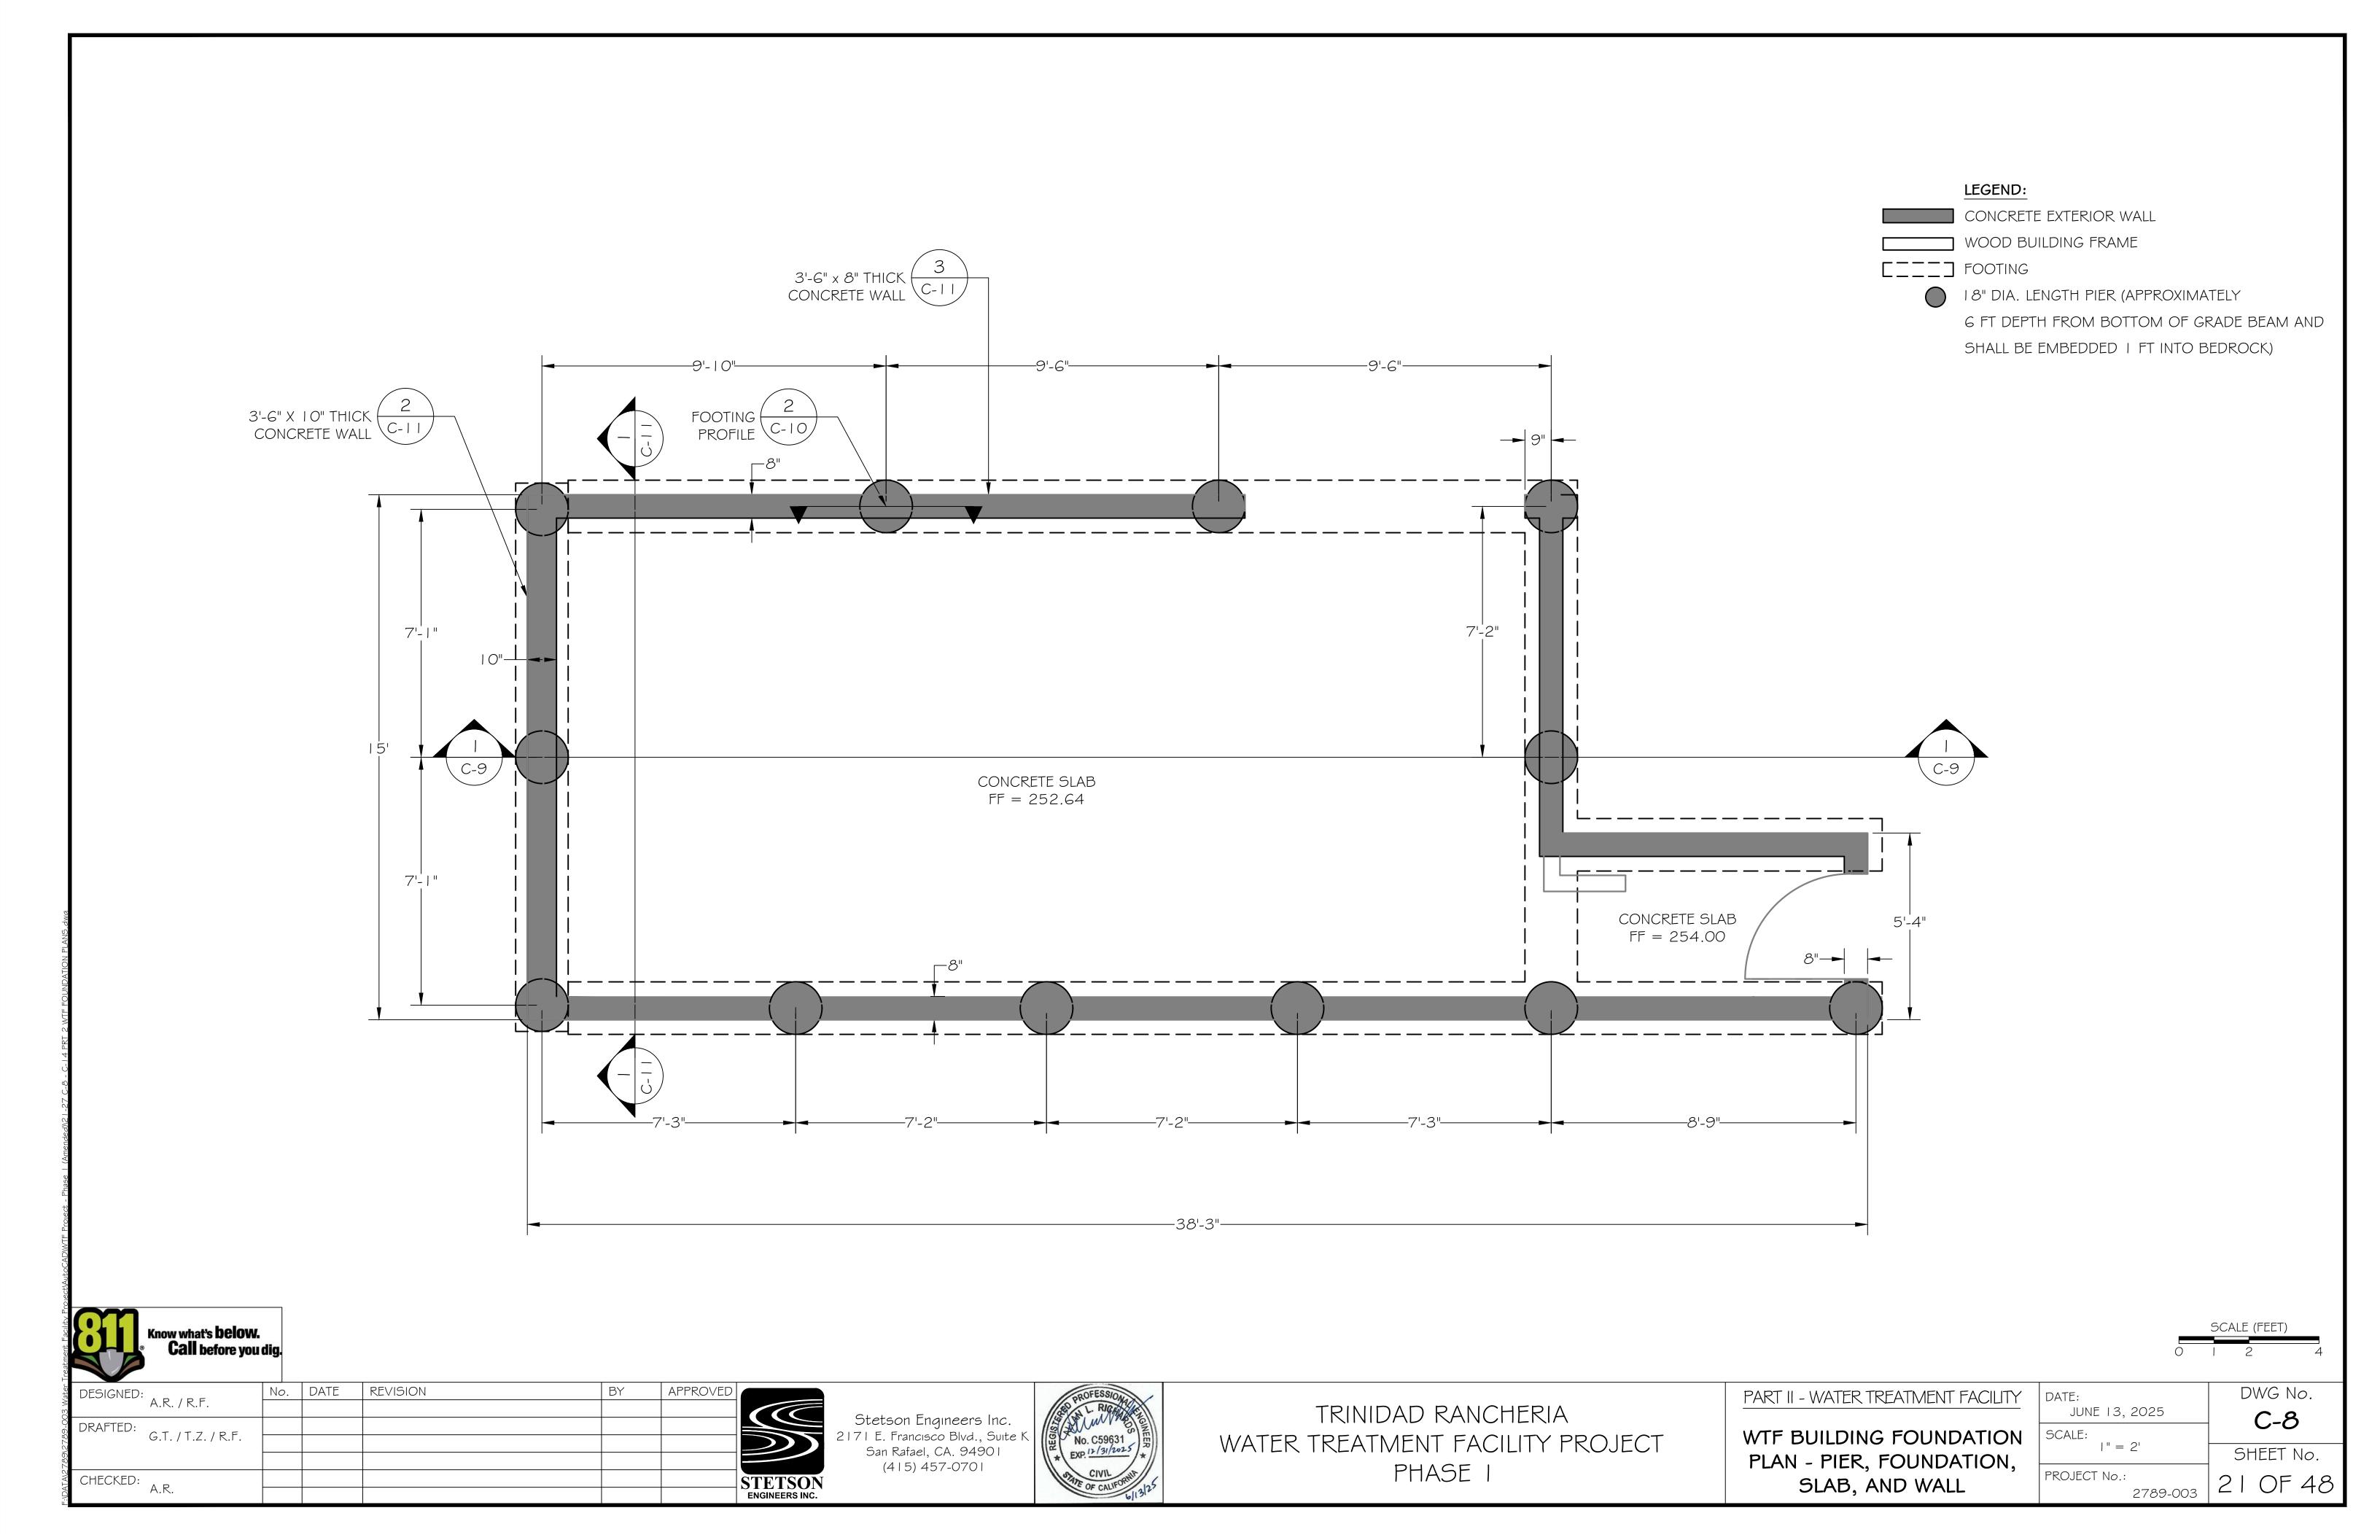
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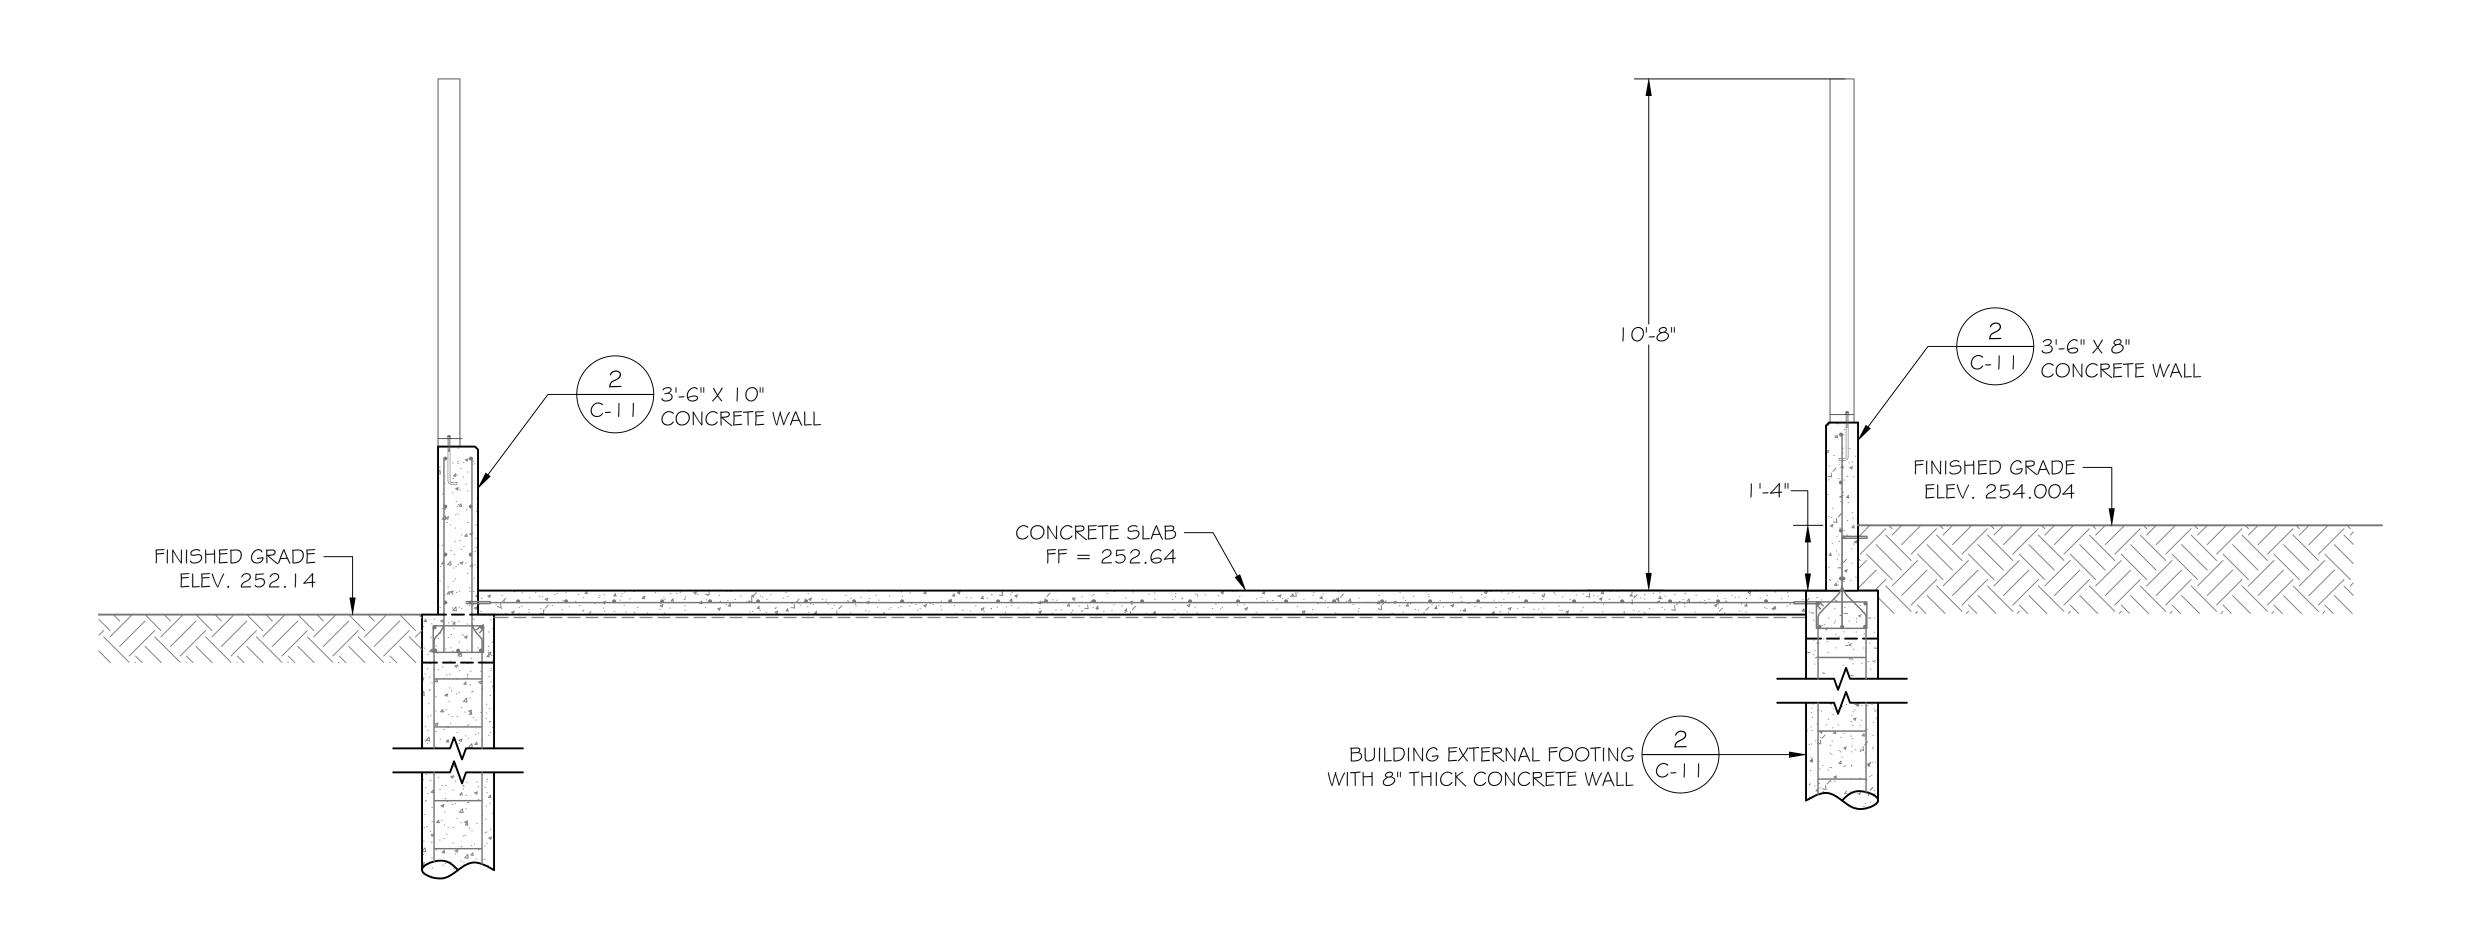
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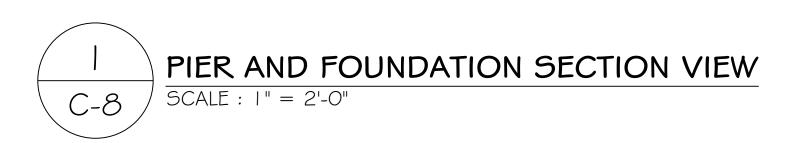















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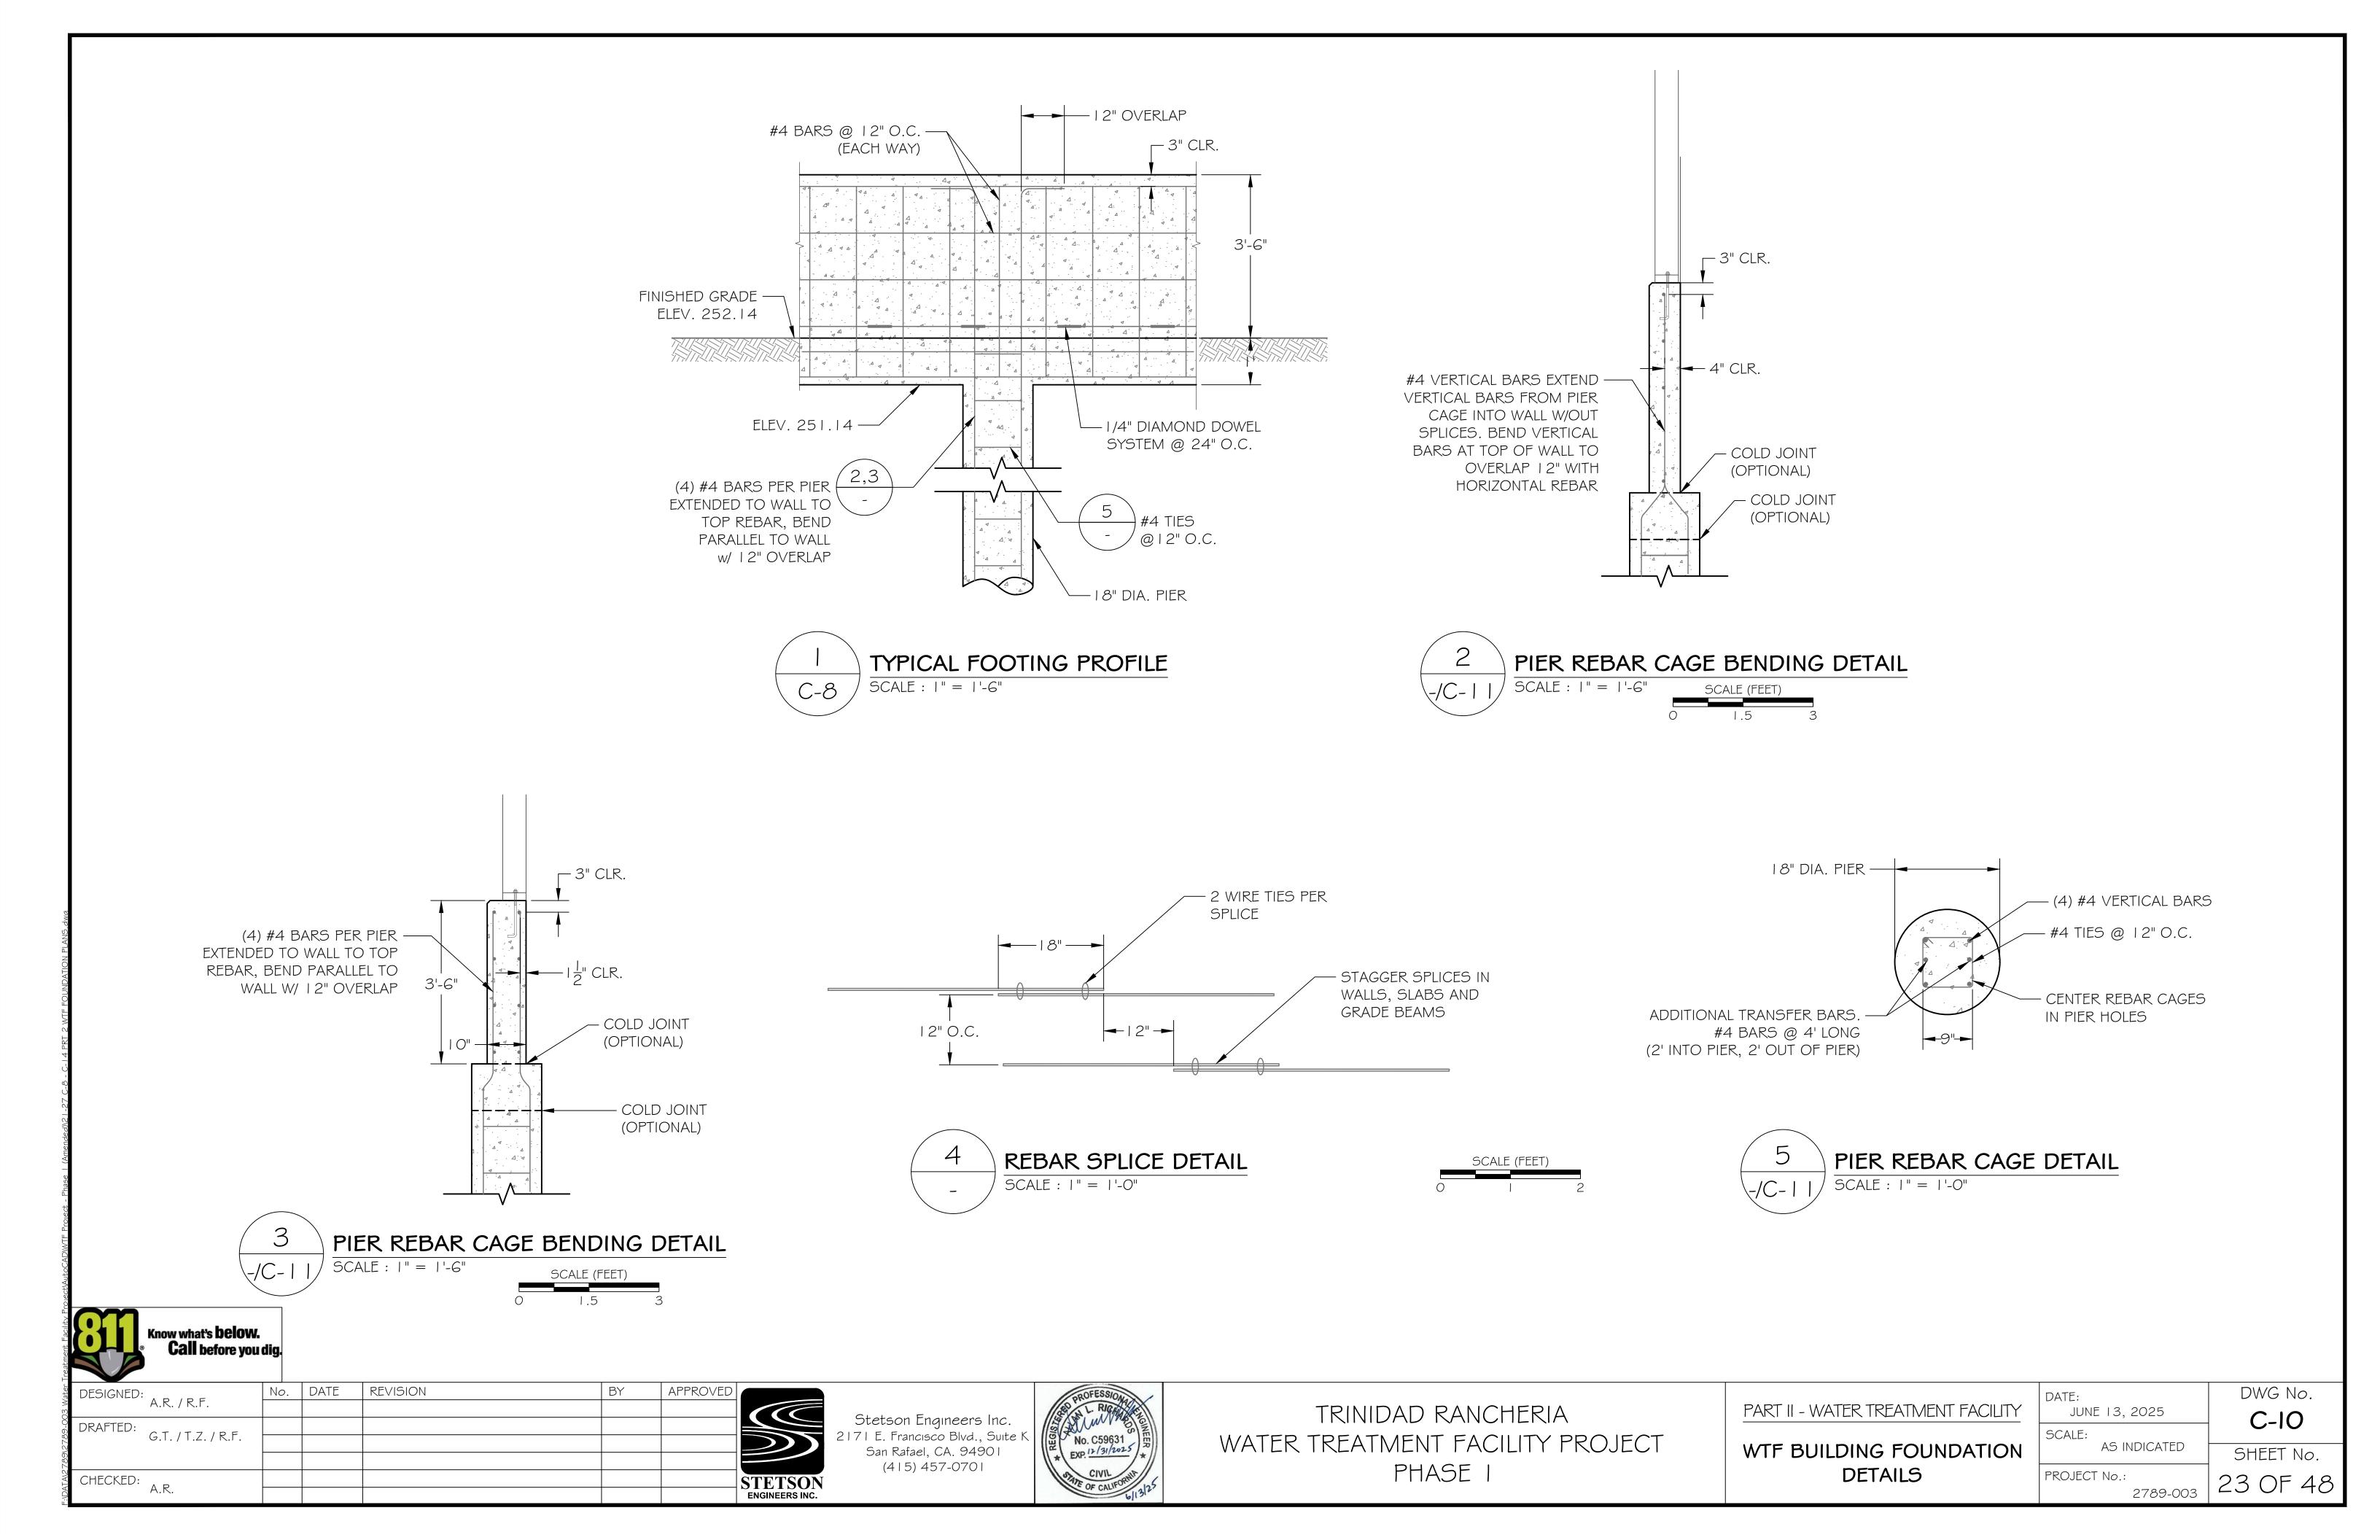



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WATER TREATMENT FACILITY PROJECT
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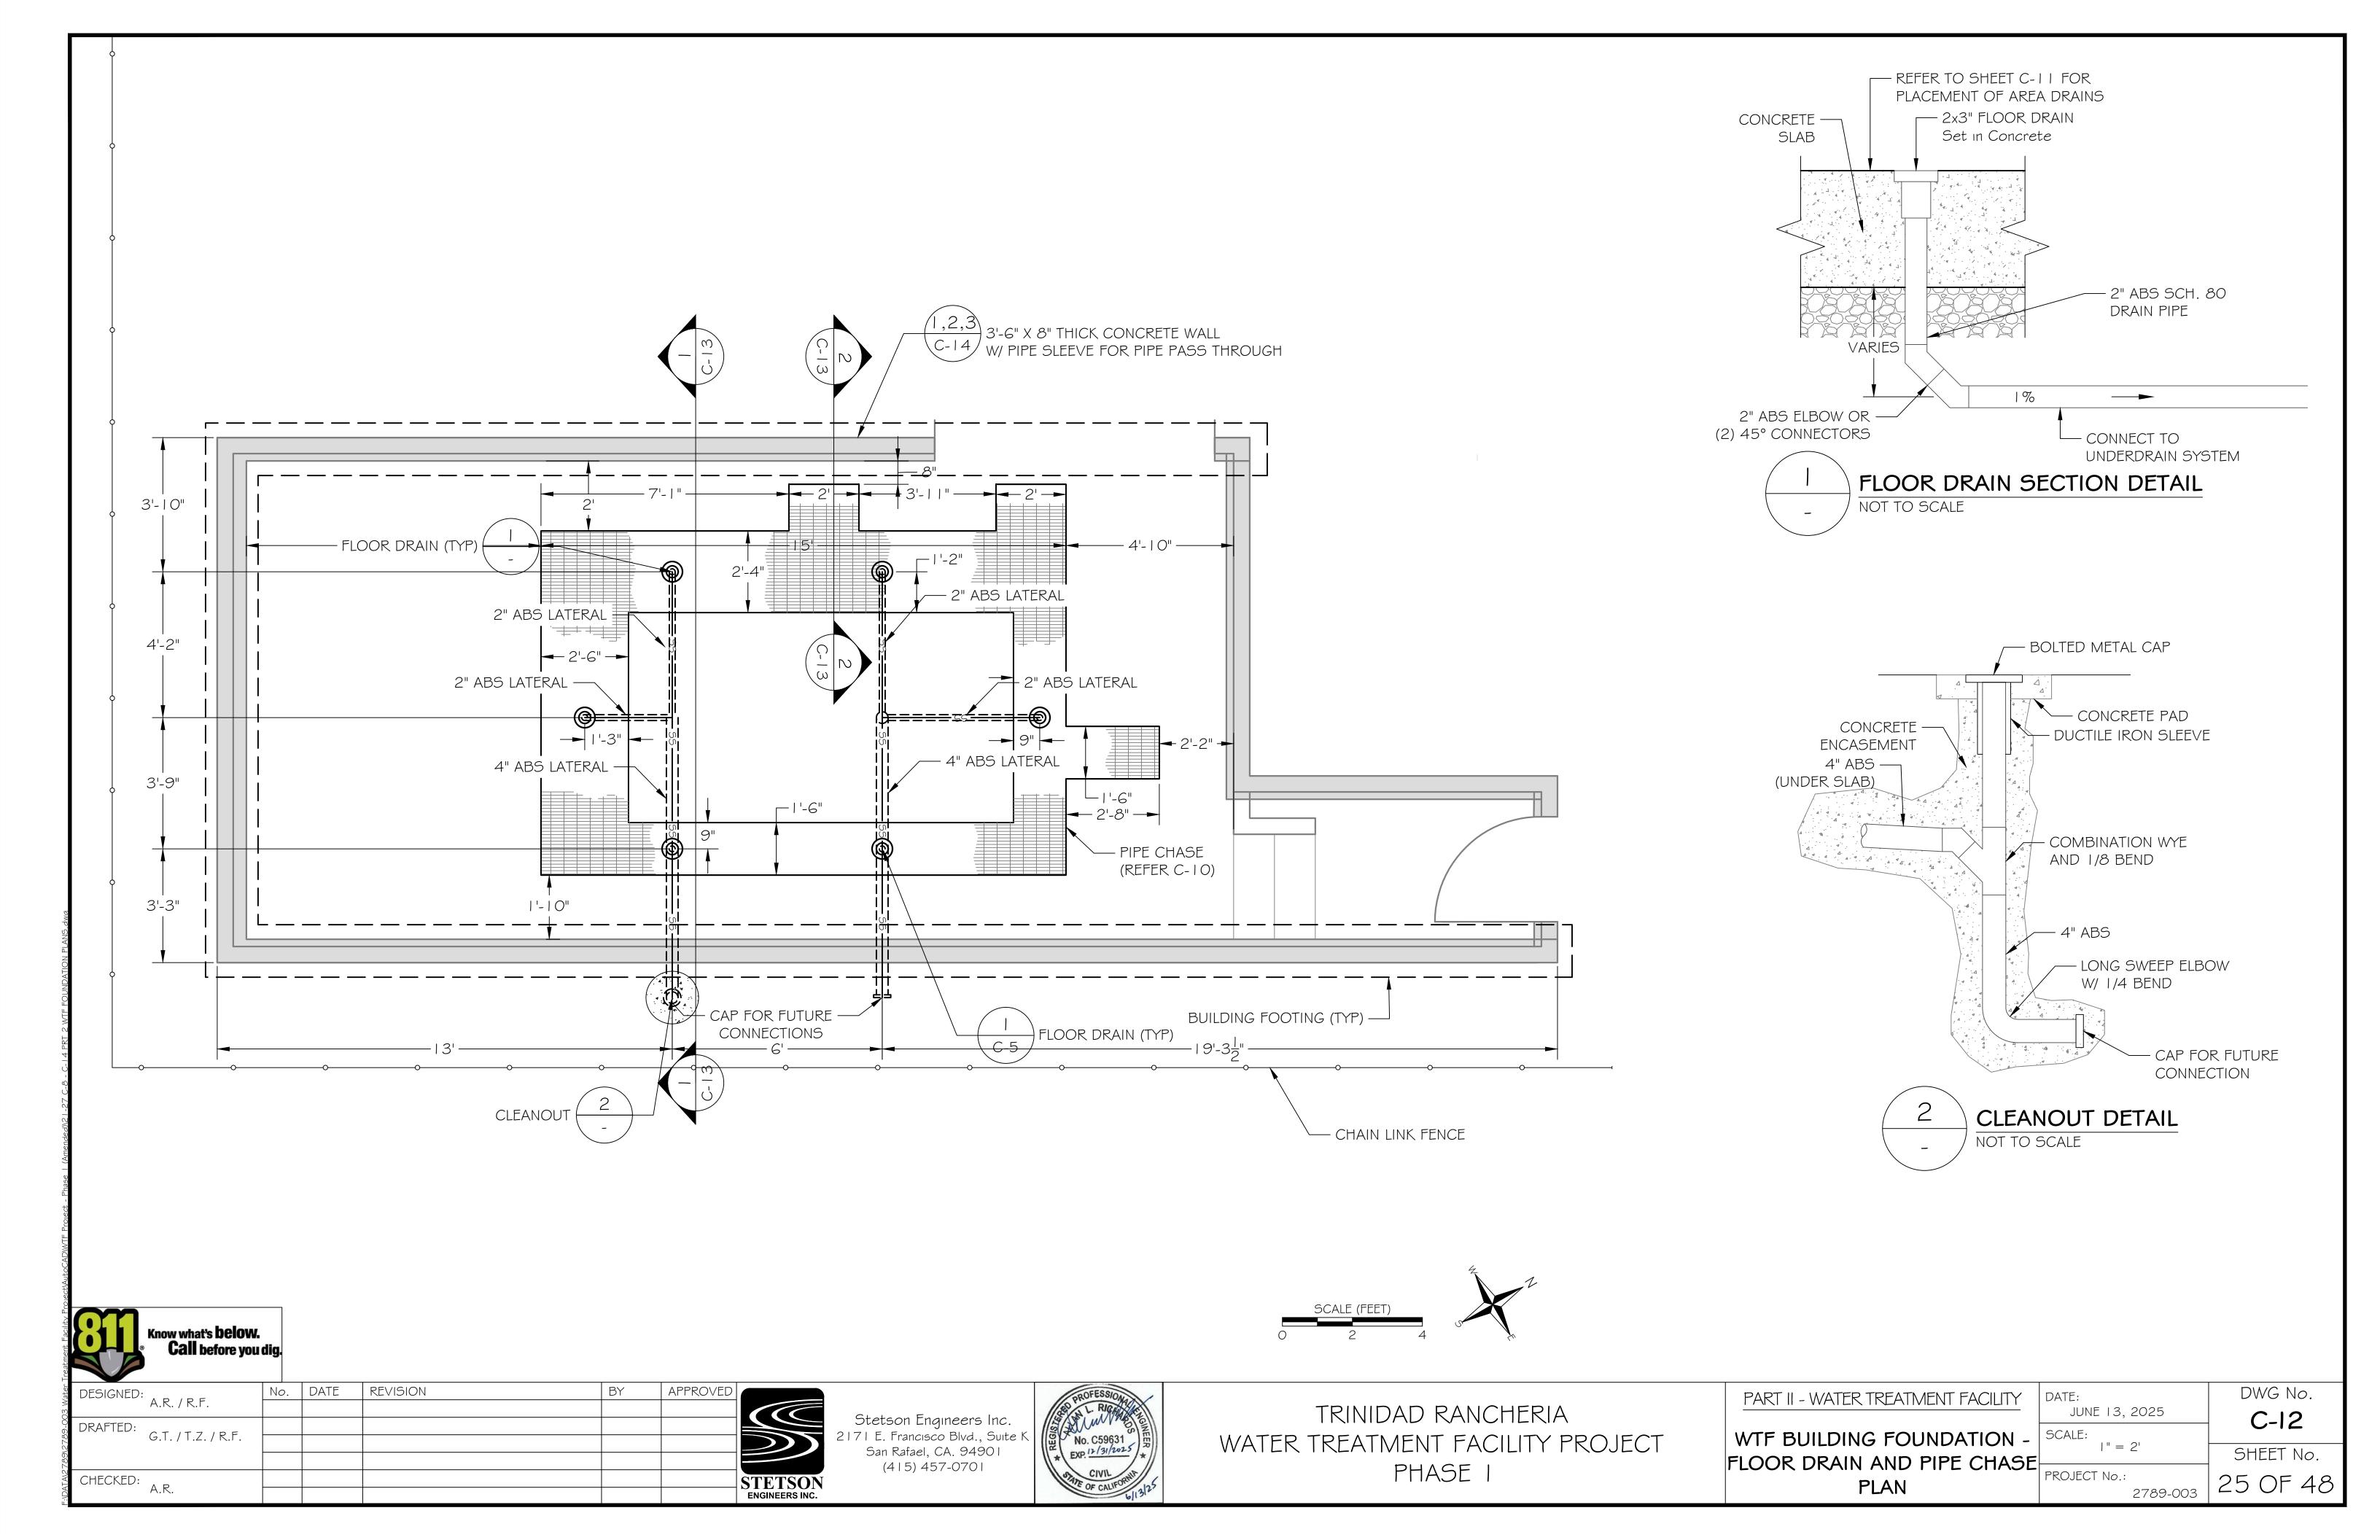
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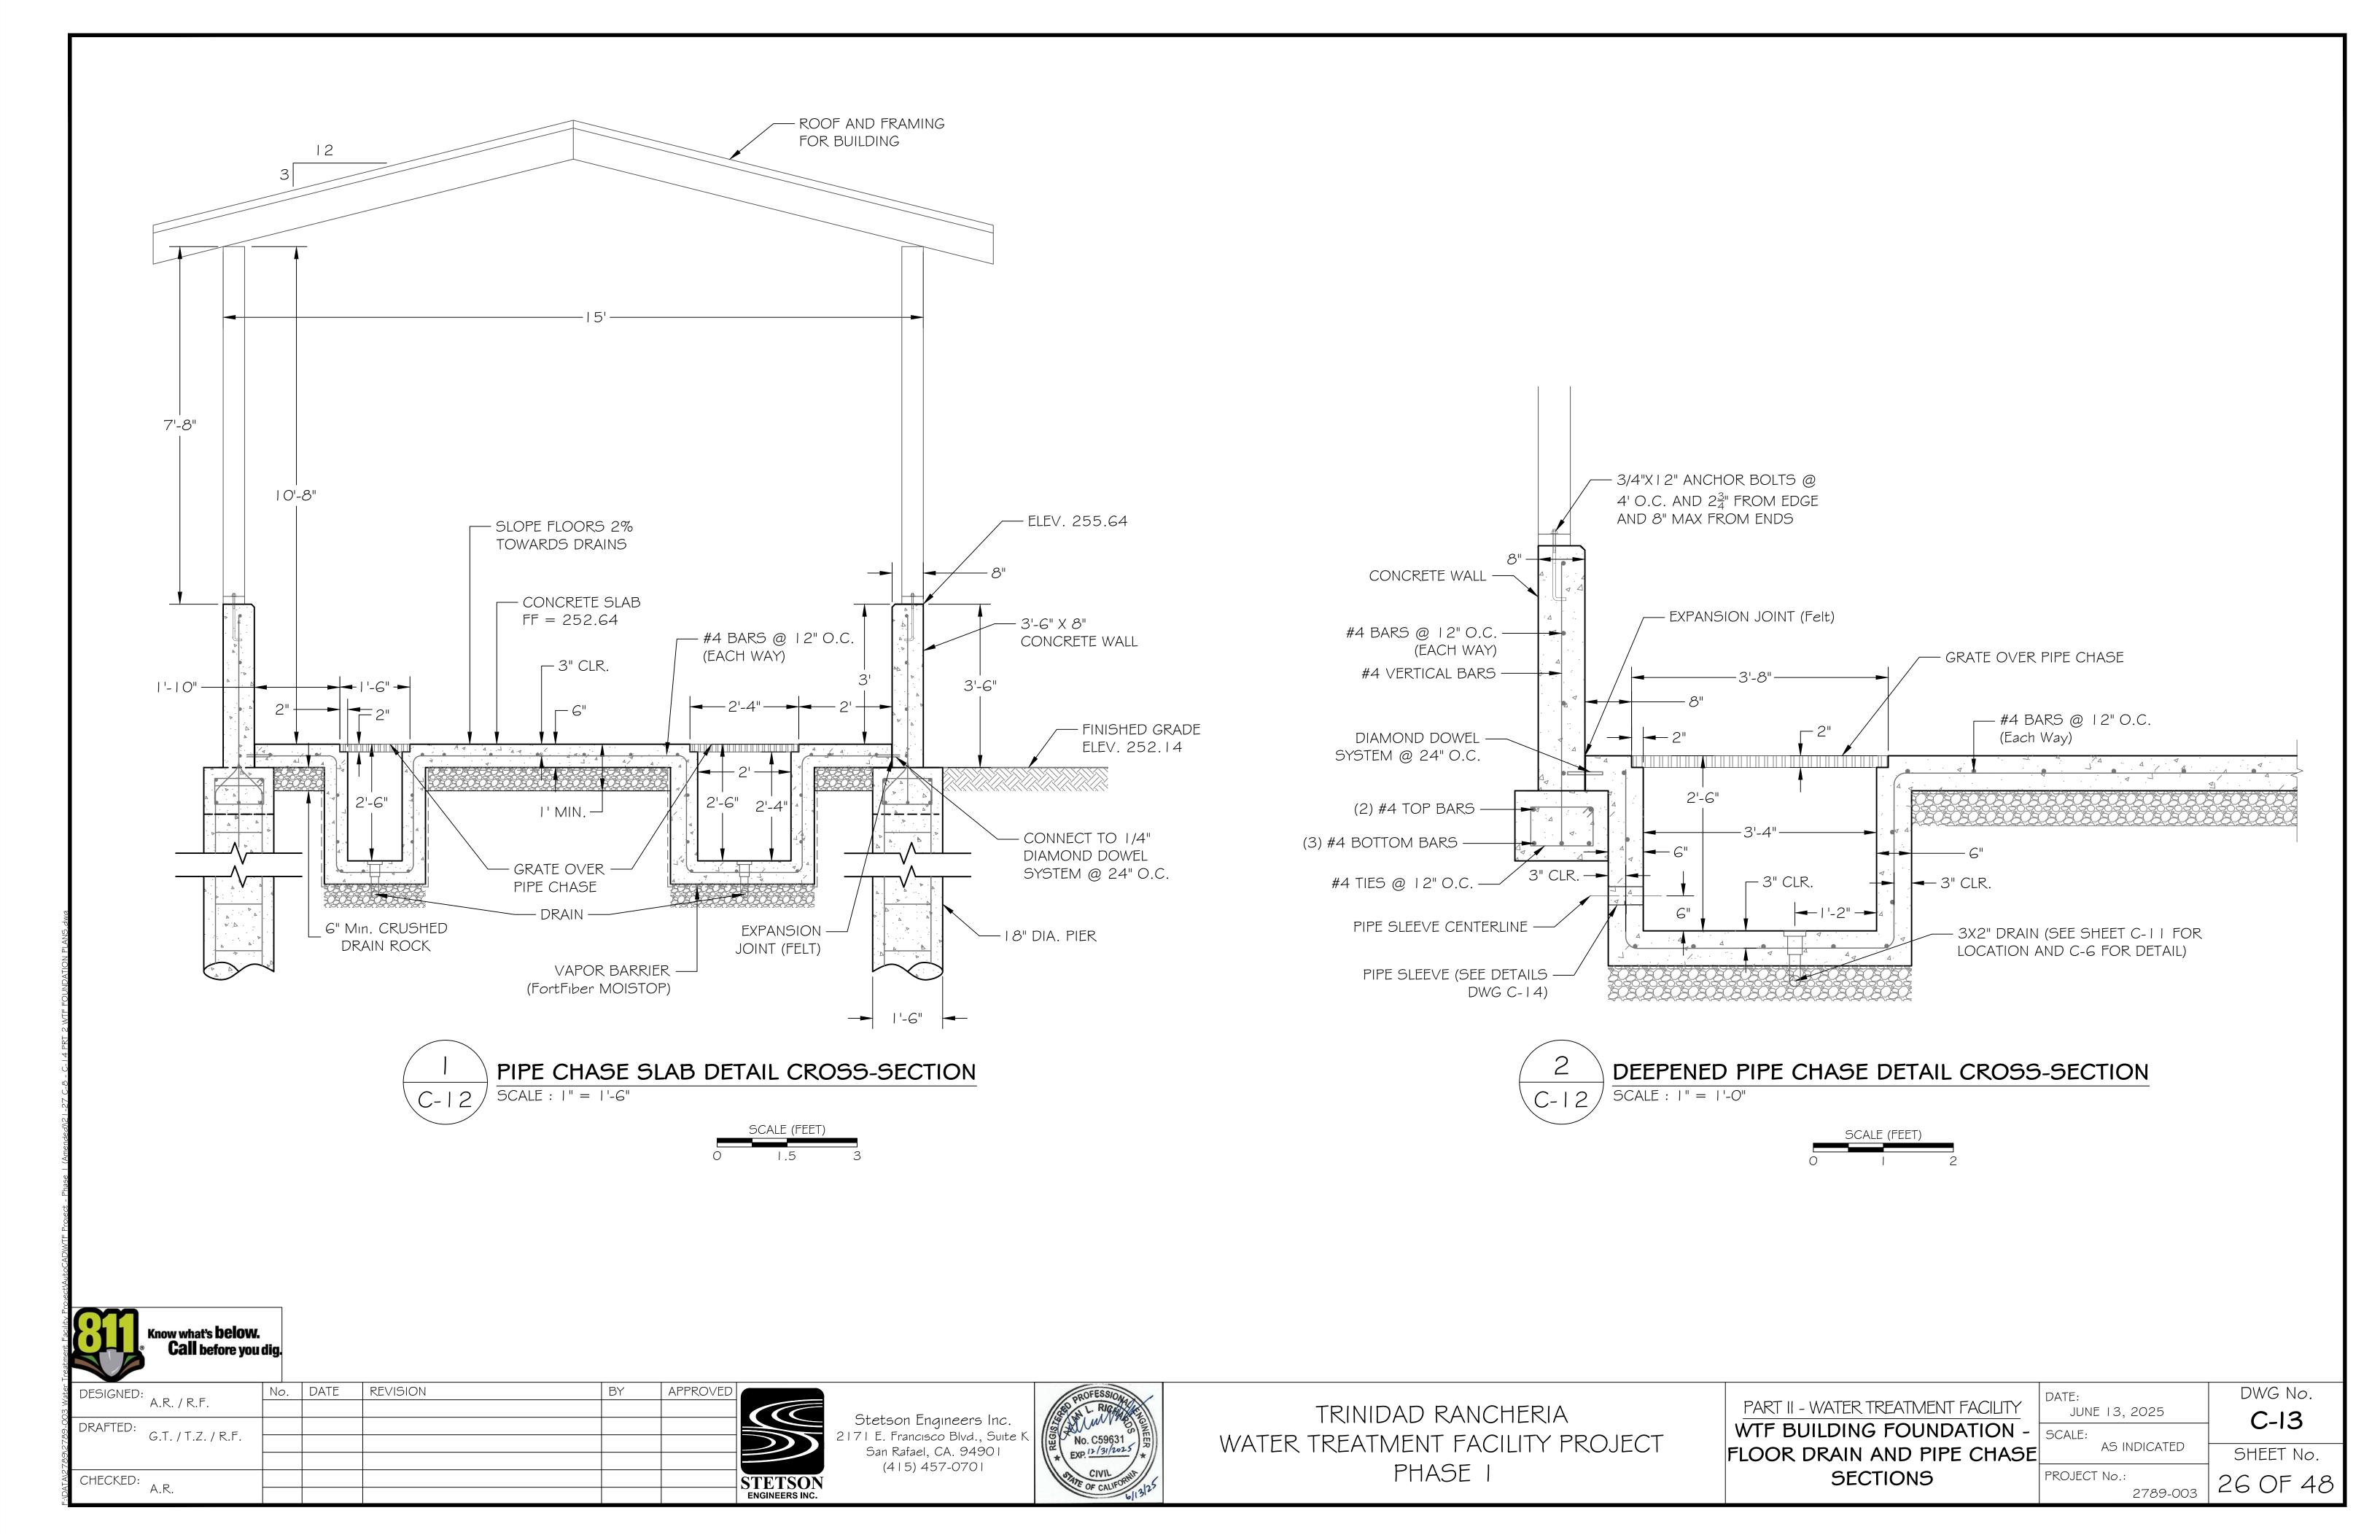
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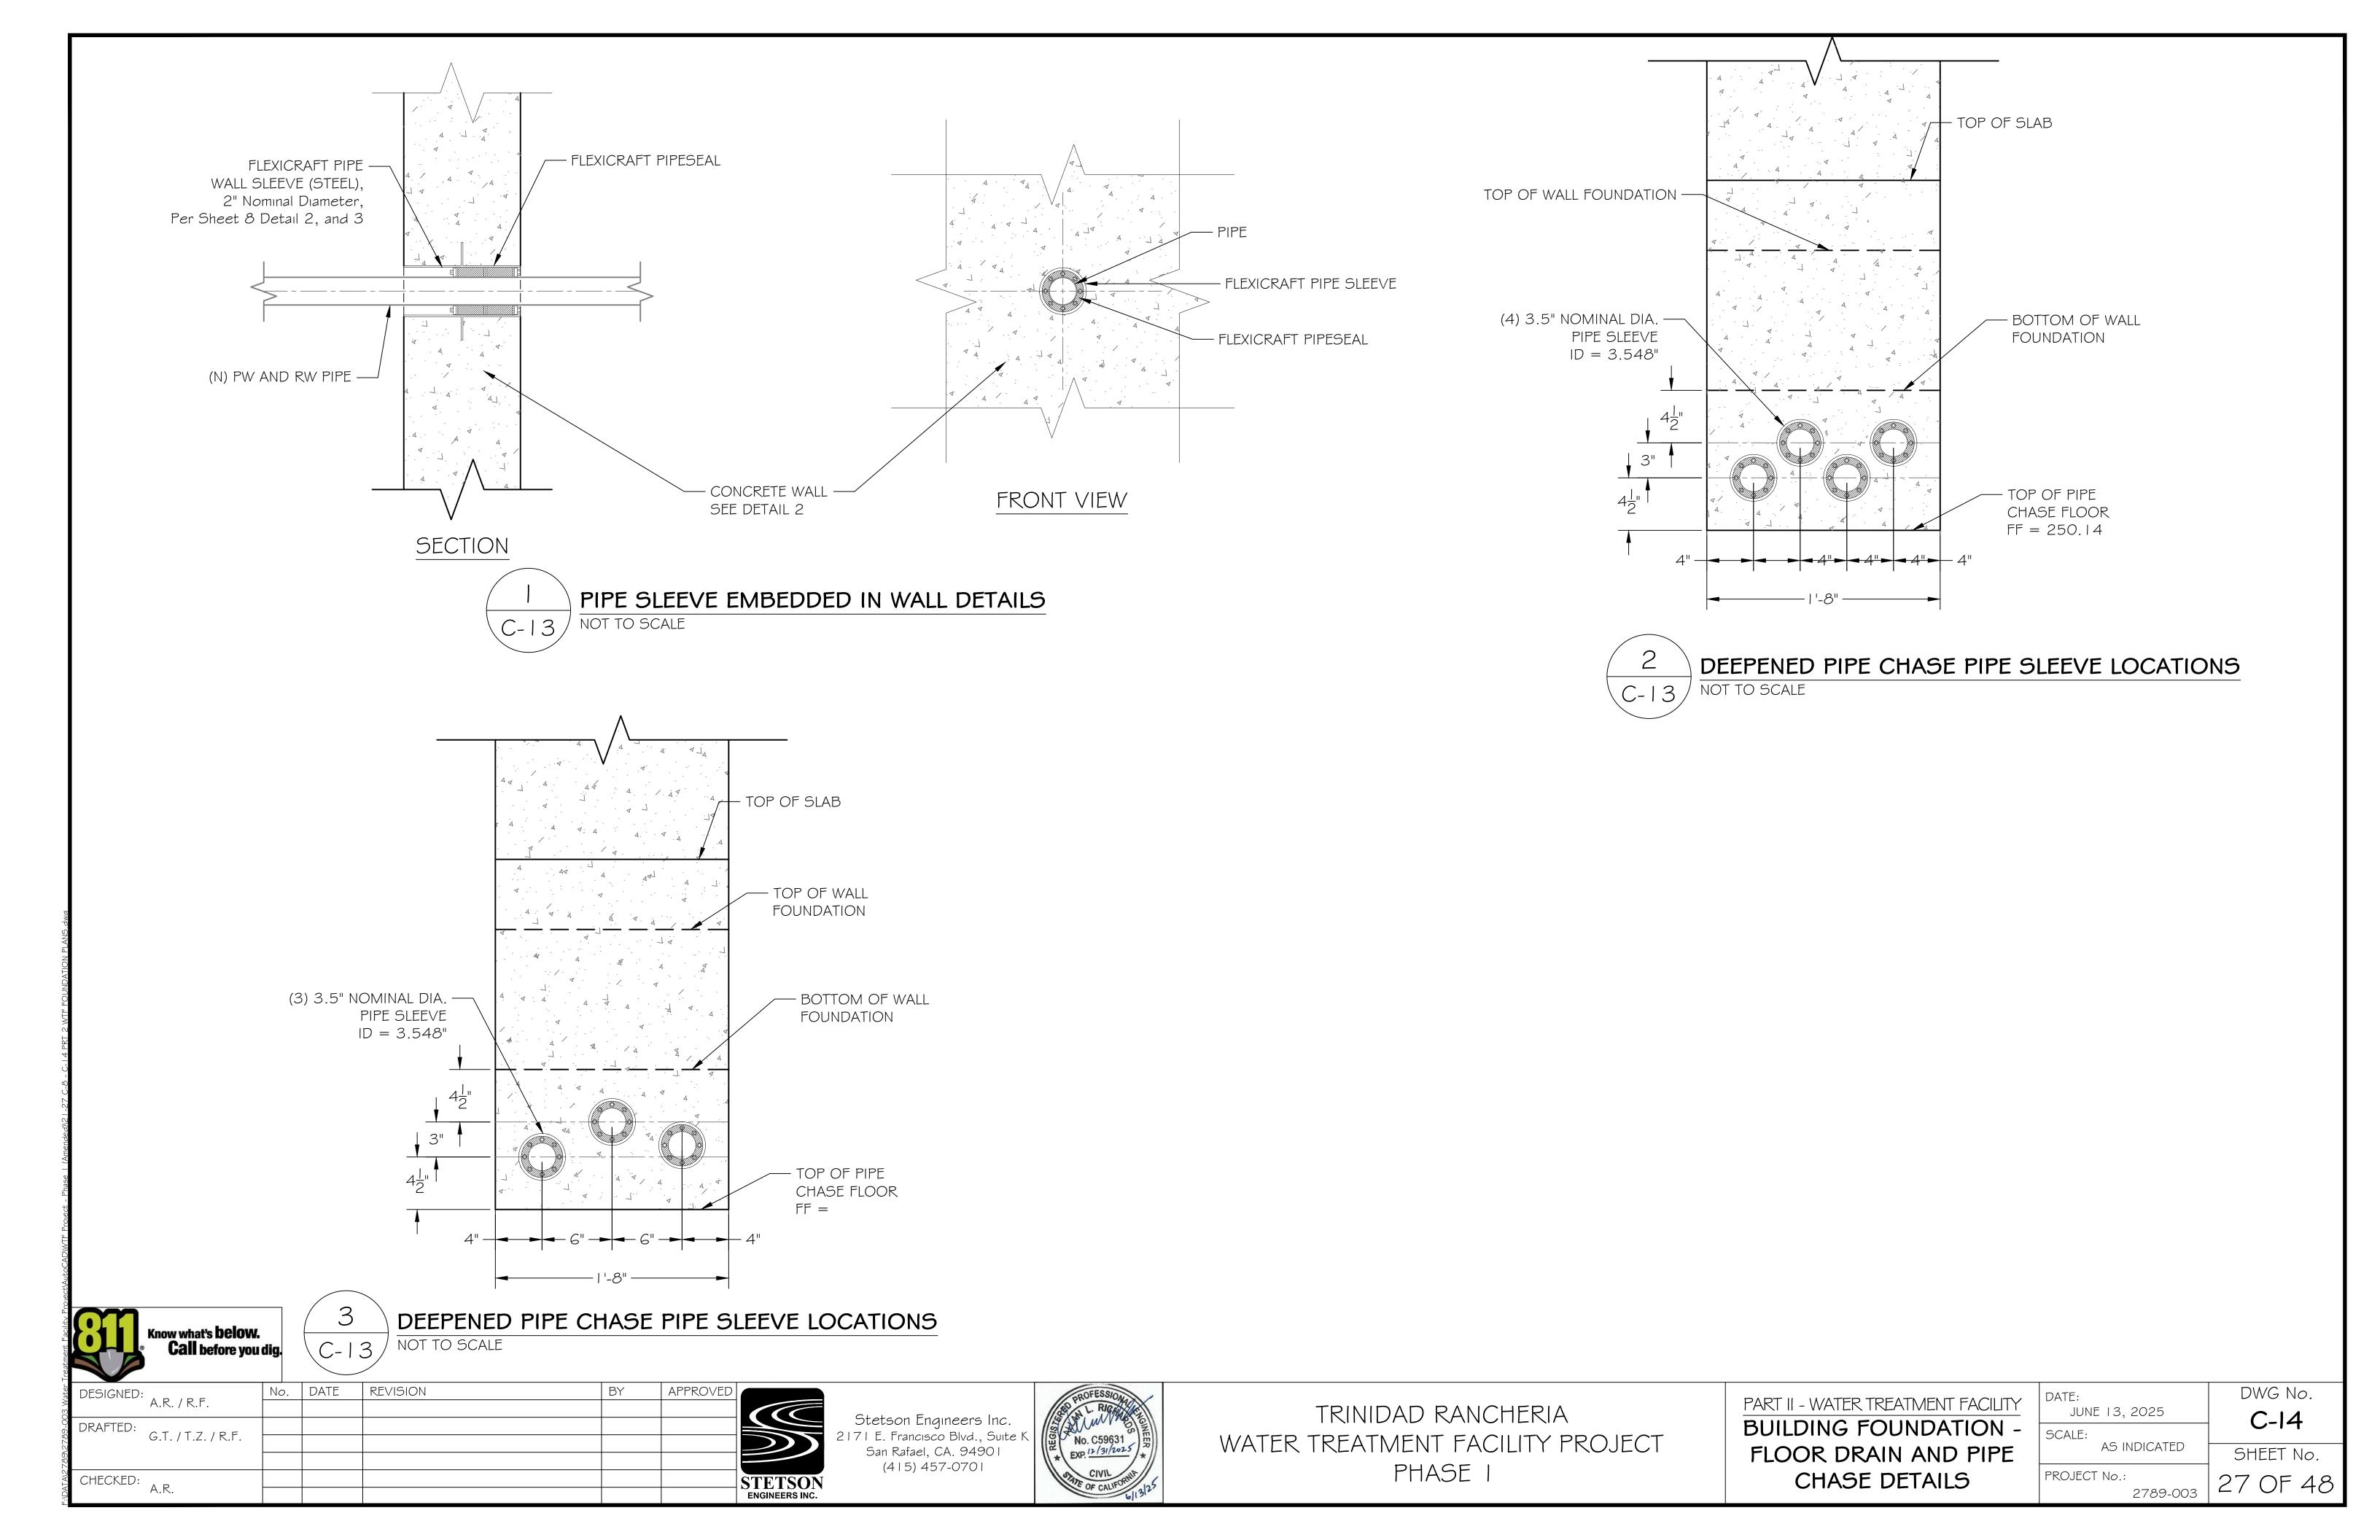
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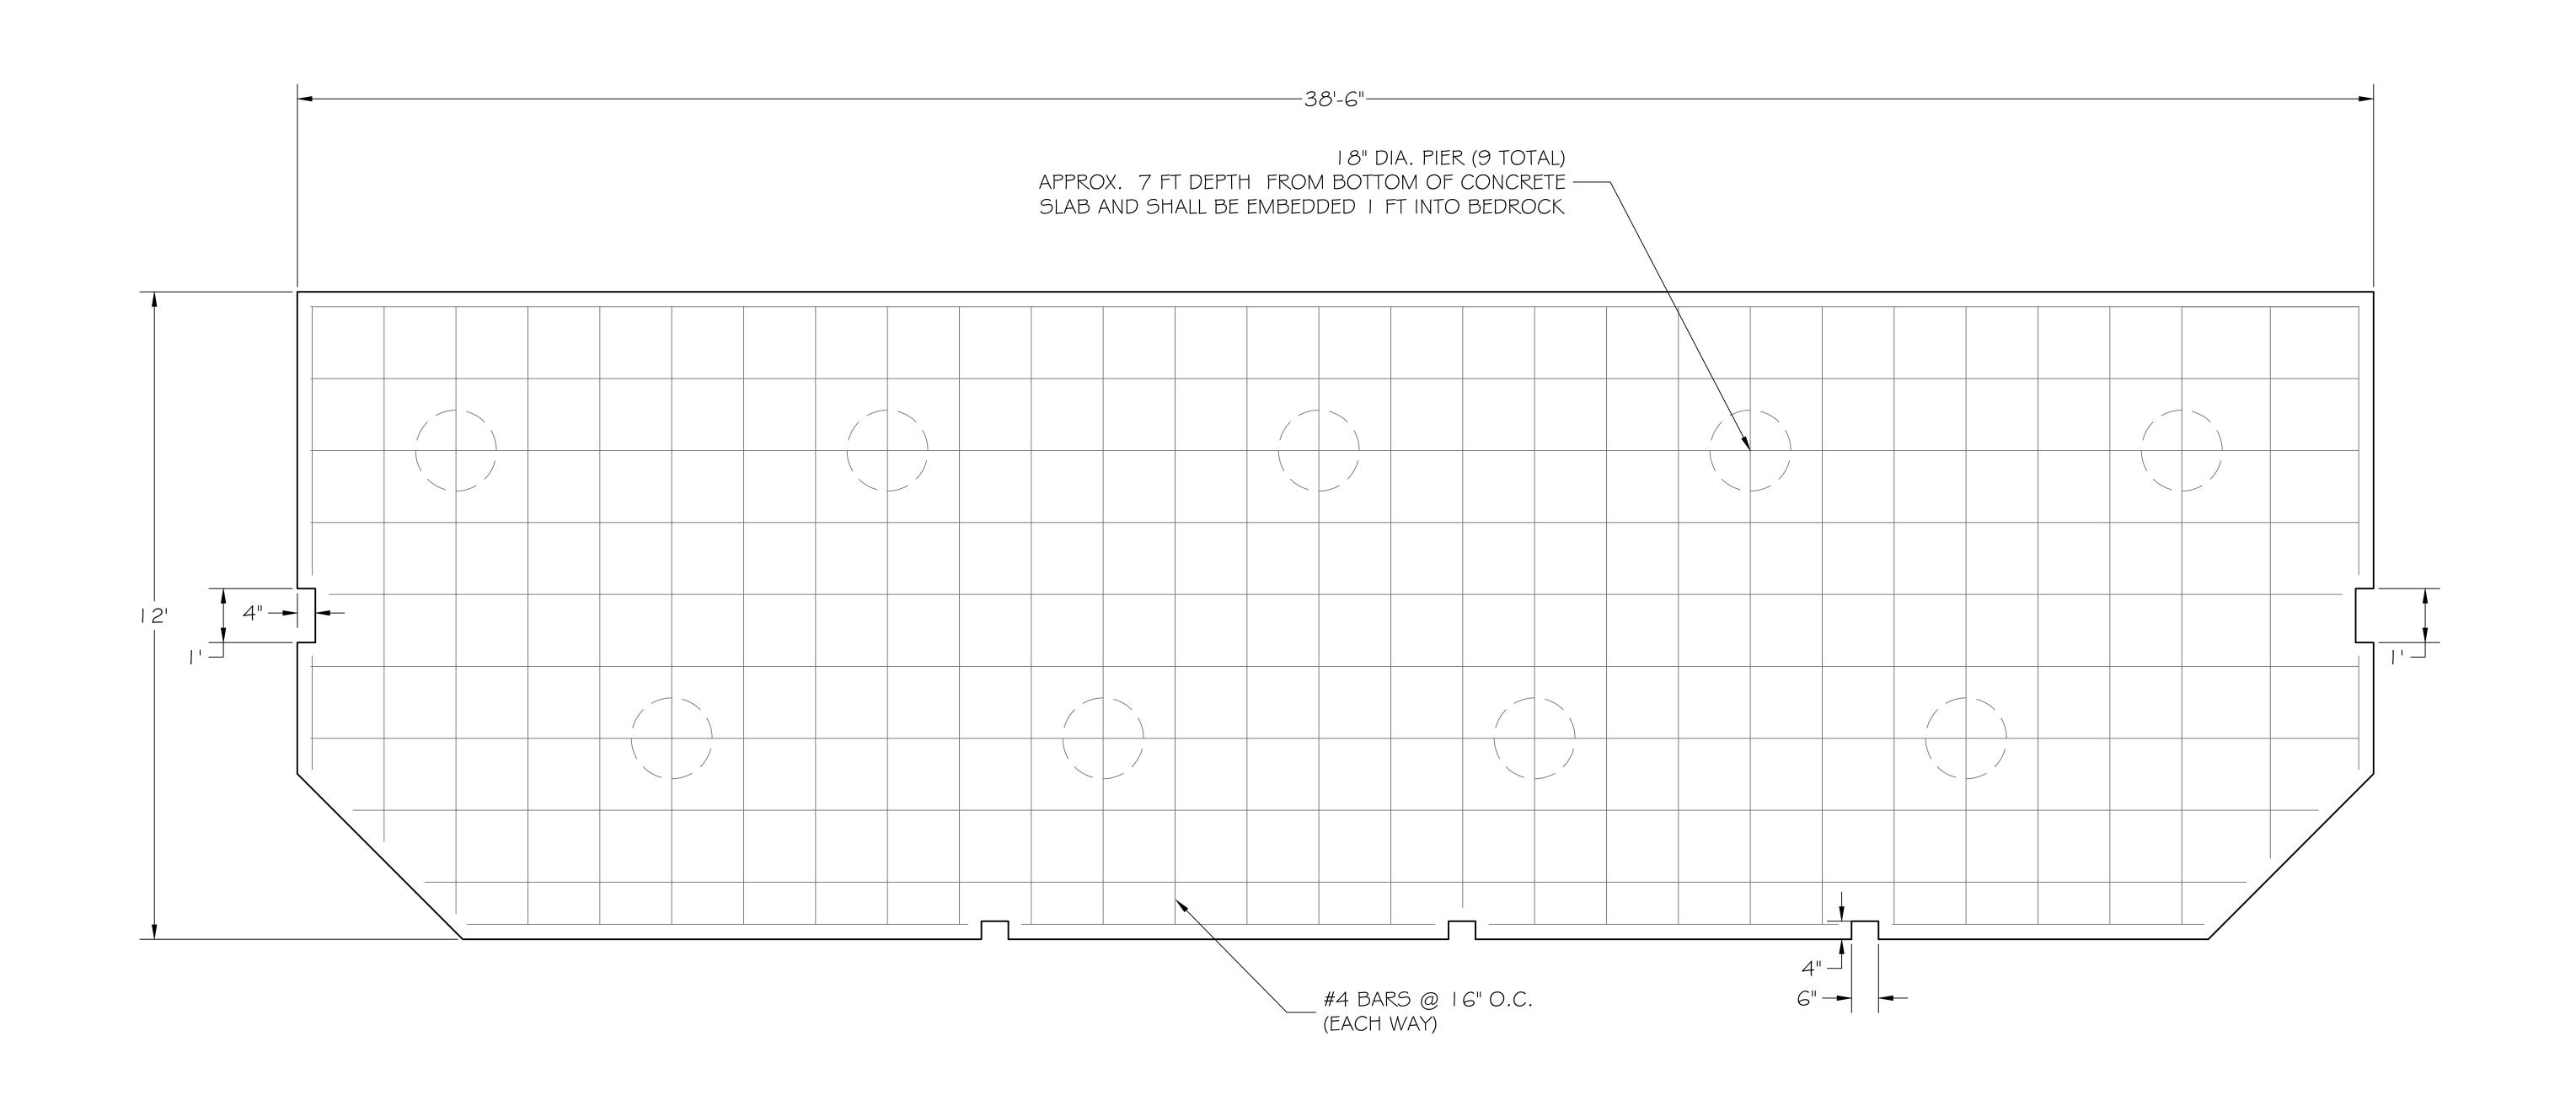




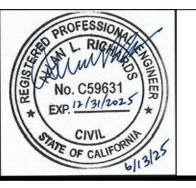





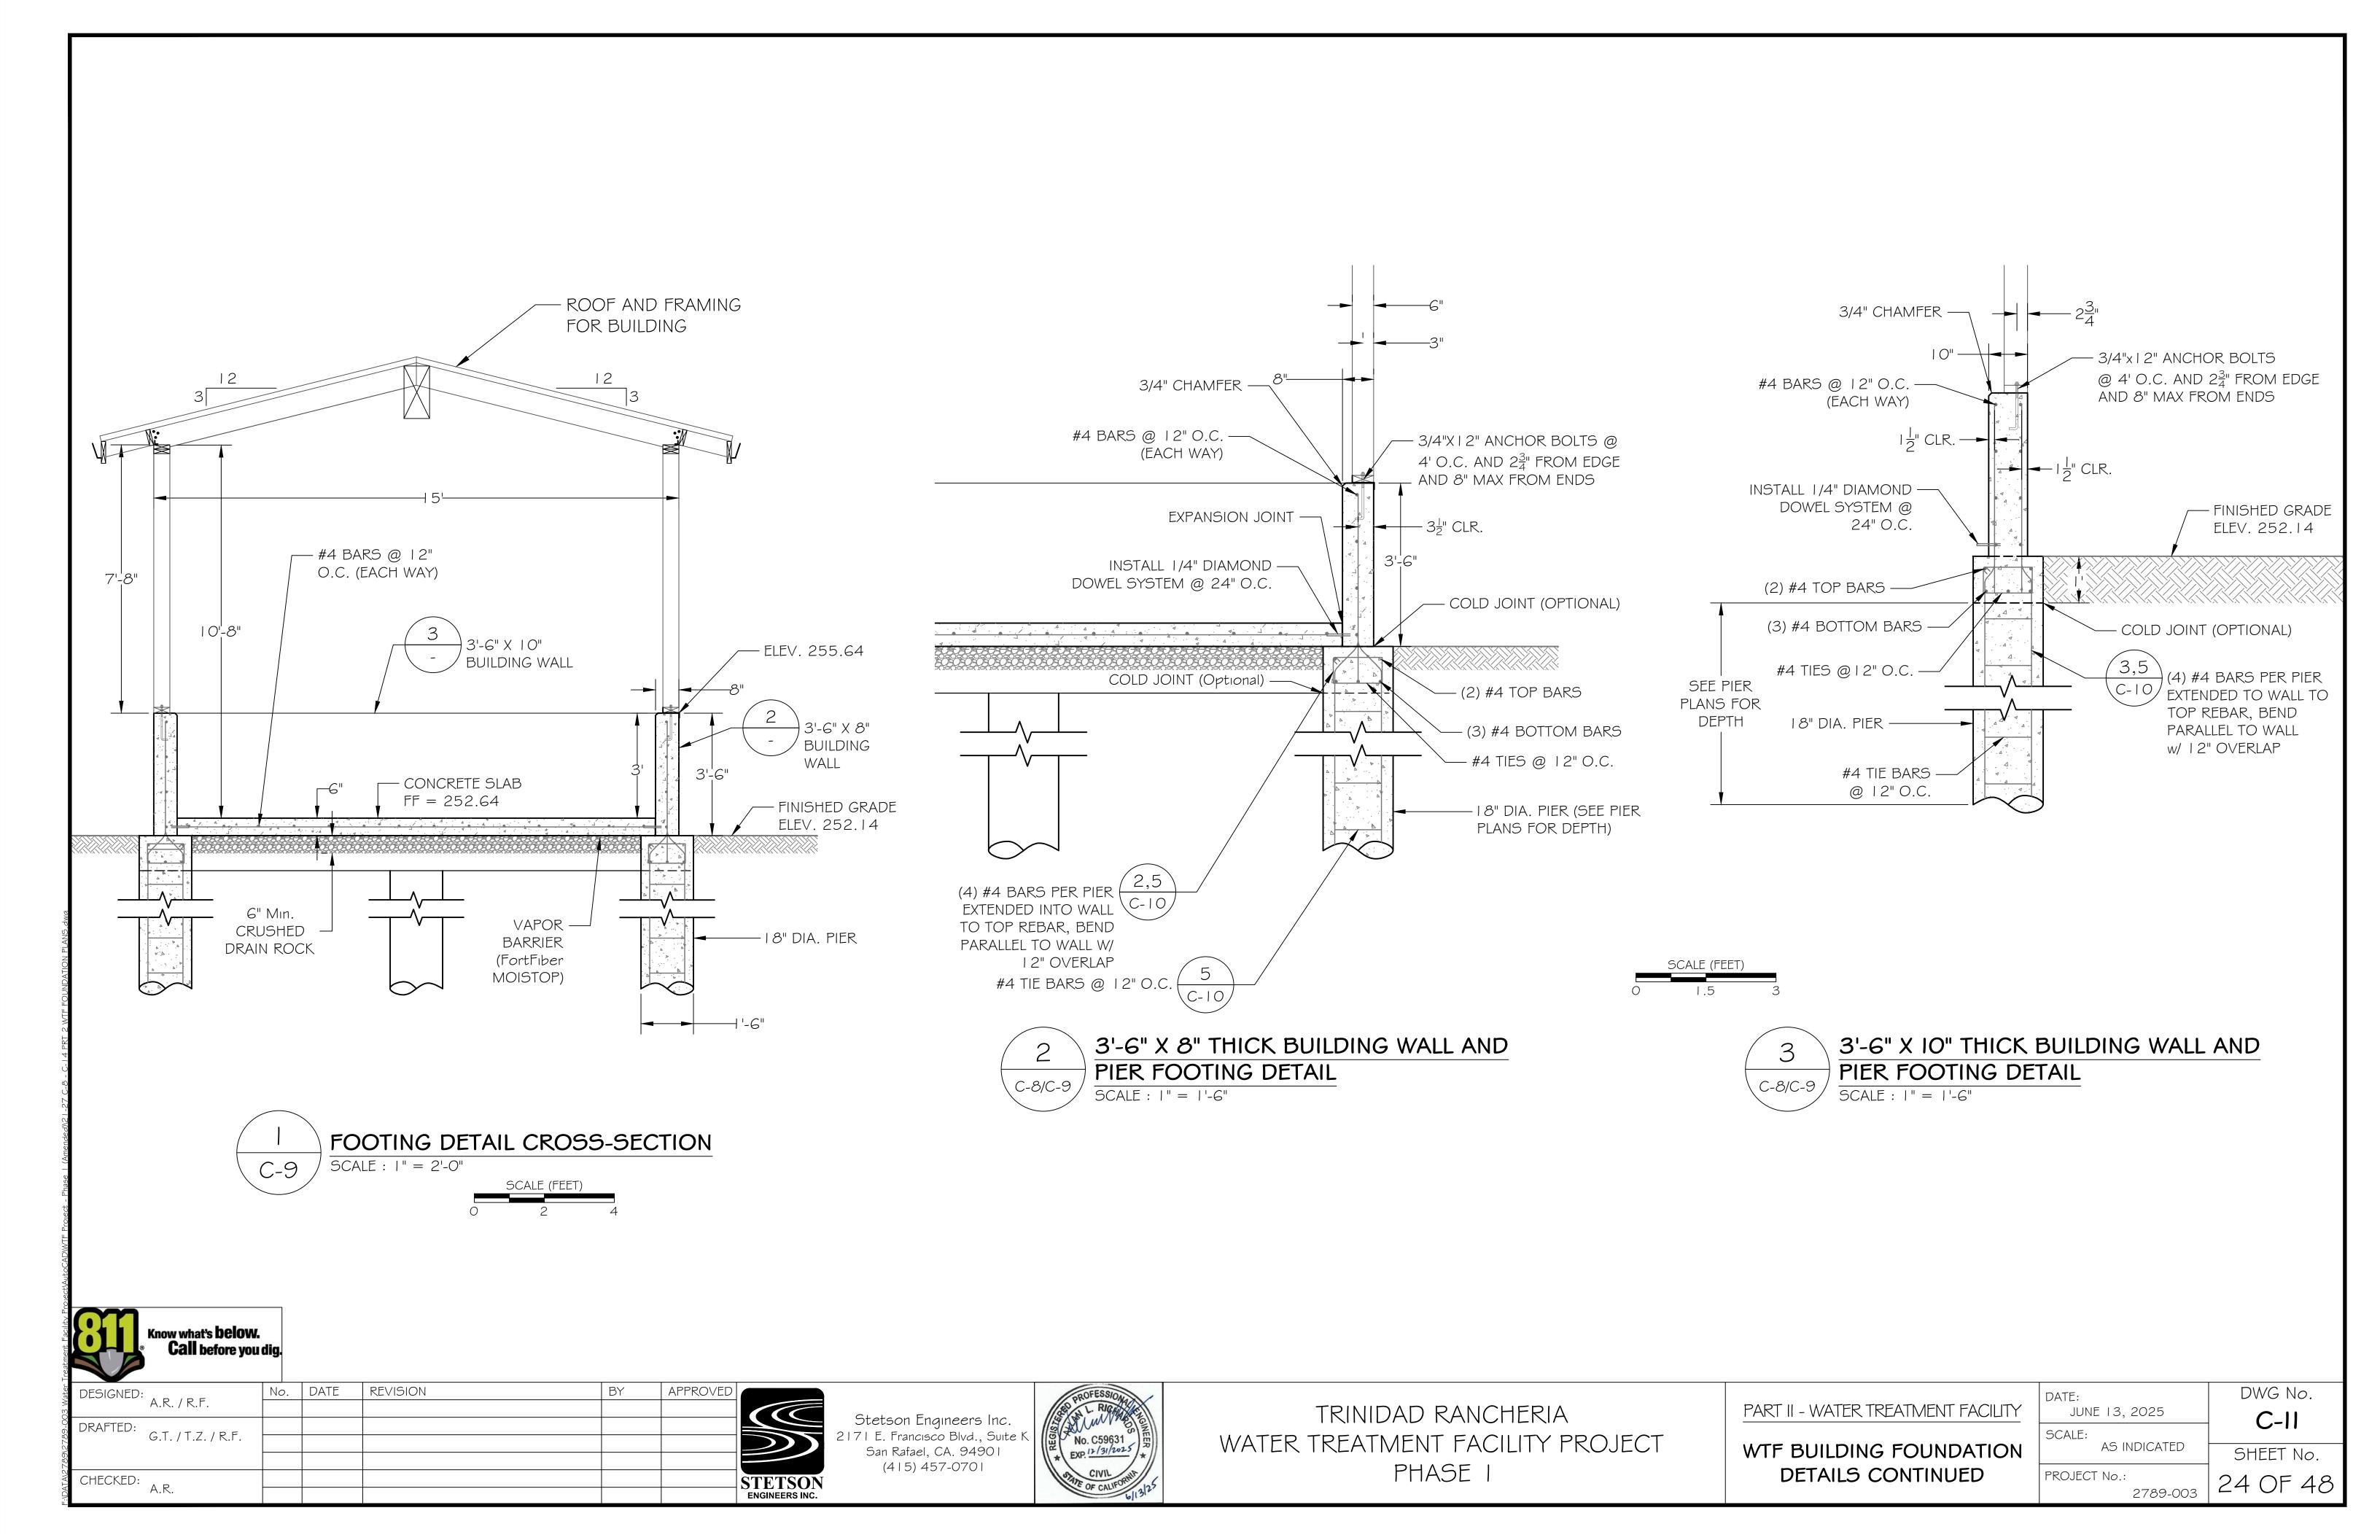



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Stetson Engineers Inc. 2171 E. Francisco Blvd., Suite K San Rafael, CA. 94901 (415) 457-0701



TRINIDAD RANCHERIA
WATER TREATMENT FACILITY PROJECT
PHASE I

PART II - WATER TREATMENT FACILITY

WTF TANK FARM			
CONCRETE SLAB AND			
PIER PLAN			

	*	,,,,
Υ	DATE:	DWG No.
	JUNE 13, 2025	C-15

JUNE 13, 2025

SCALE:


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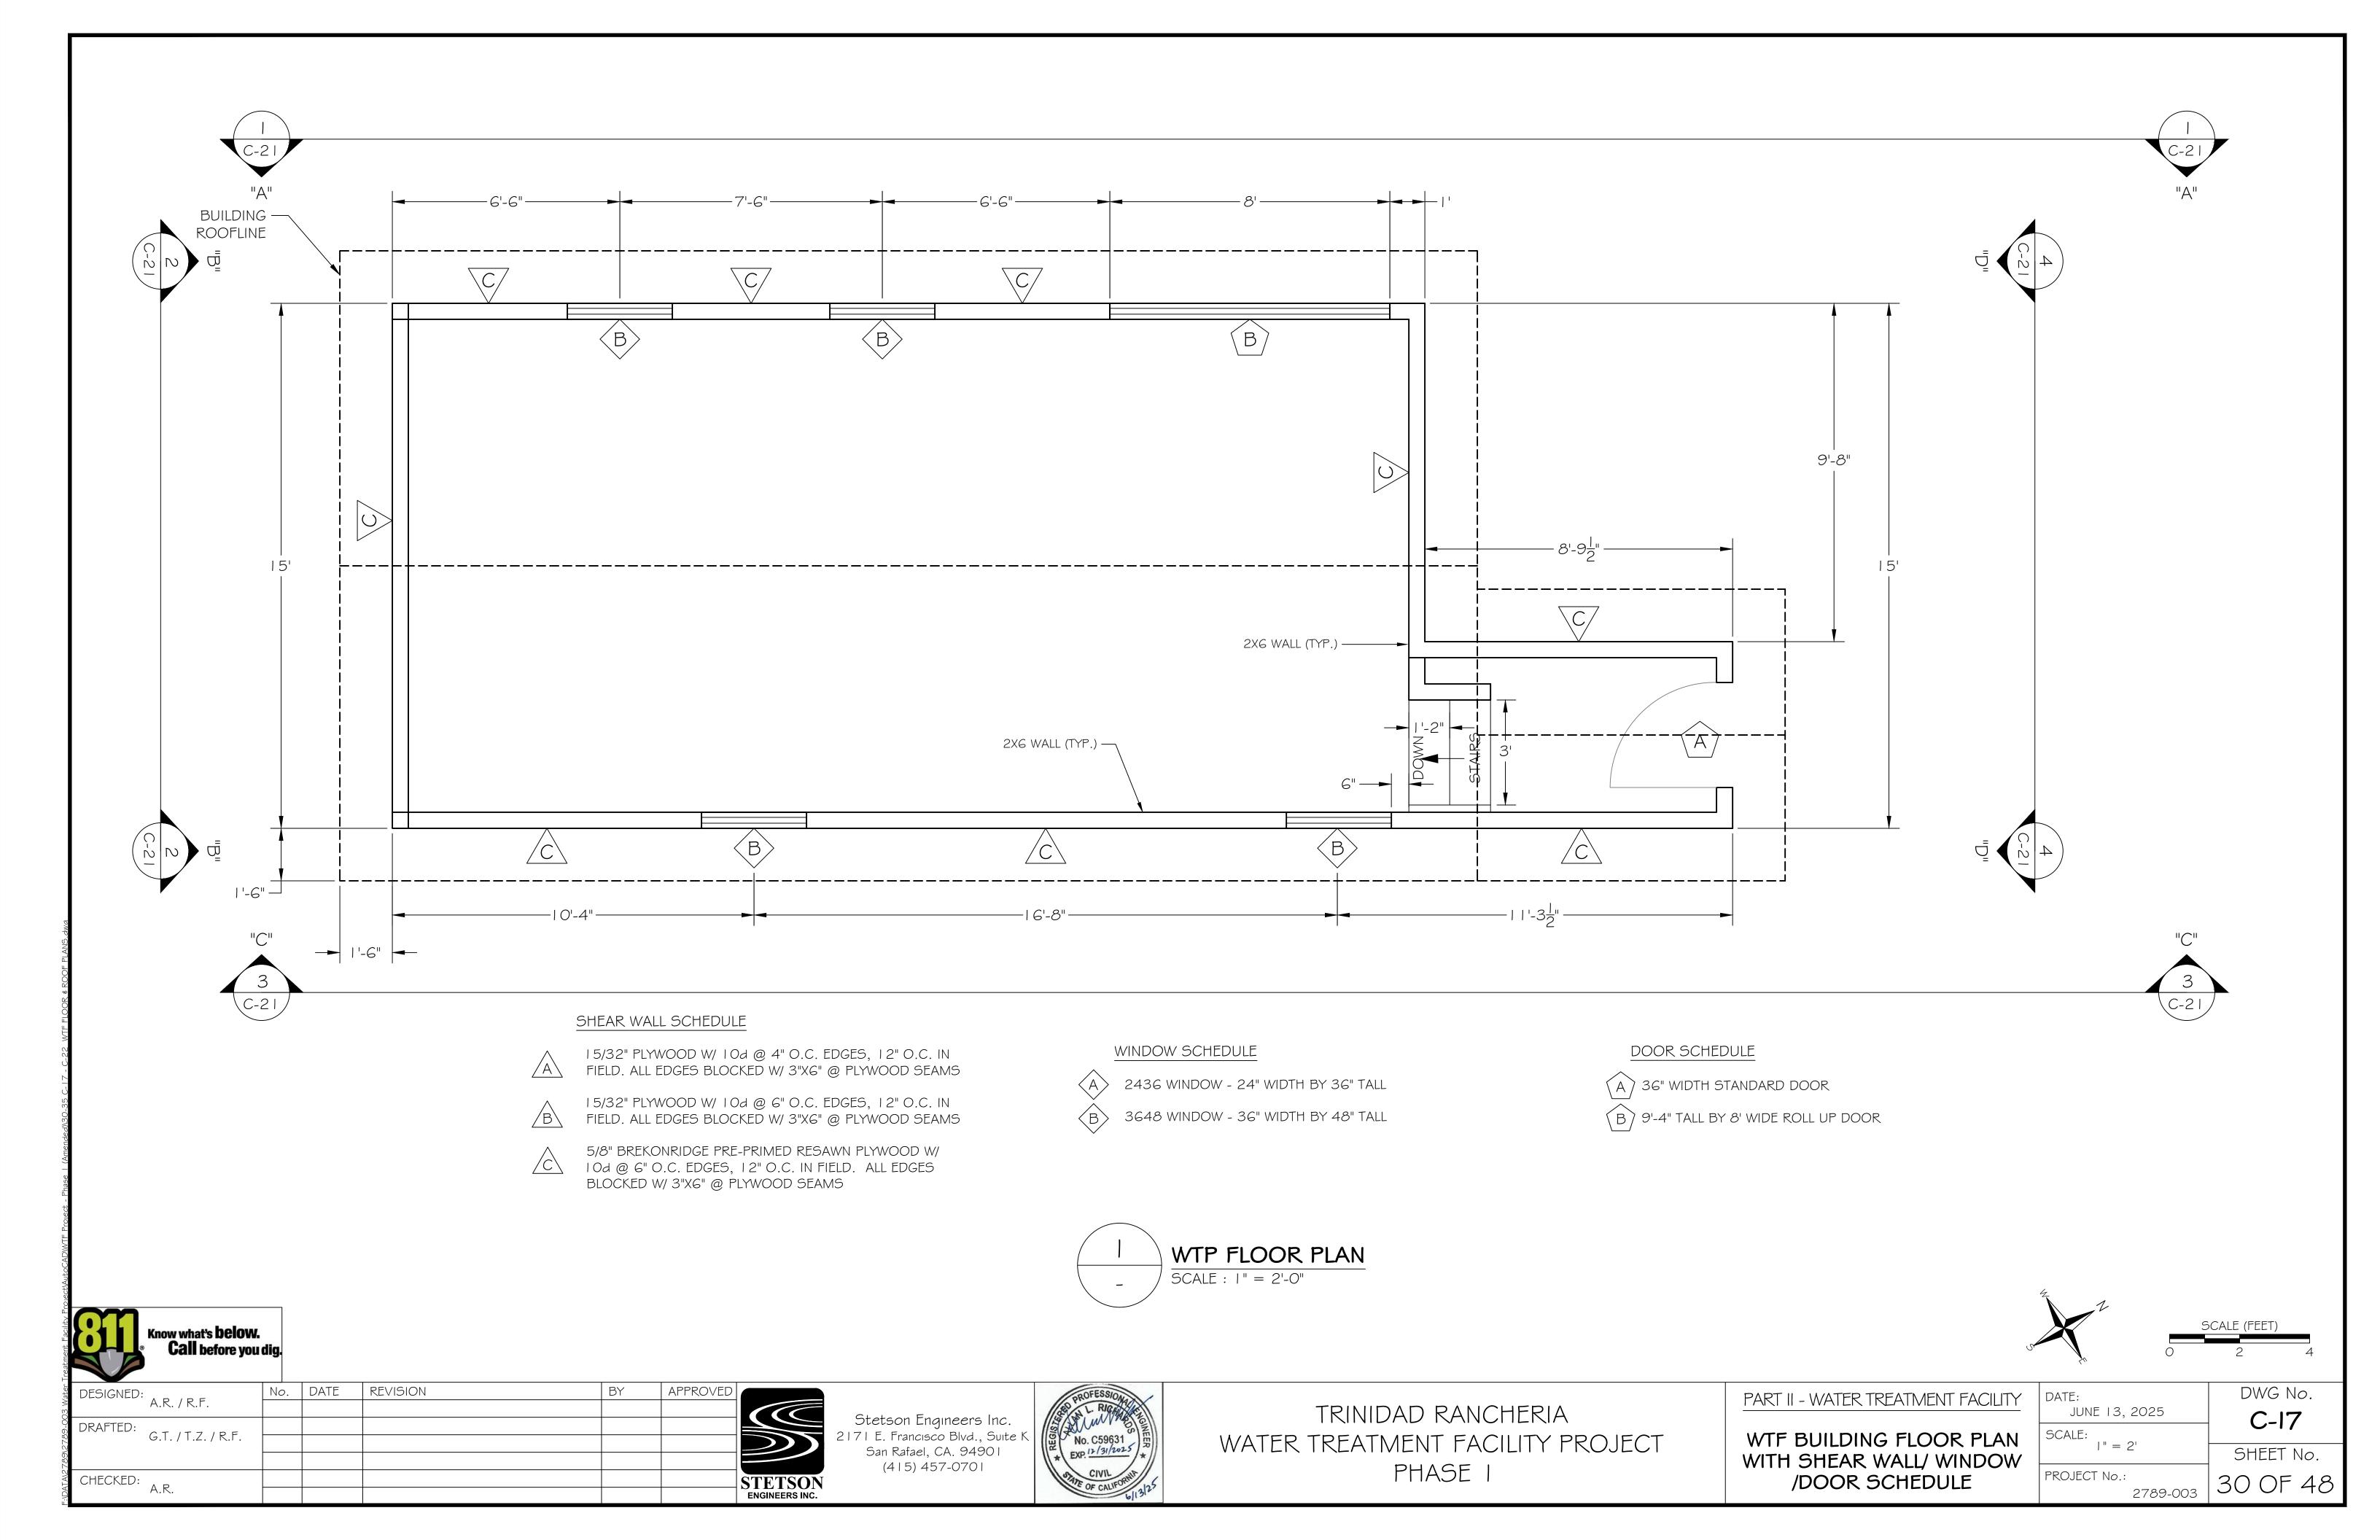
SHEET No.


PROJECT No.:

2789-003

28 OF 48




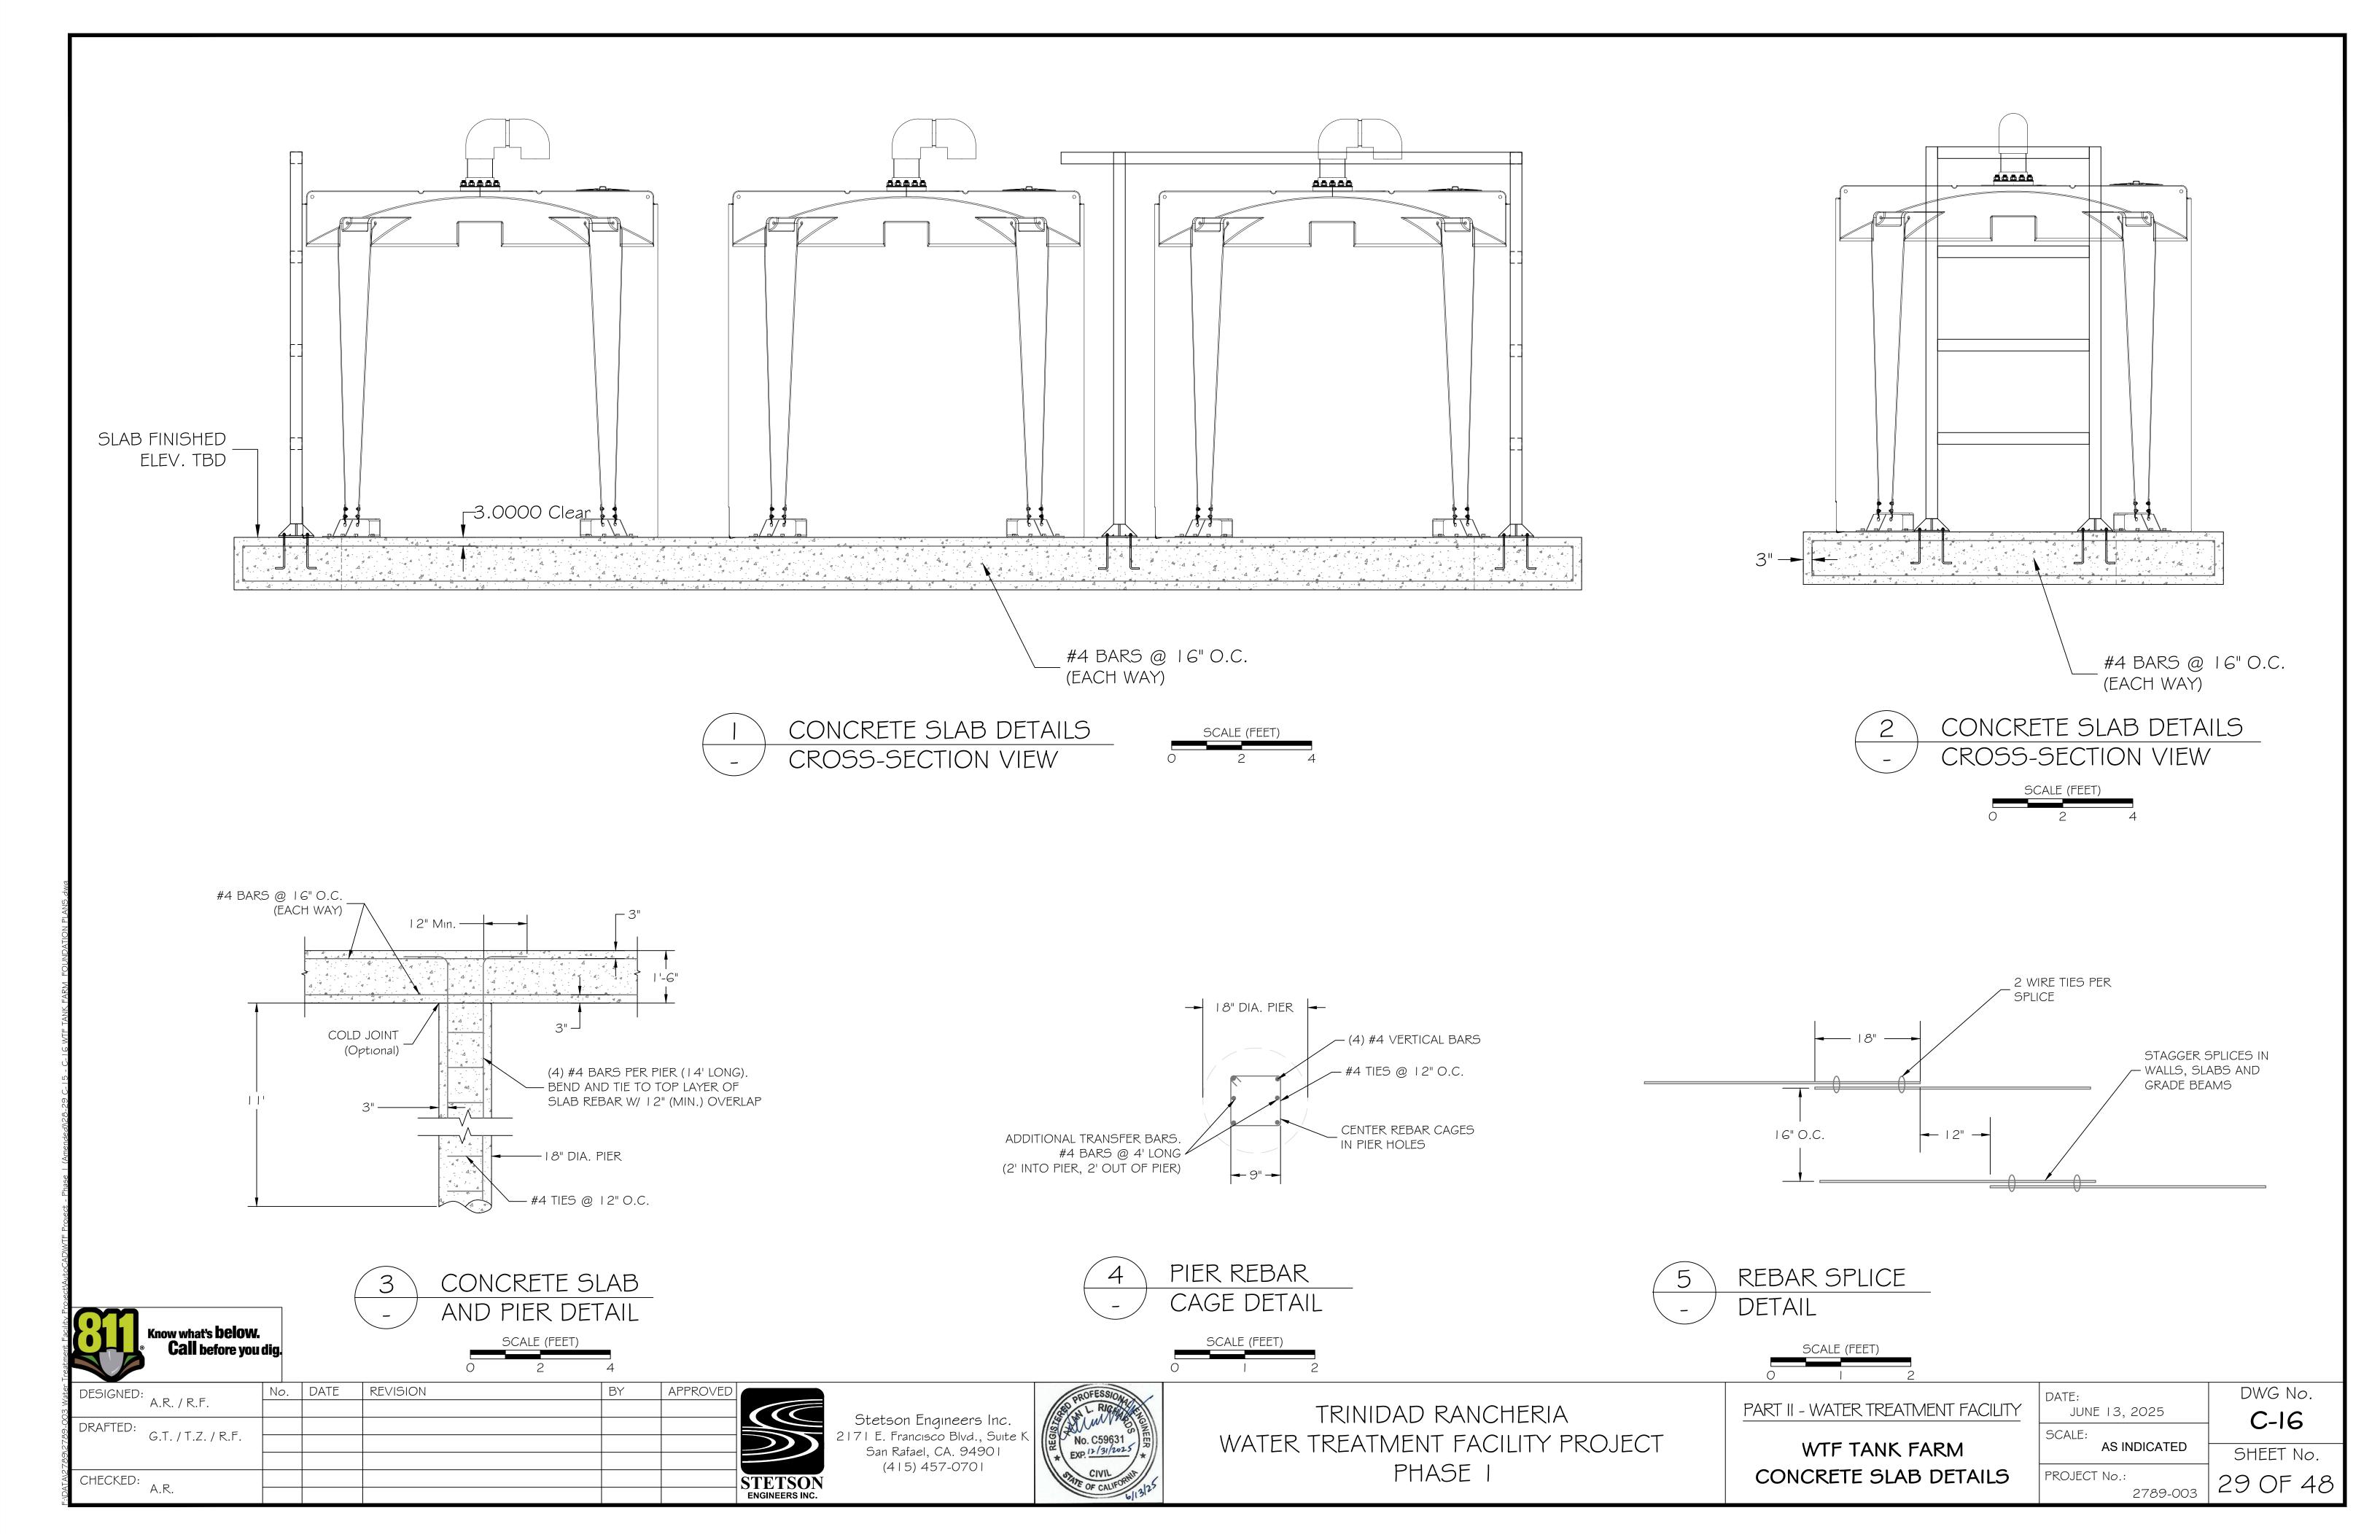

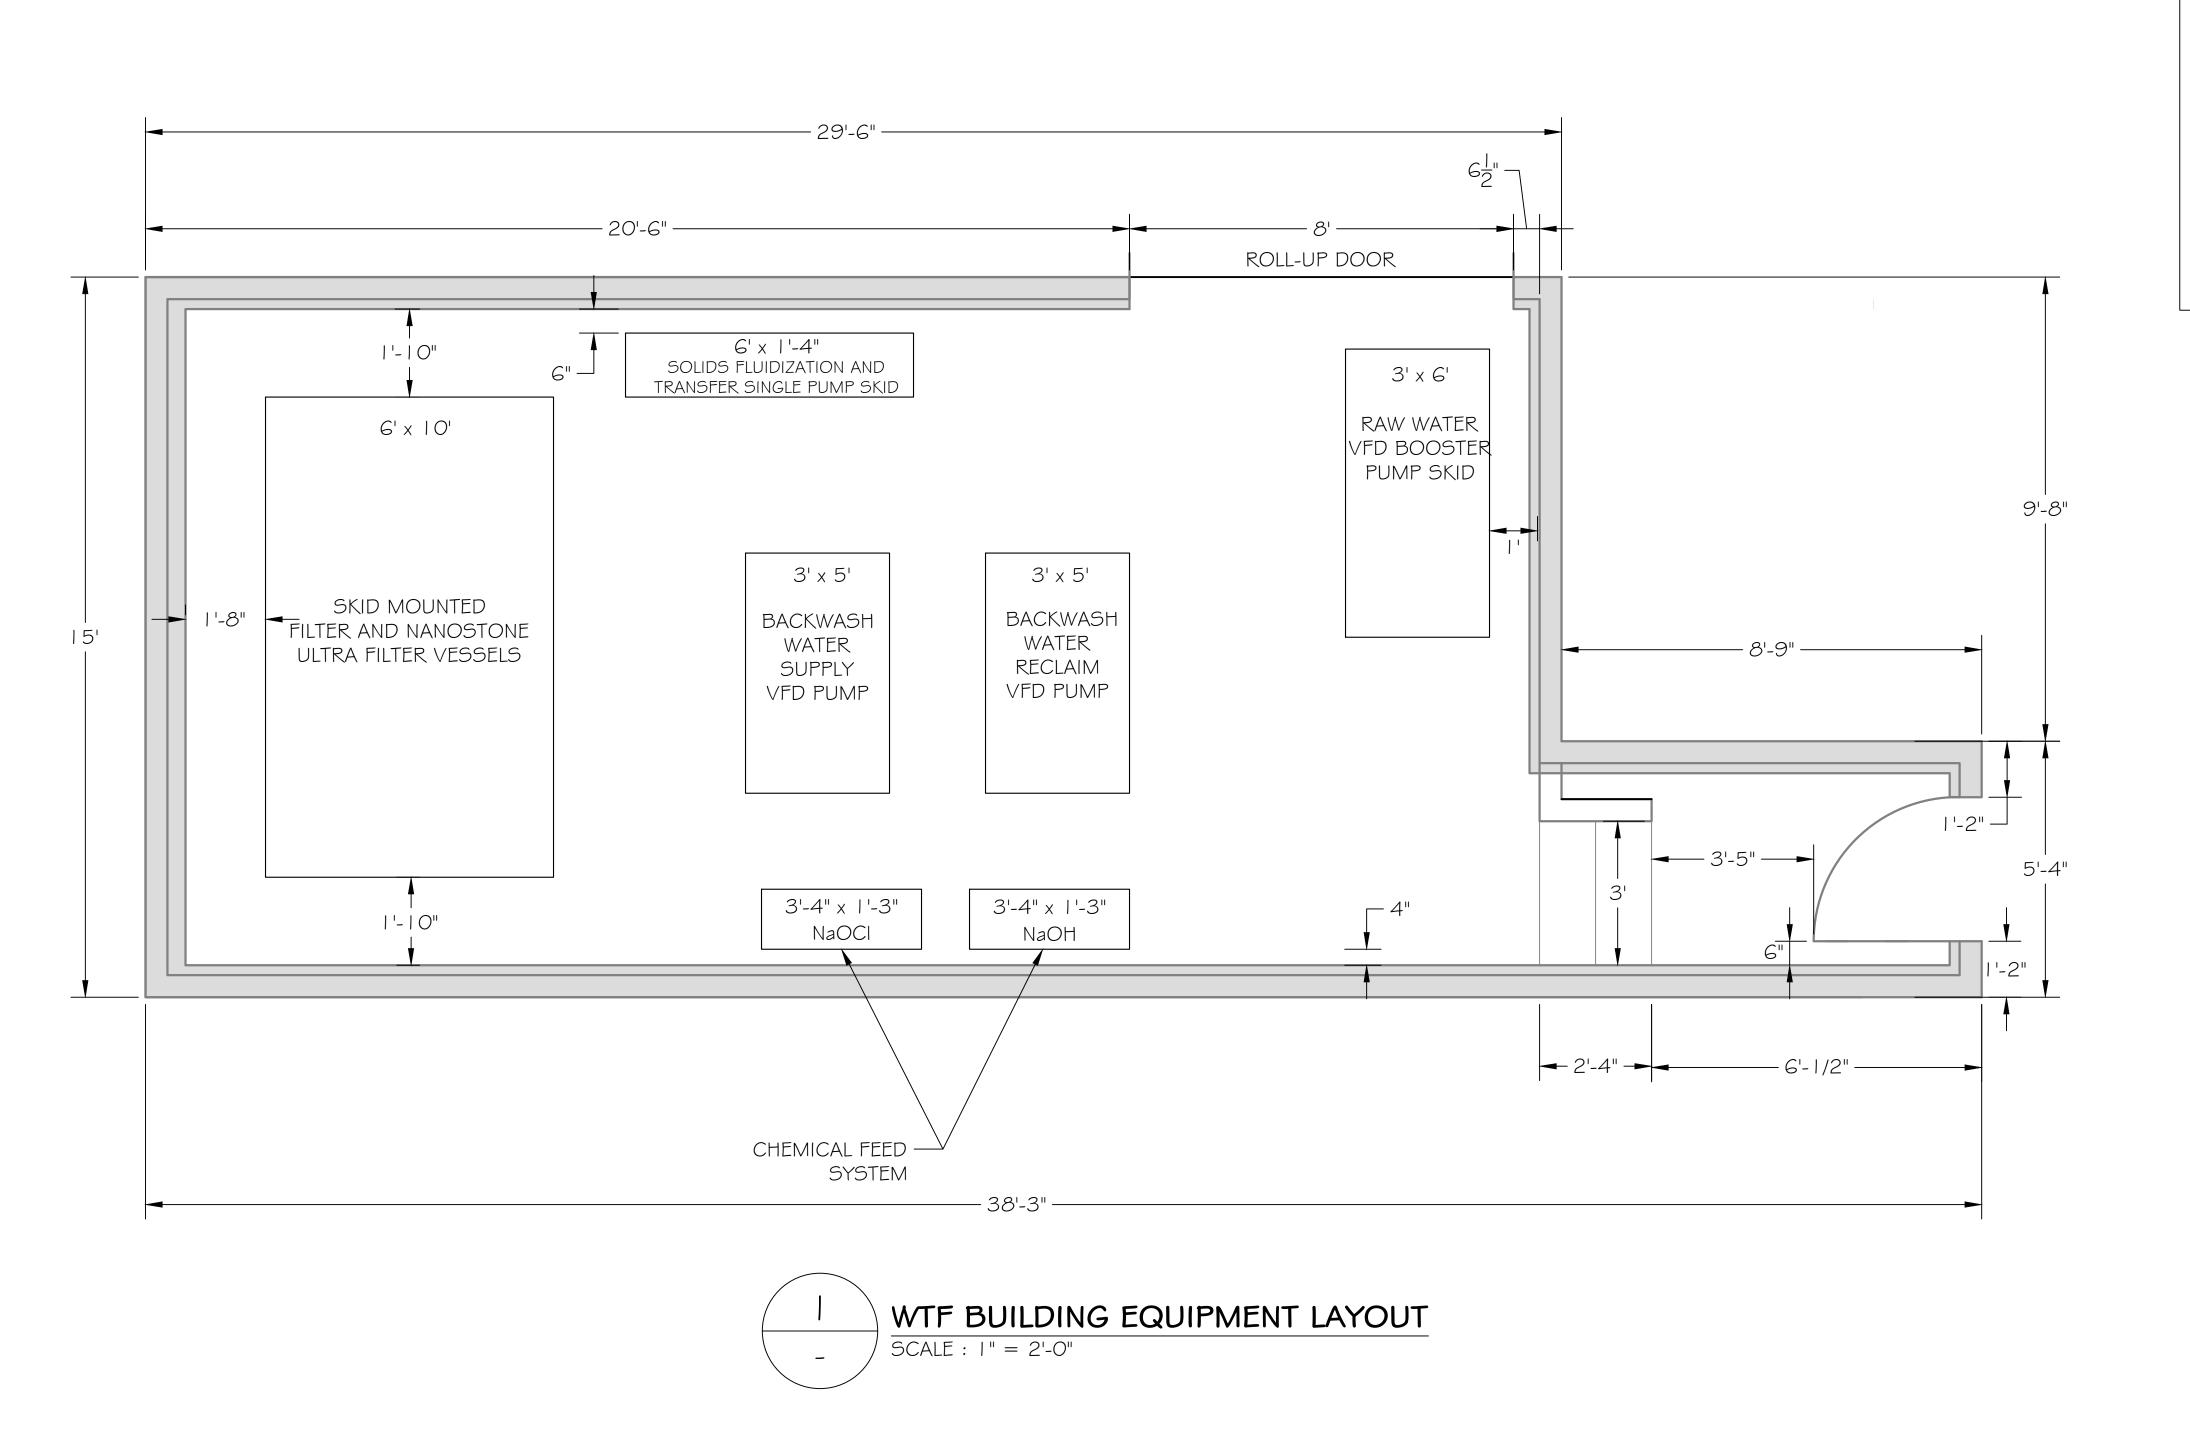

NOTE:

WATER TREATMENT EQUIPMENT LAYOUT AND DETAILS ARE SUBJECT TO CHANGE PENDING THE FINALIZED EQUIPMENT DESIGN SUBMITTED BY THE TREATMENT EQUIPMENT VENDOR.

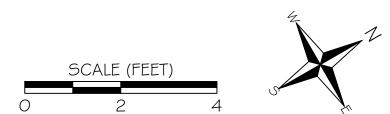

ABBREVIATIONS:

NaOCI SODIUM HYPOCHLORITE

NaOH SODIUM HYDROXIDE

DESIGNED:
A.R. / R.F.

DRAFTED:
G.T. / T.Z. / R.F.

CHECKED:
A.R. / R.F.

No. DATE REVISION

BY APPROVED

ST.

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(415) 457-0701

STETSON
ENGINEERS INC.



TRINIDAD RANCHERIA
WATER TREATMENT FACILITY PROJECT
PHASE I

PART II - WATER TREATMENT FACILITY


WTF BUILDING EQUIPMENT
LAYOUT


ATE:	DWG No.
JUNE 13, 2025	C-18
CALE:	0-10
I" = 2'	SHEET No


PROJECT No.: 2789-003 SHEET No. 31 OF 48



WATER TREATMENT EQUIPMENT LAYOUT AND DETAILS ARE SUBJECT TO CHANGE PENDING THE FINALIZED EQUIPMENT DESIGN SUBMITTED BY THE TREATMENT EQUIPMENT VENDOR.

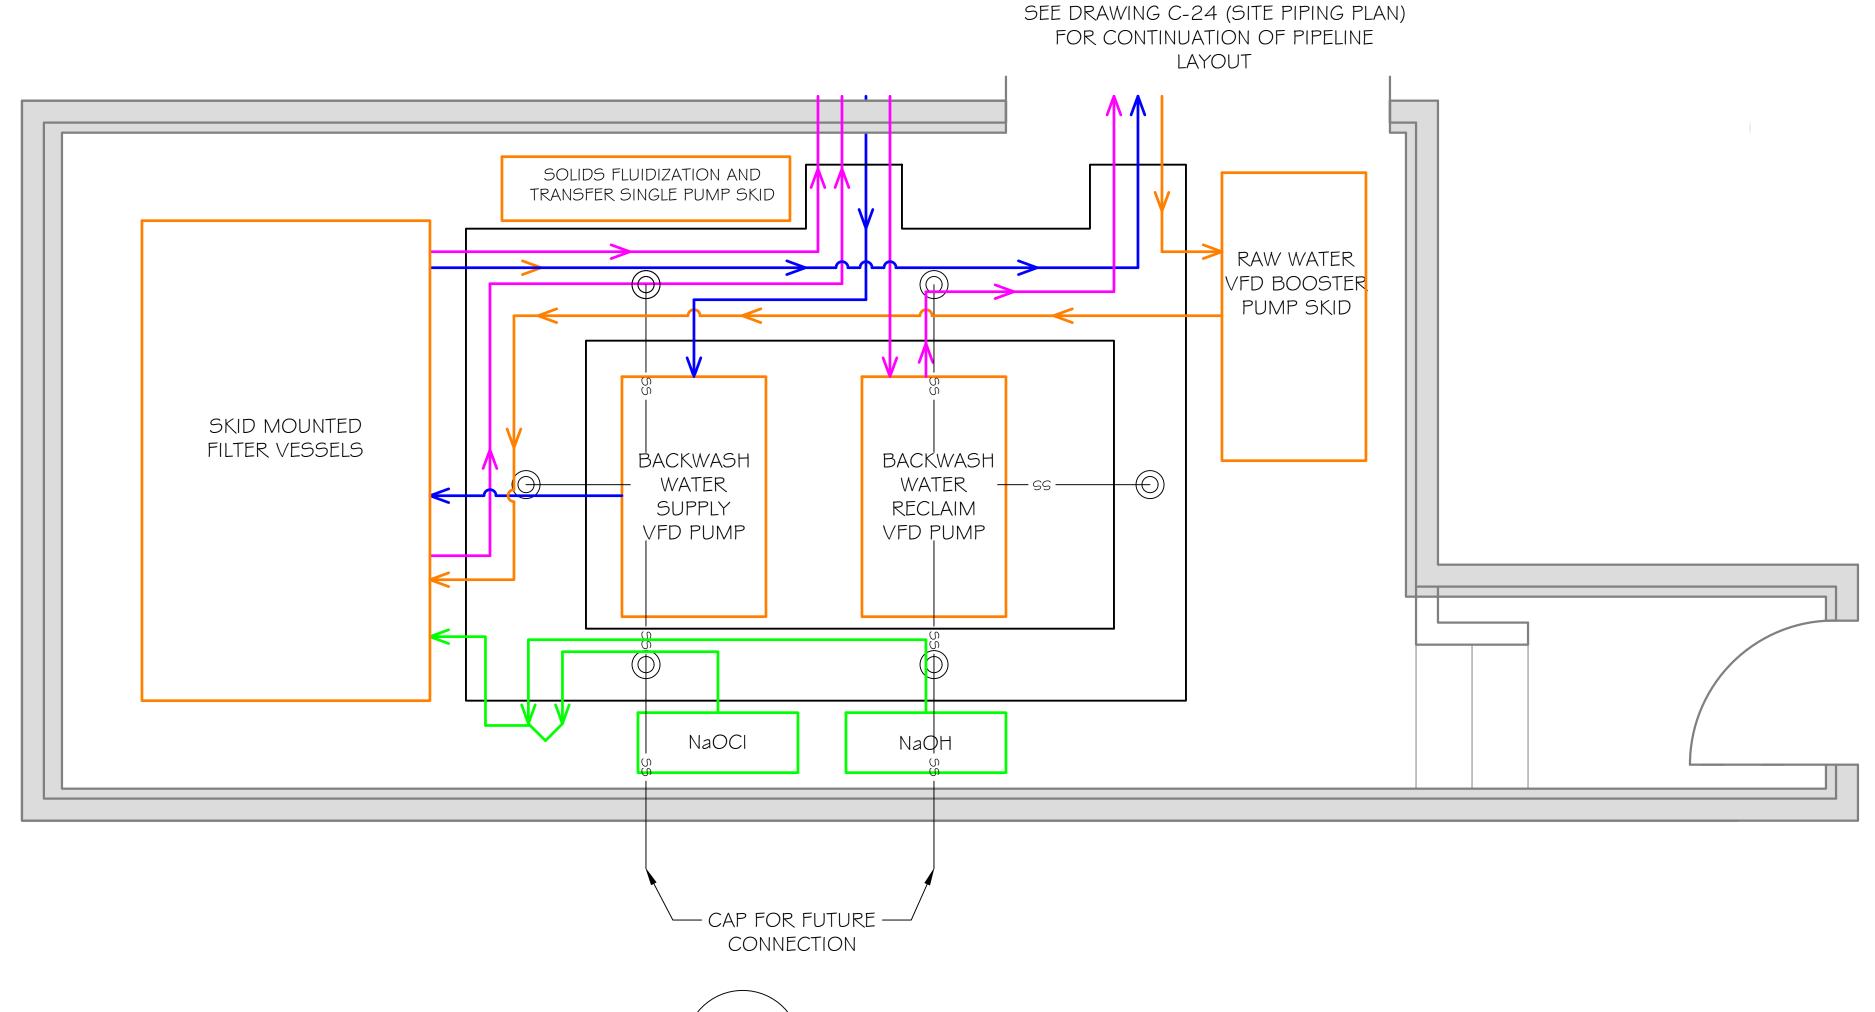

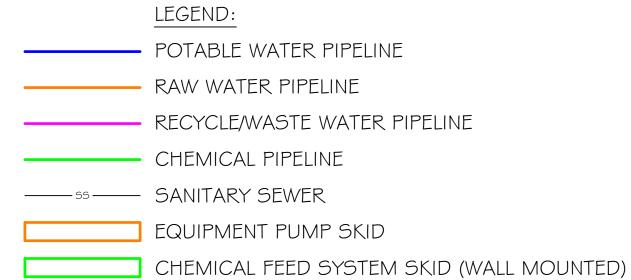

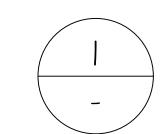

WTP BUILDING PIPELINES LAYOUT SCALE : I" = 2'-0"

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	A.R. / R.F.						
DRAFTED:	G.T. / T.Z. / R.F.						
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TRINIDAD RANCHERIA WATER TREATMENT FACILITY PROJECT PHASE I

	PART II - WATER TREATMENT FACILITY
- 1	


WTF BUILDING PIPELINES LAYOUT


		SCALE (FEET)			
	C.	0	2	4	
	DATE:		DWG No.		
<u> </u>	JUNE 13, 20	C-	19		


SHEET No.


.. | " = 2' PROJECT No.: 32 OF 48 2789-003




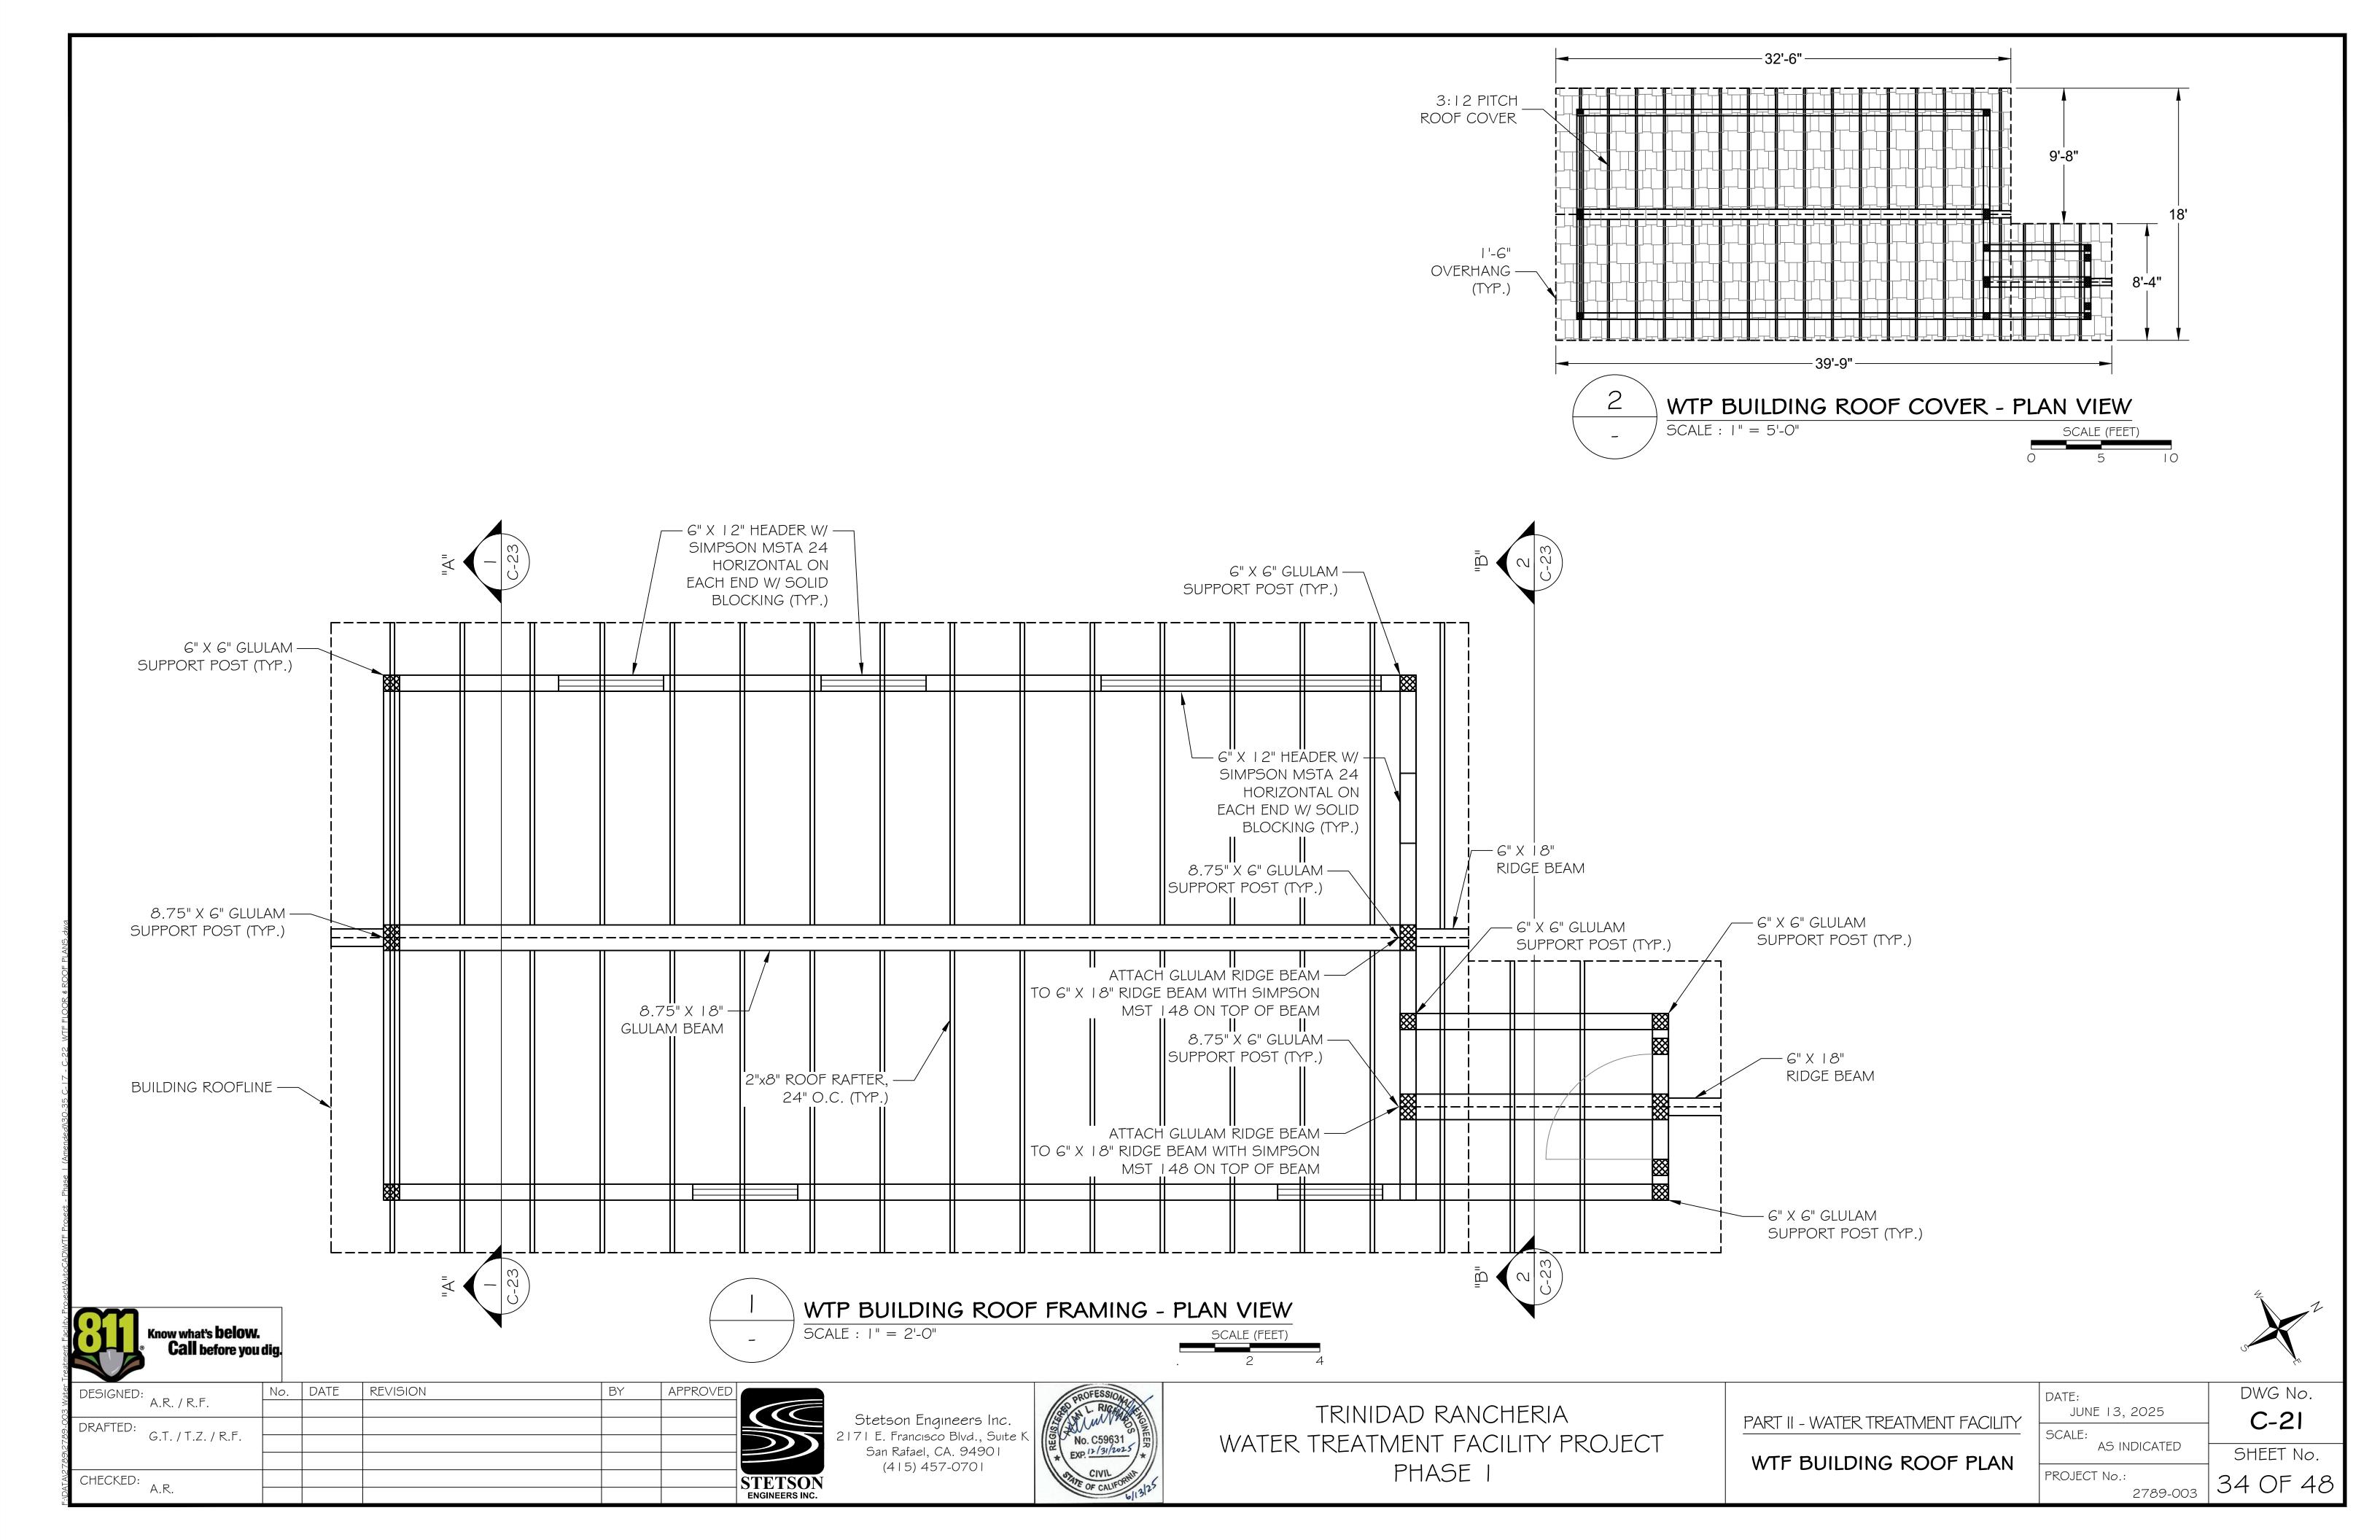


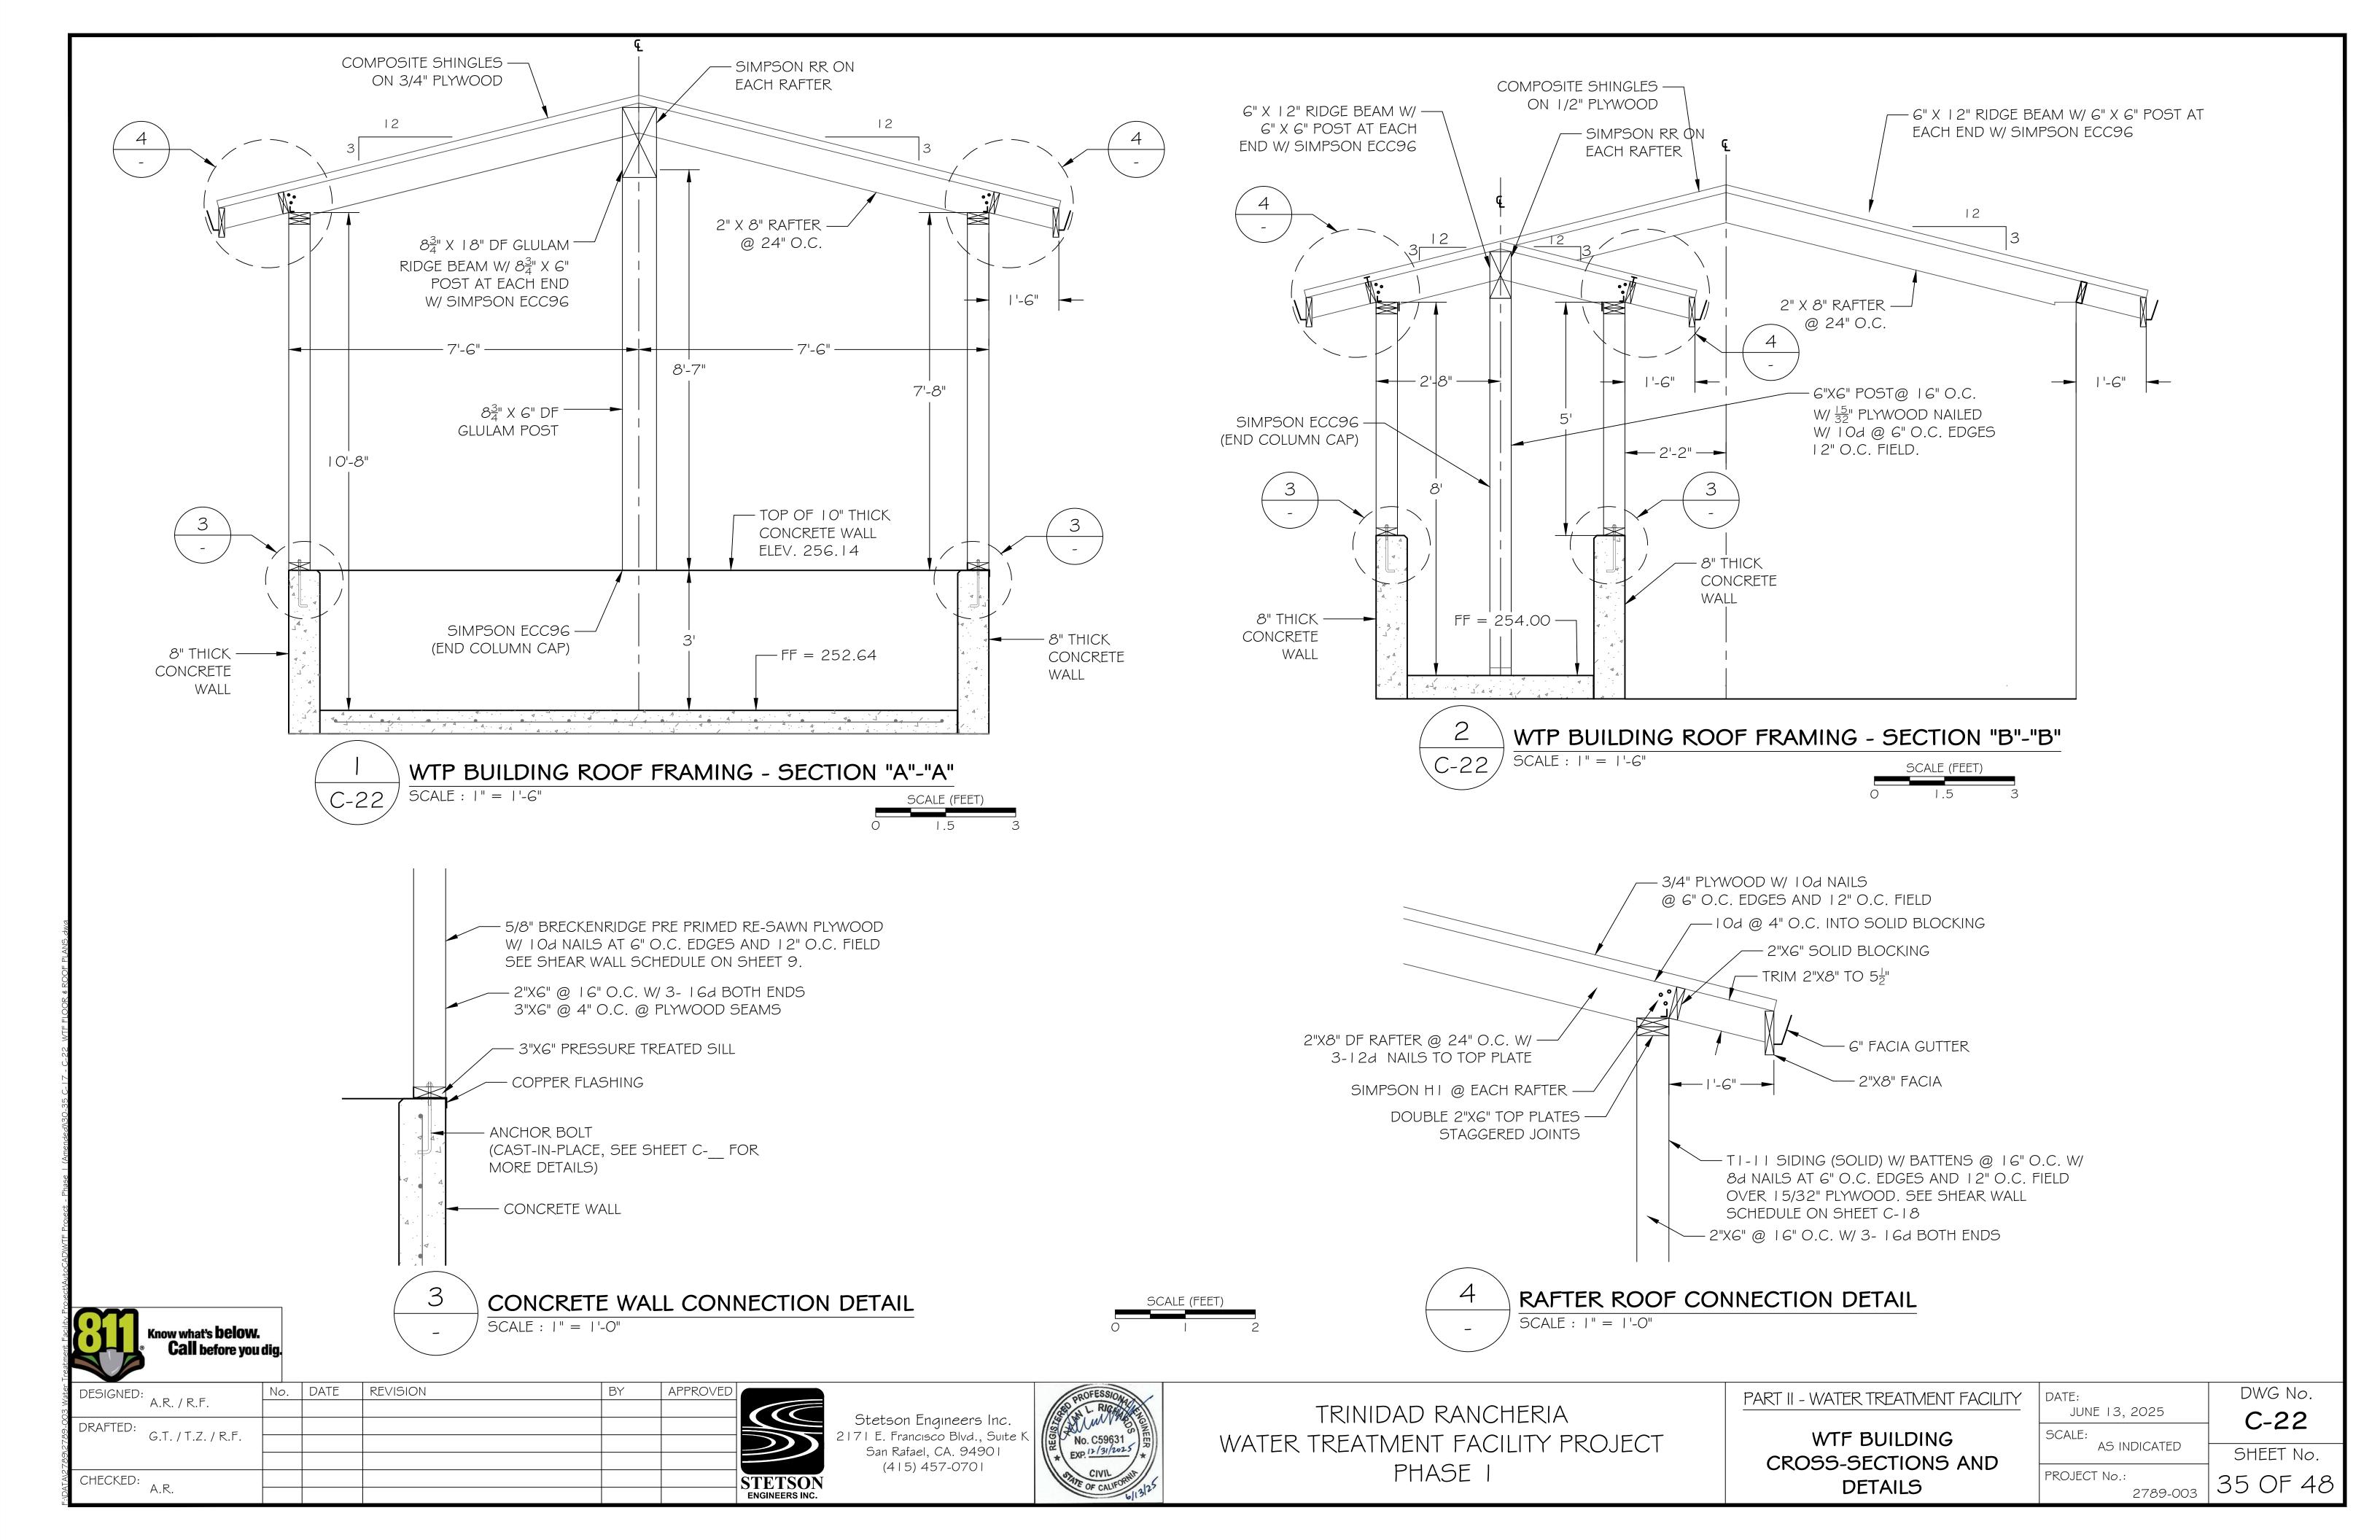


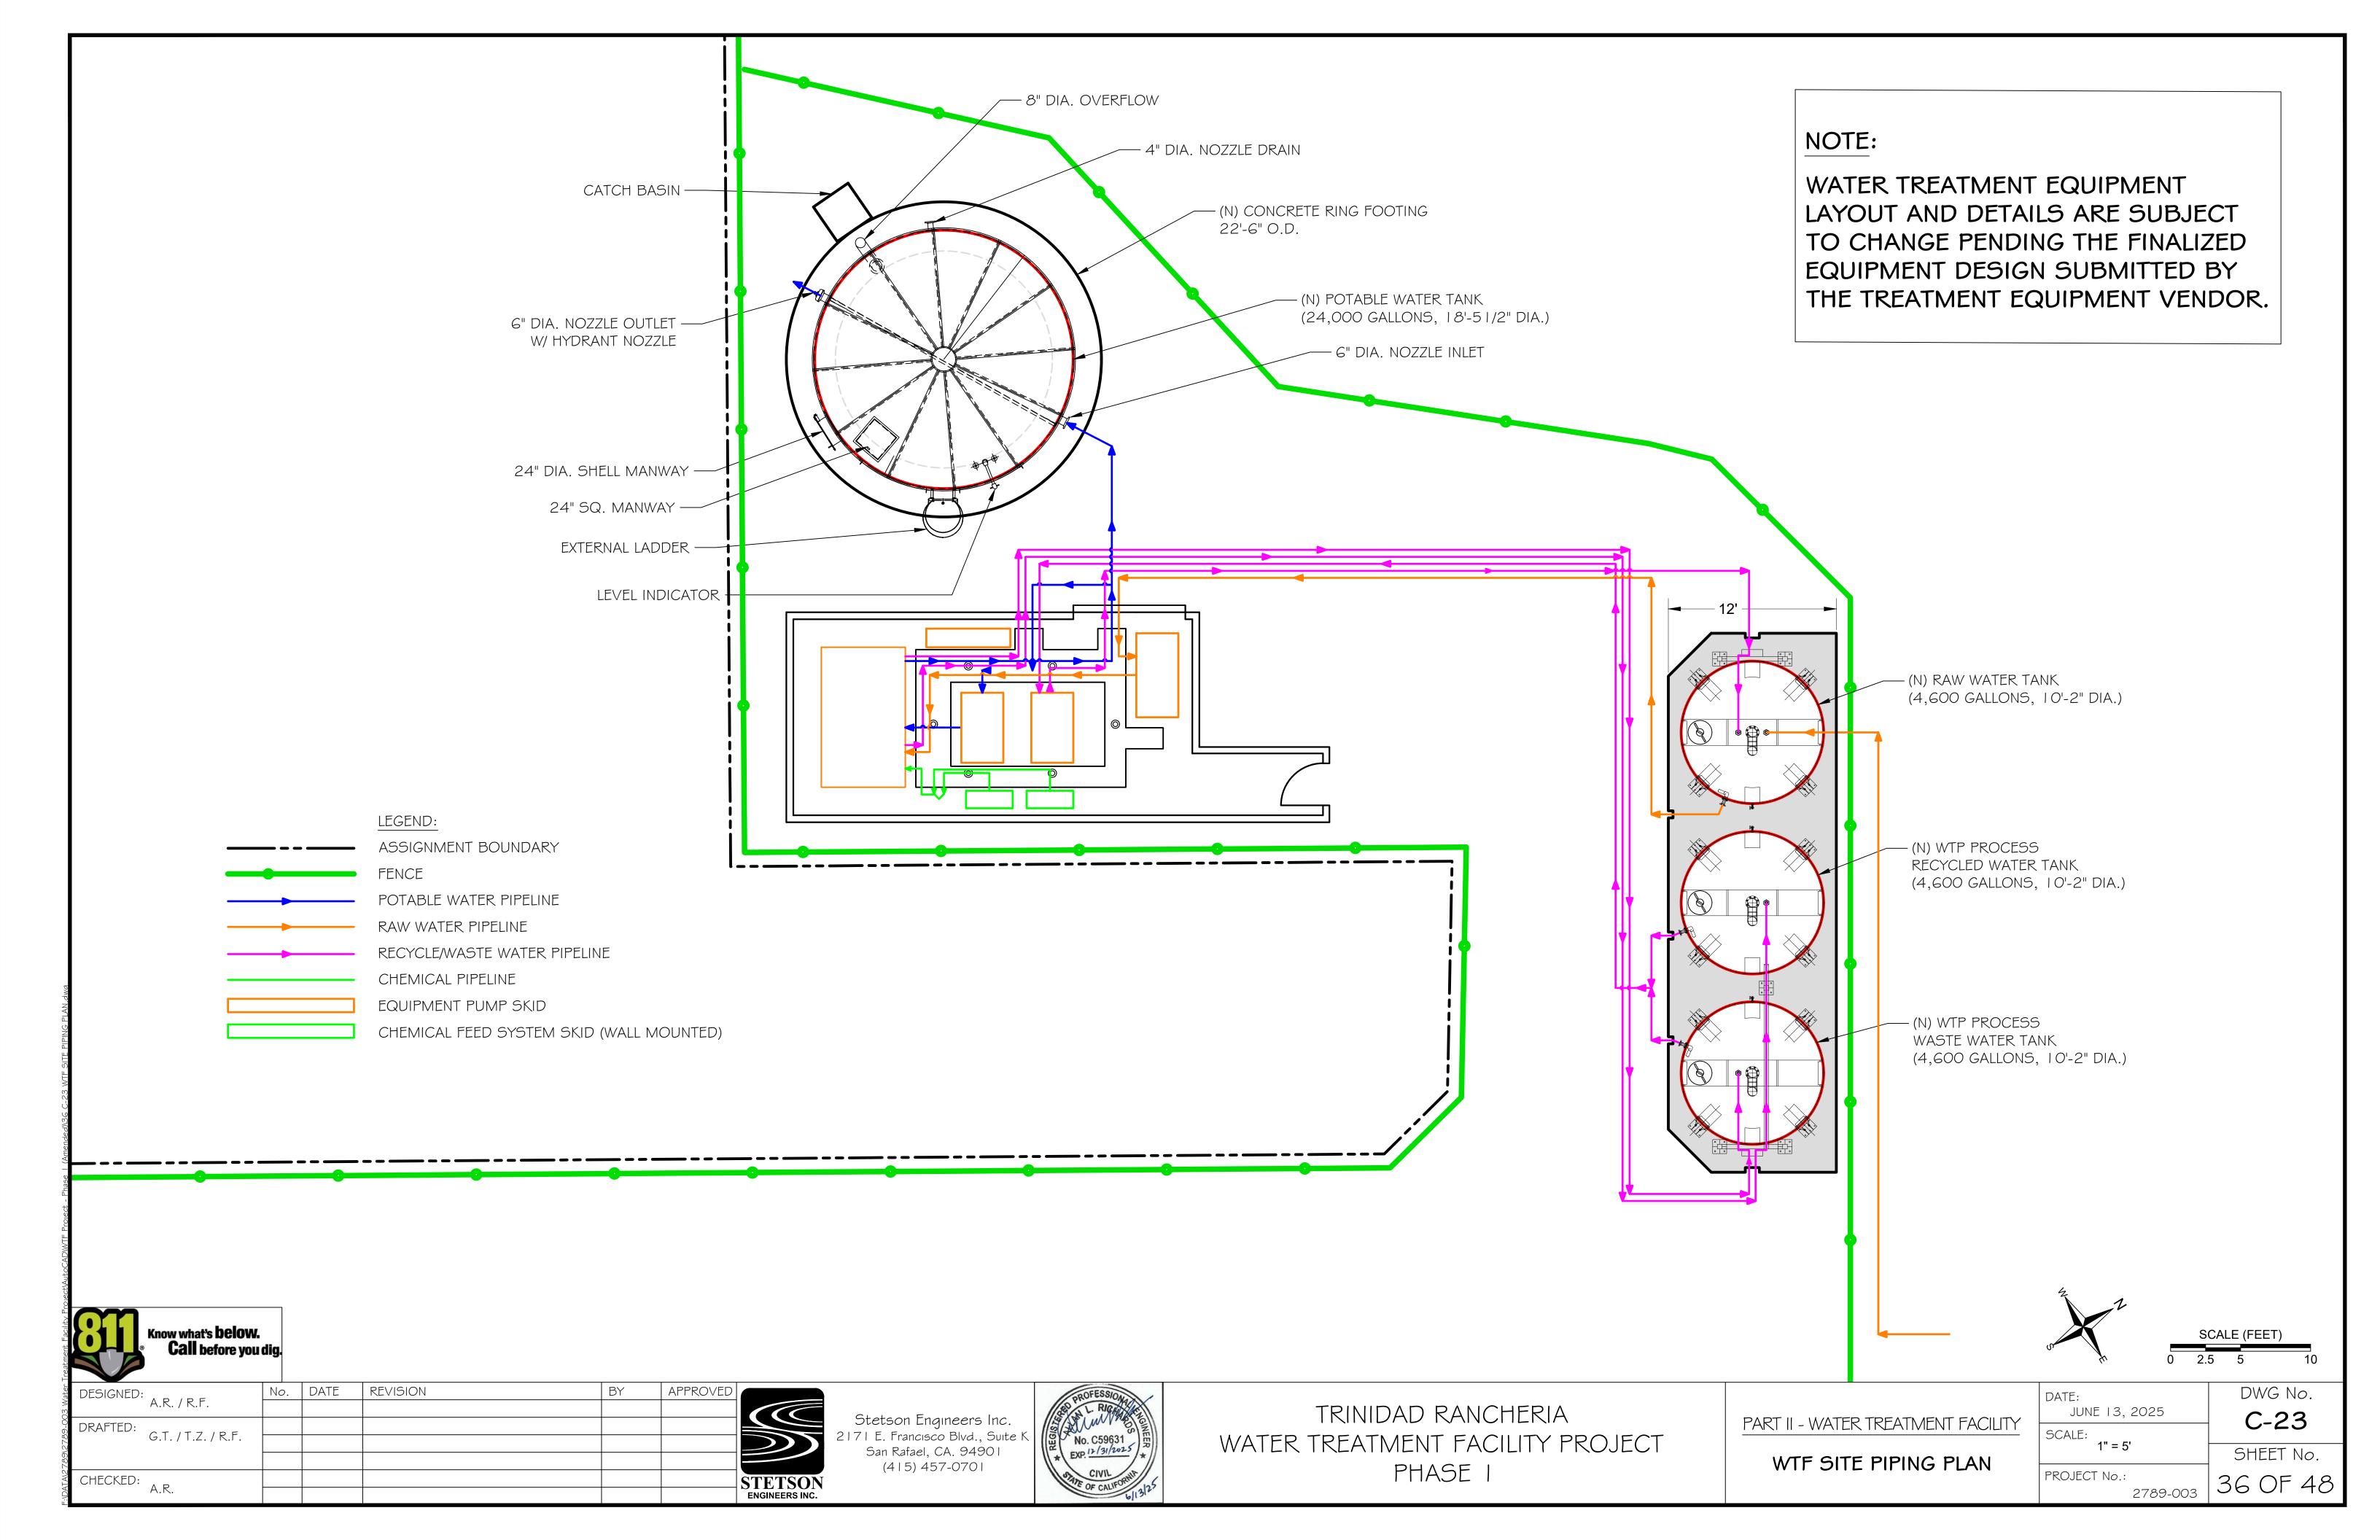

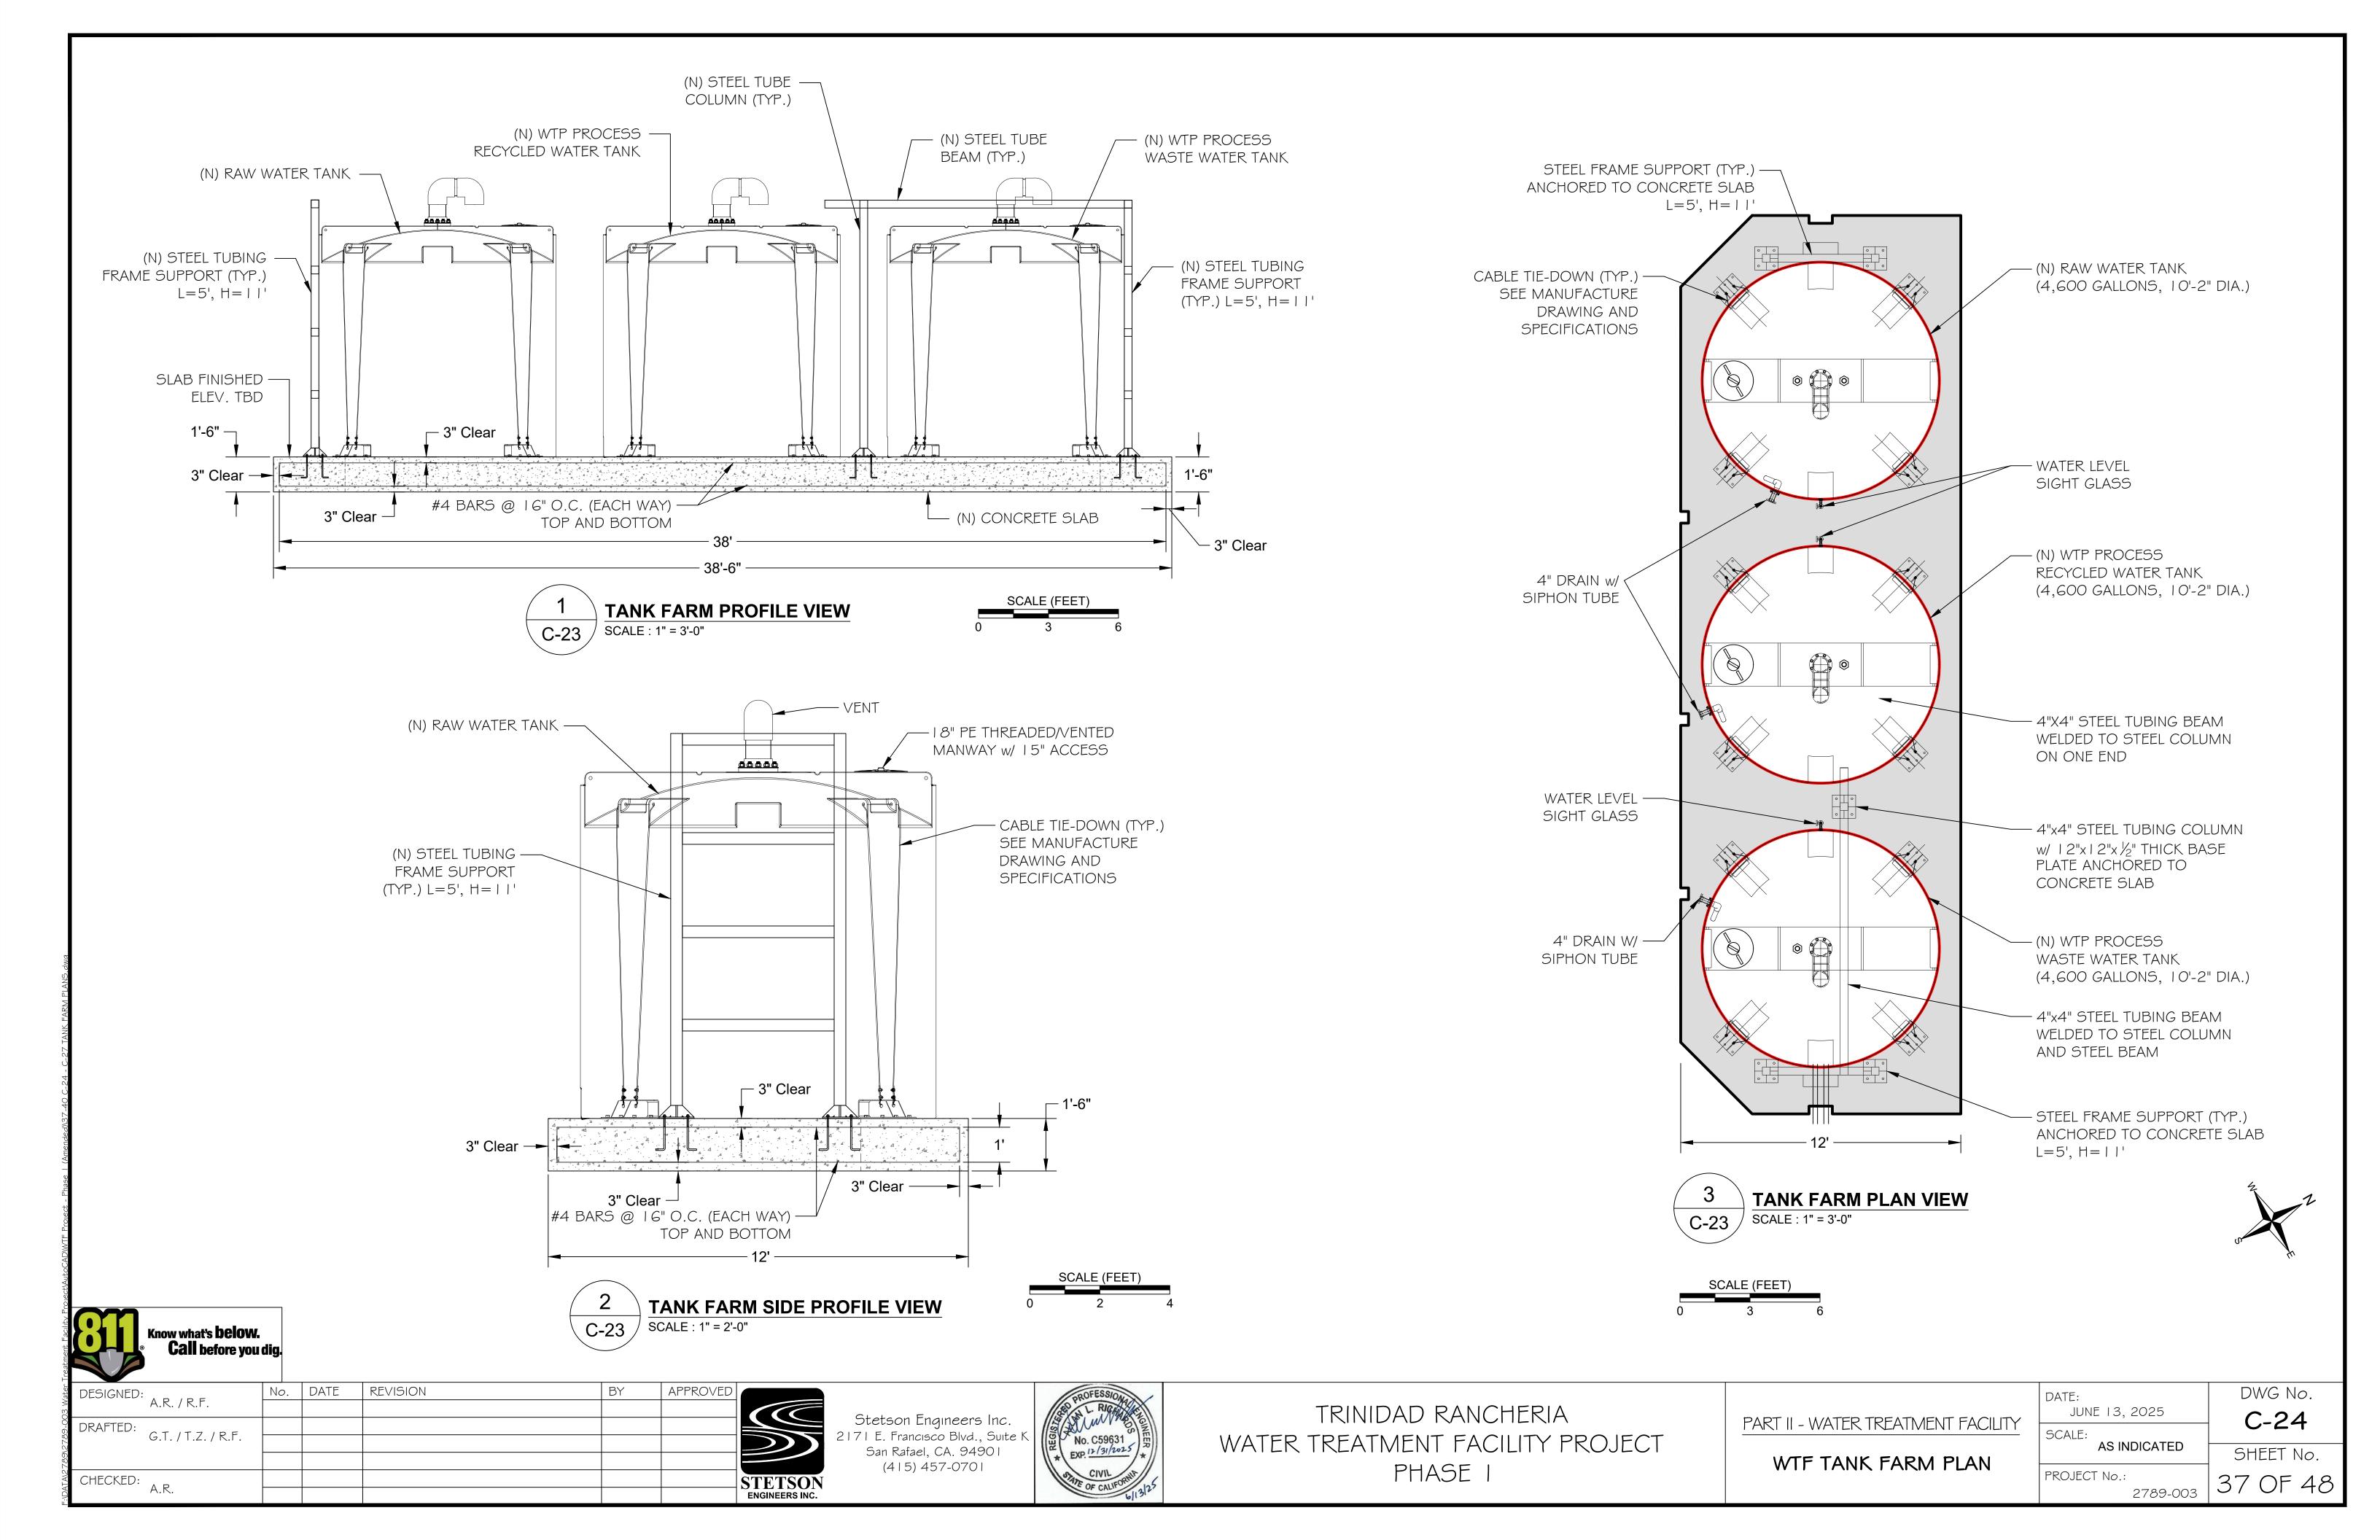

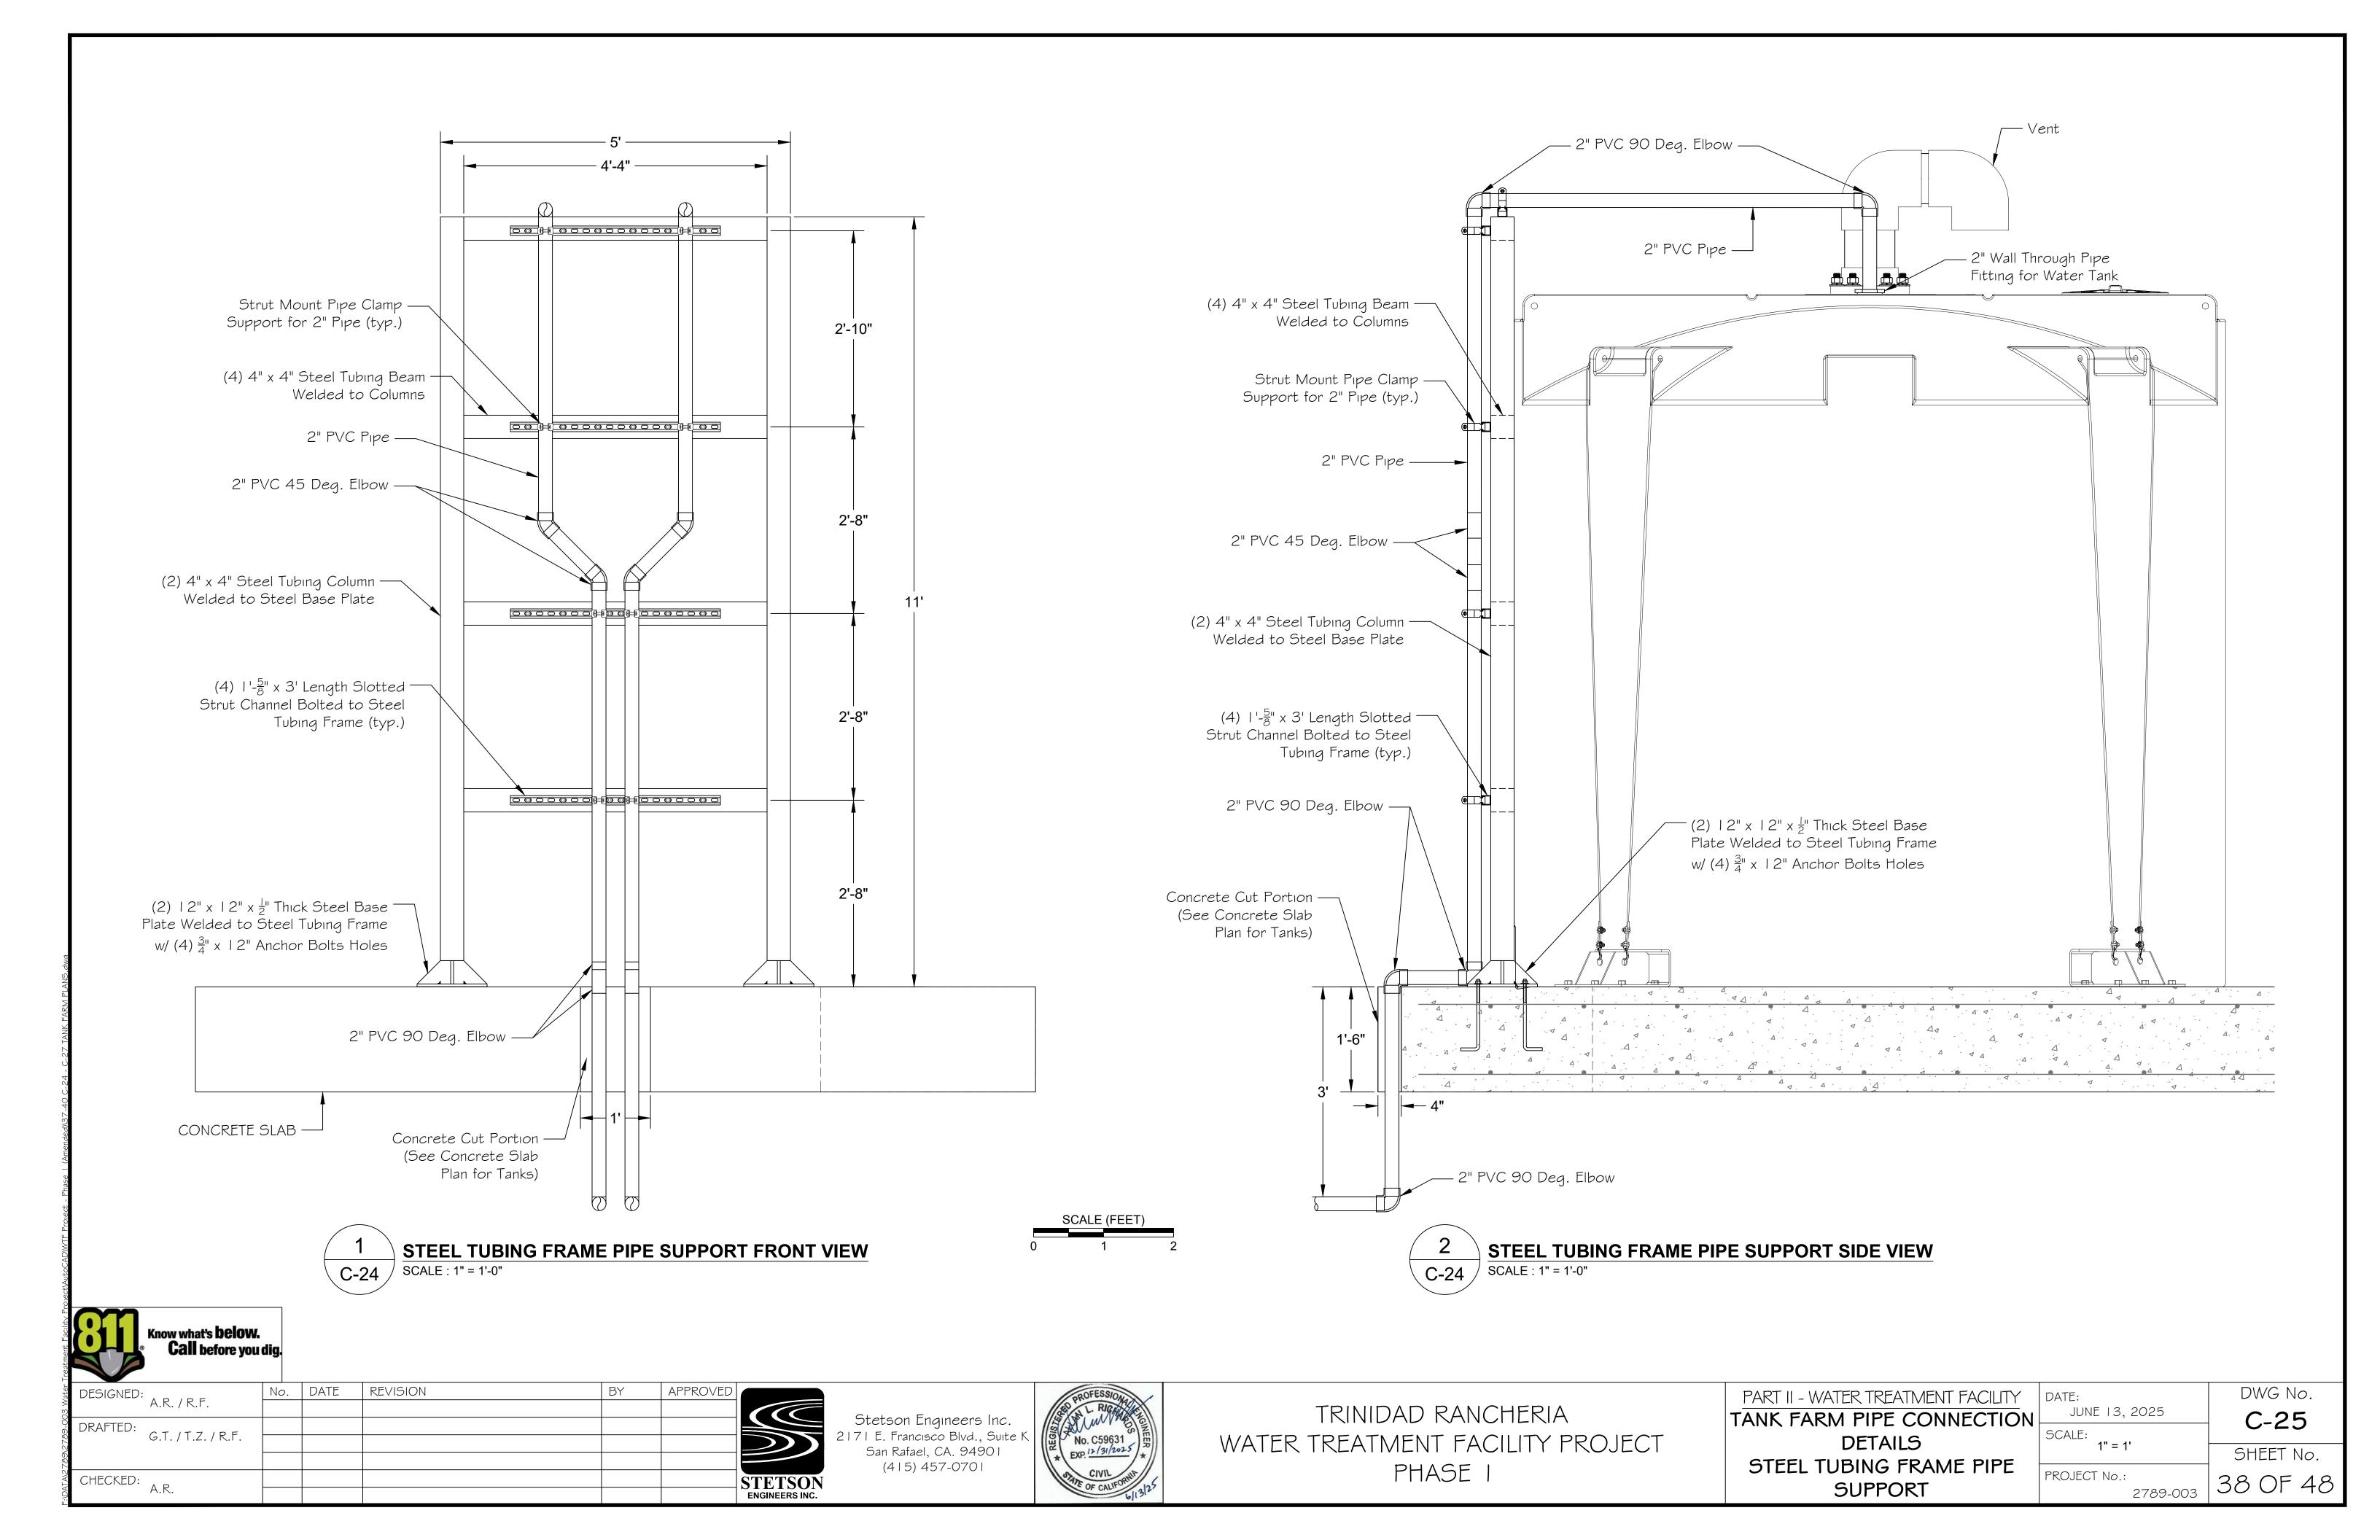

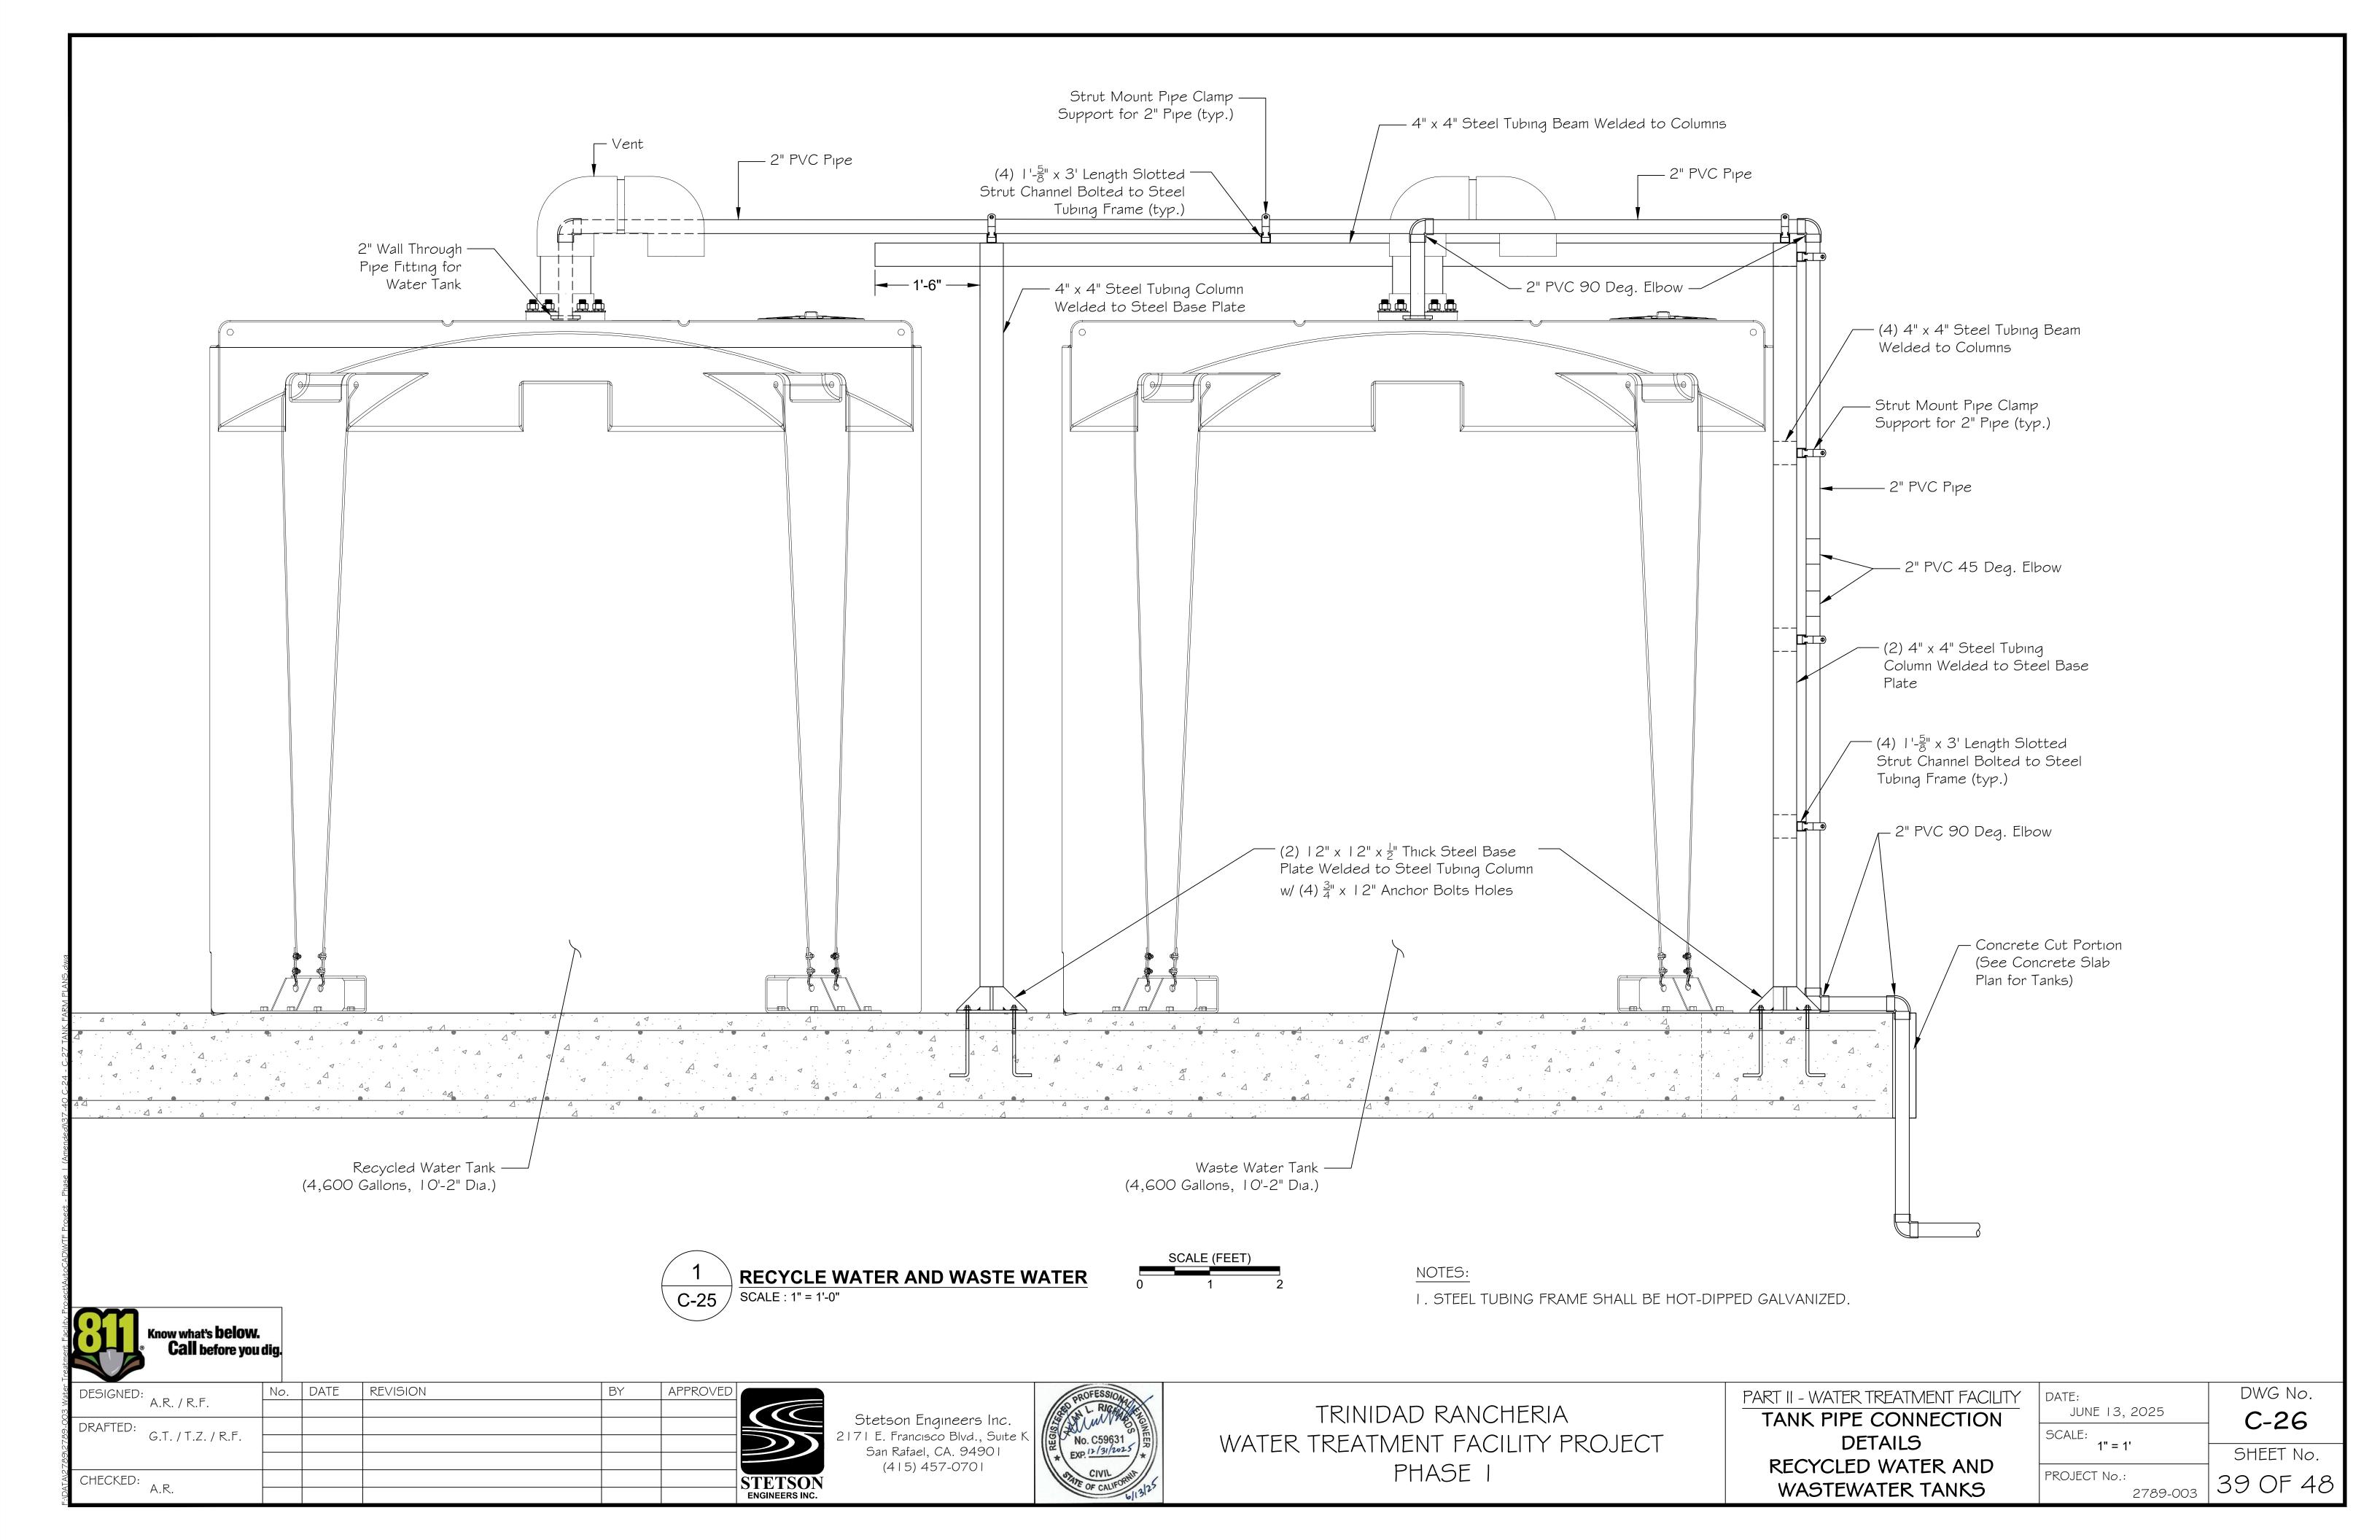

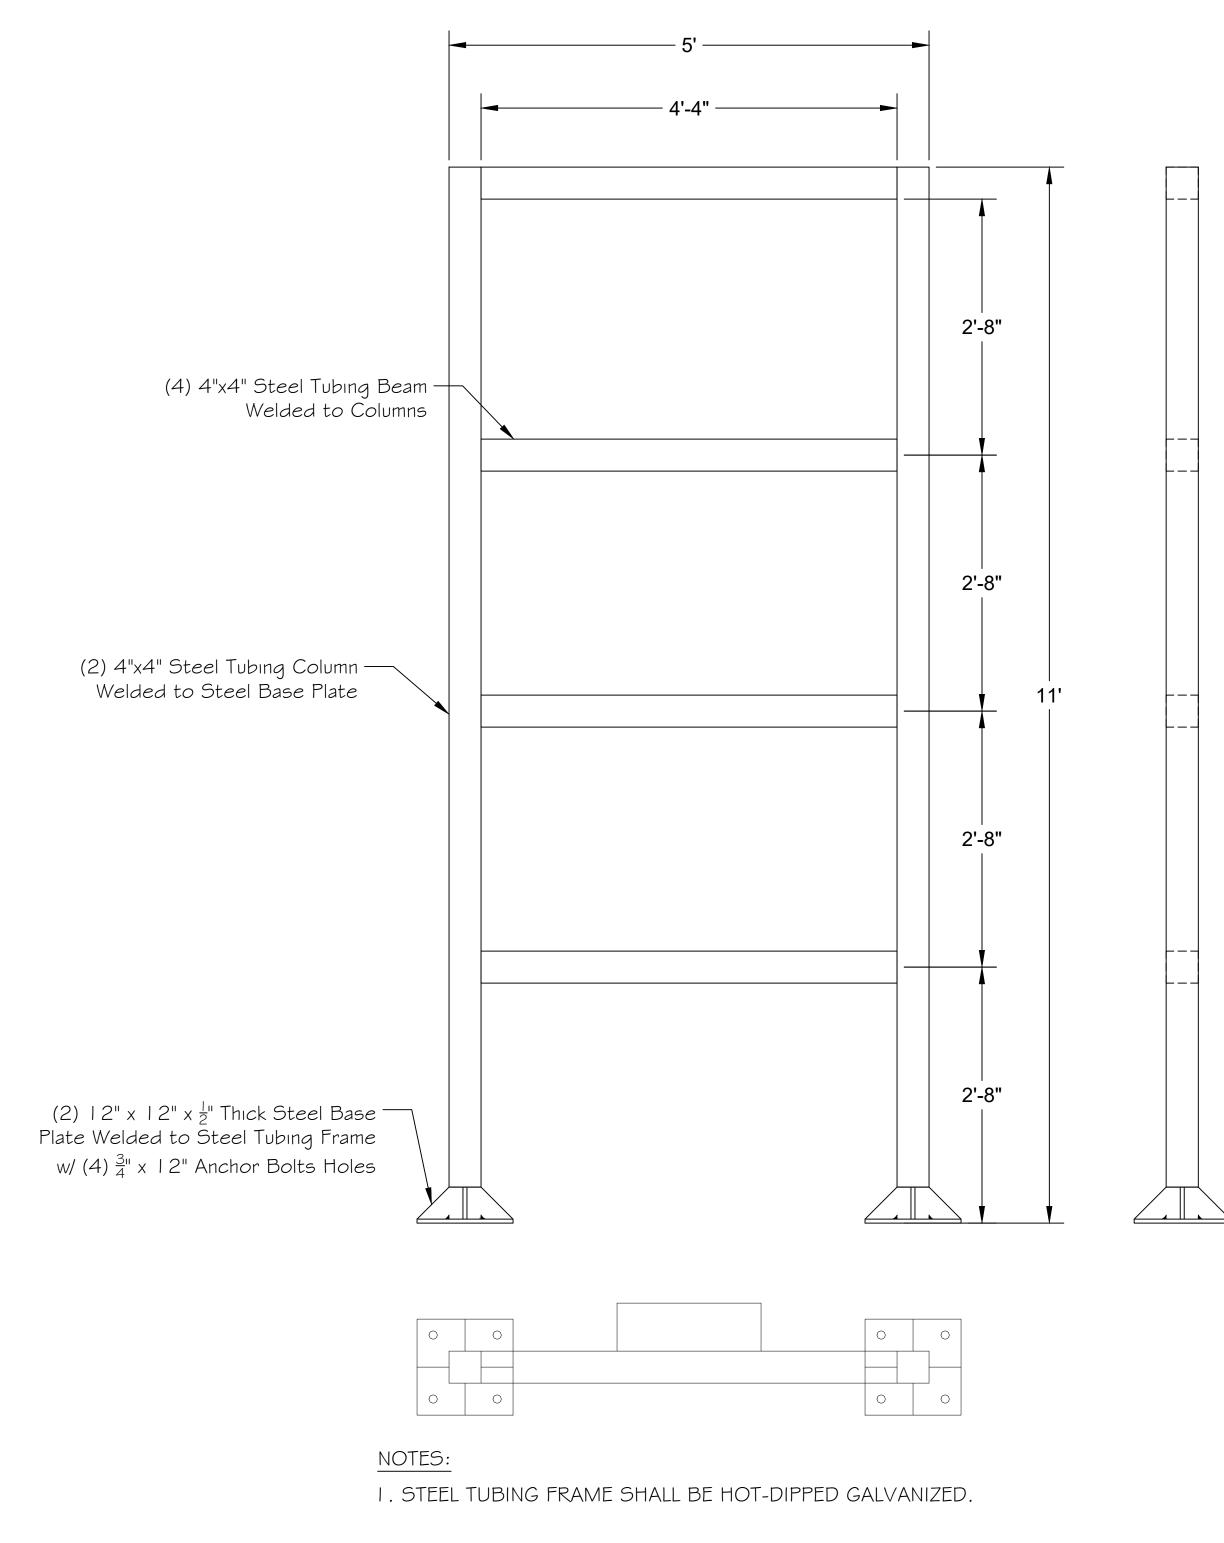

STEEL TUBING FRAME PIPE SUPPORT DETAILS C-26 SCALE: 1" = 1'-0"

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	A.R. / R.F.						
DRAFTED:	G.T. / T.Z. / R.F.						
	G.I. / I.Z. / K.I.						
CHECKED:	Λ D						STE
	A.R.						ENGINE



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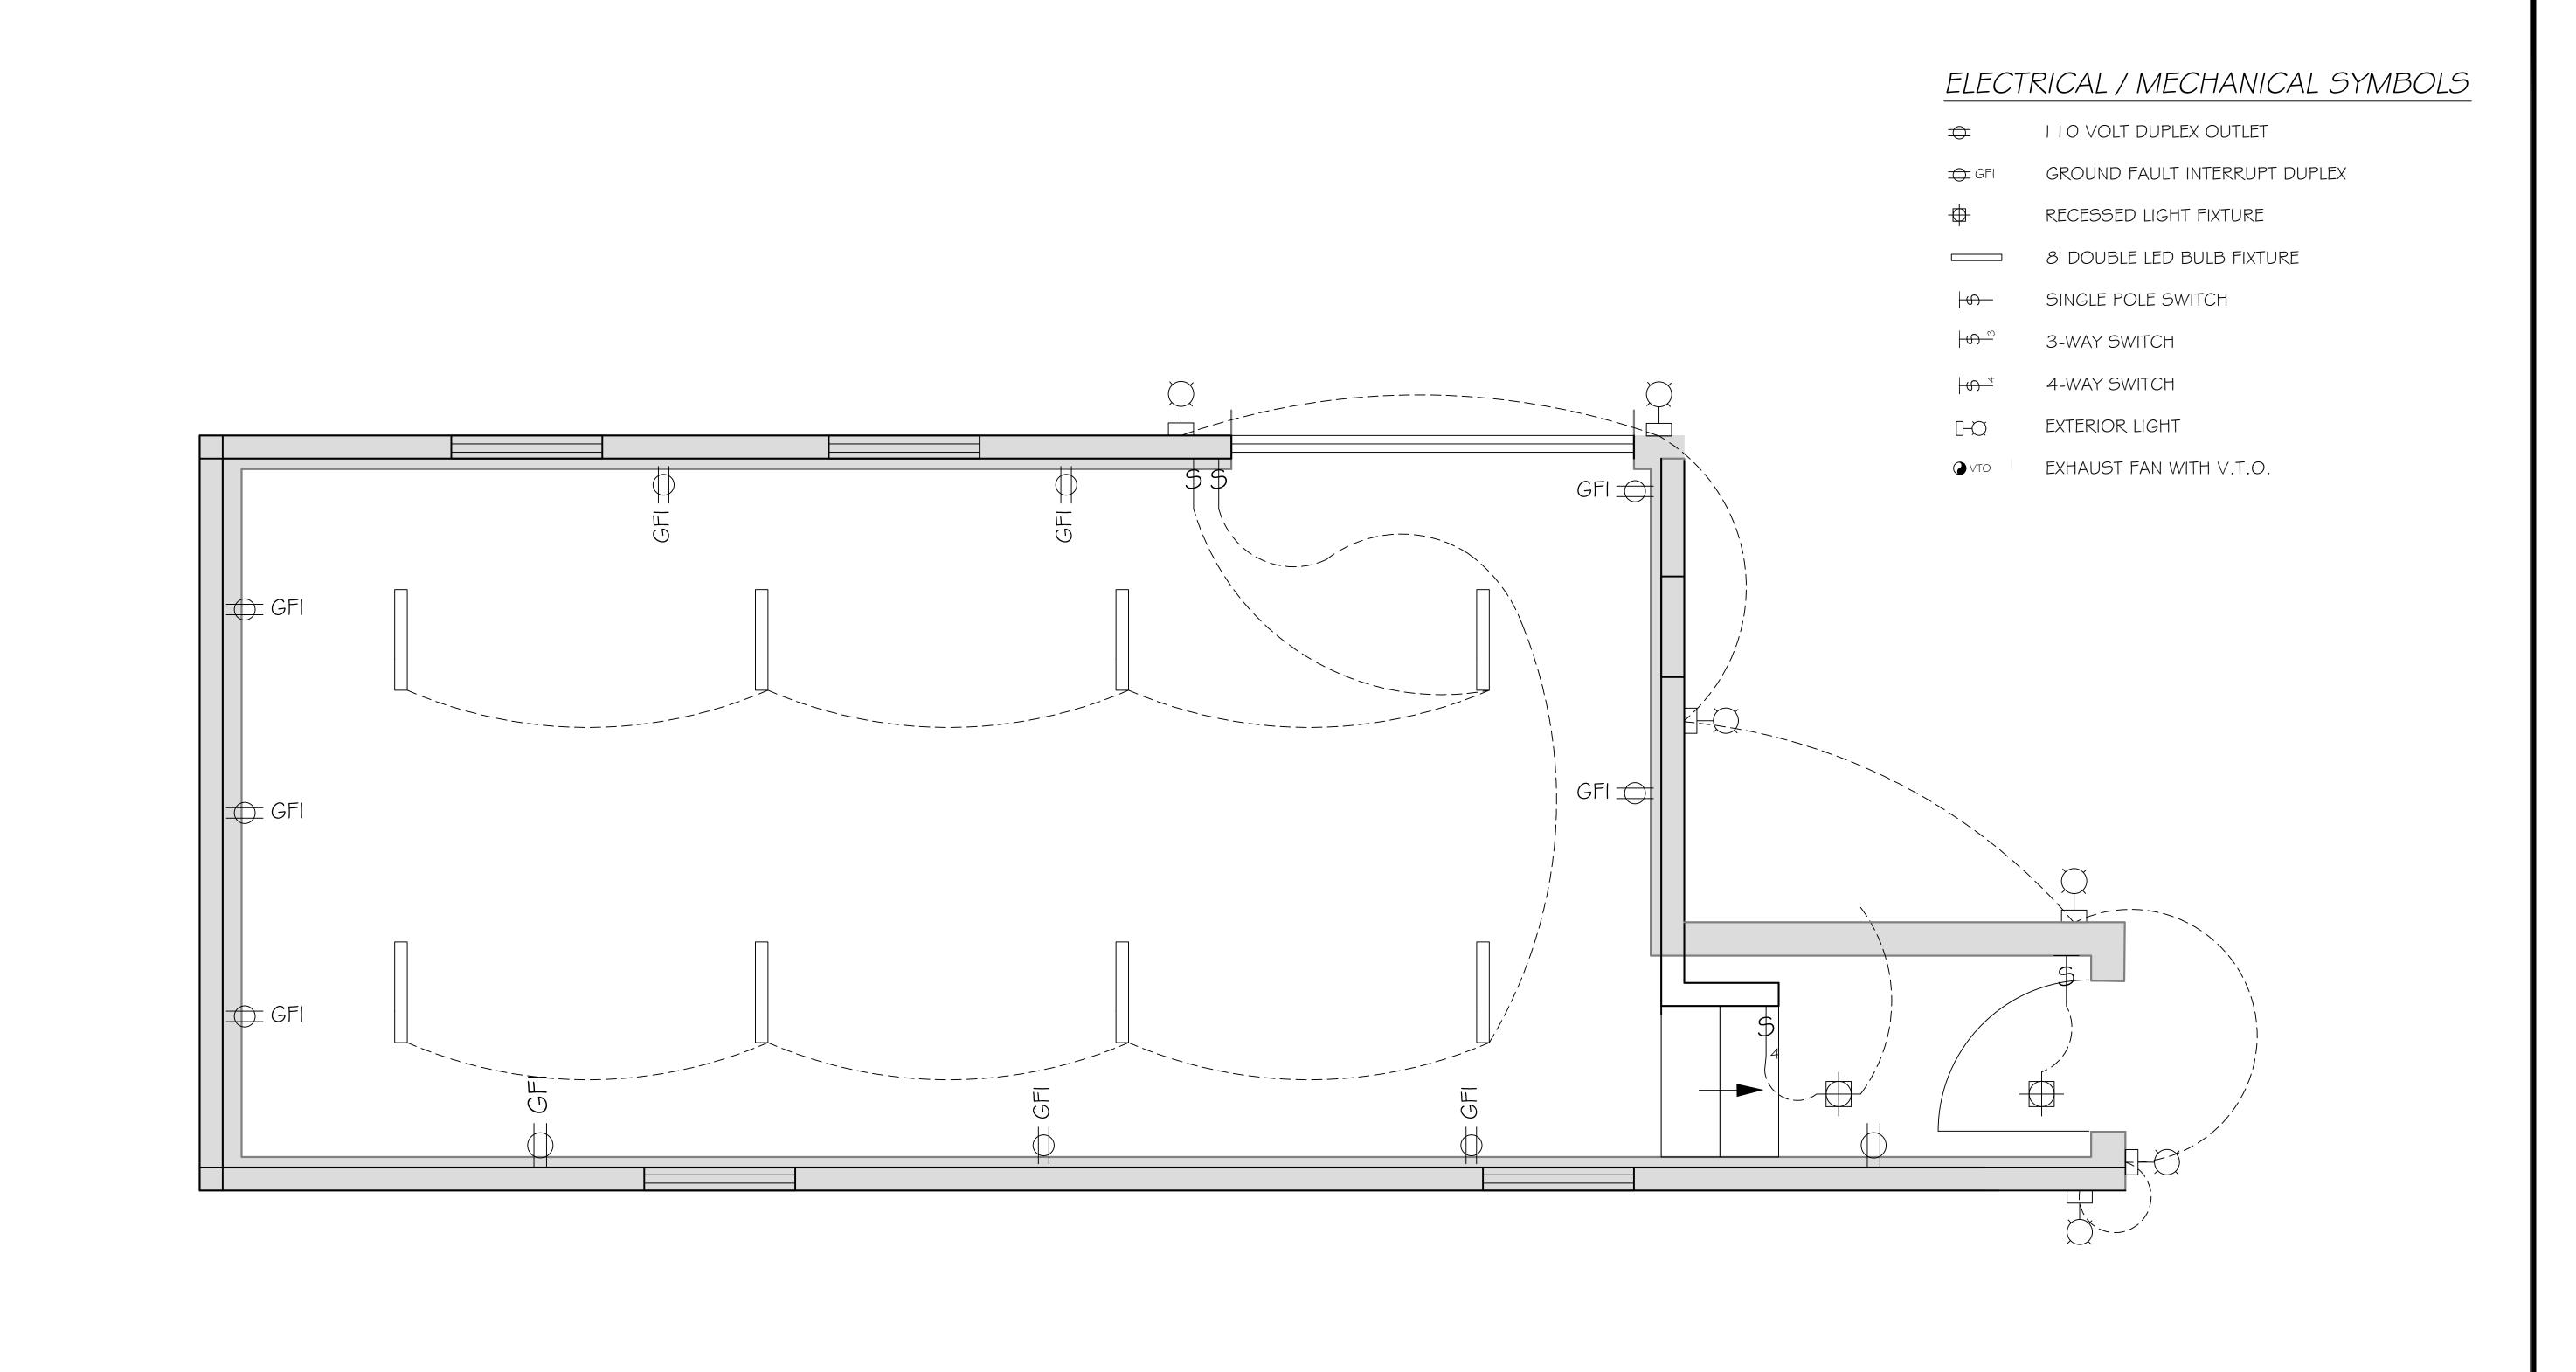
TRINIDAD RANCHERIA WATER TREATMENT FACILITY PROJECT PHASE I

PART II - WATER TREATMENT FACILITY

TANK FARM
MISCELLANEOUS DETAILS

DATE:	DWG No.
JUNE 13, 2025	C-27
SCALE:	0-27
1" = 1'	SHEET No.

-27 EET No. 2789-003 40 OF 48 PROJECT No.:





DESIGNED: A.R. / R.F. No. DATE REVISION BY APPROVED G.T. / T.Z. / R.F.	
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DRAFTED: G.T. / T.Z. / R.F.	
G.I./I.Z./R.I.	
CHECKED: A D	\mathbf{E}'
A.R. ENG	SINE

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TRINIDAD RANCHERIA WATER TREATMENT FACILITY PROJECT PHASE I

PART II - WATER TREATMENT FACILI


WTP BUILDING GENERAL ELECTRICAL PLAN

	G,	\mathred{m}	0	10
TY	DATE: JUNE	E 13, 20	25	
	SCALE:			

1" = 20' SHEET No. PROJECT No.: 41 OF 48 2789-003

DWG No.

E-1

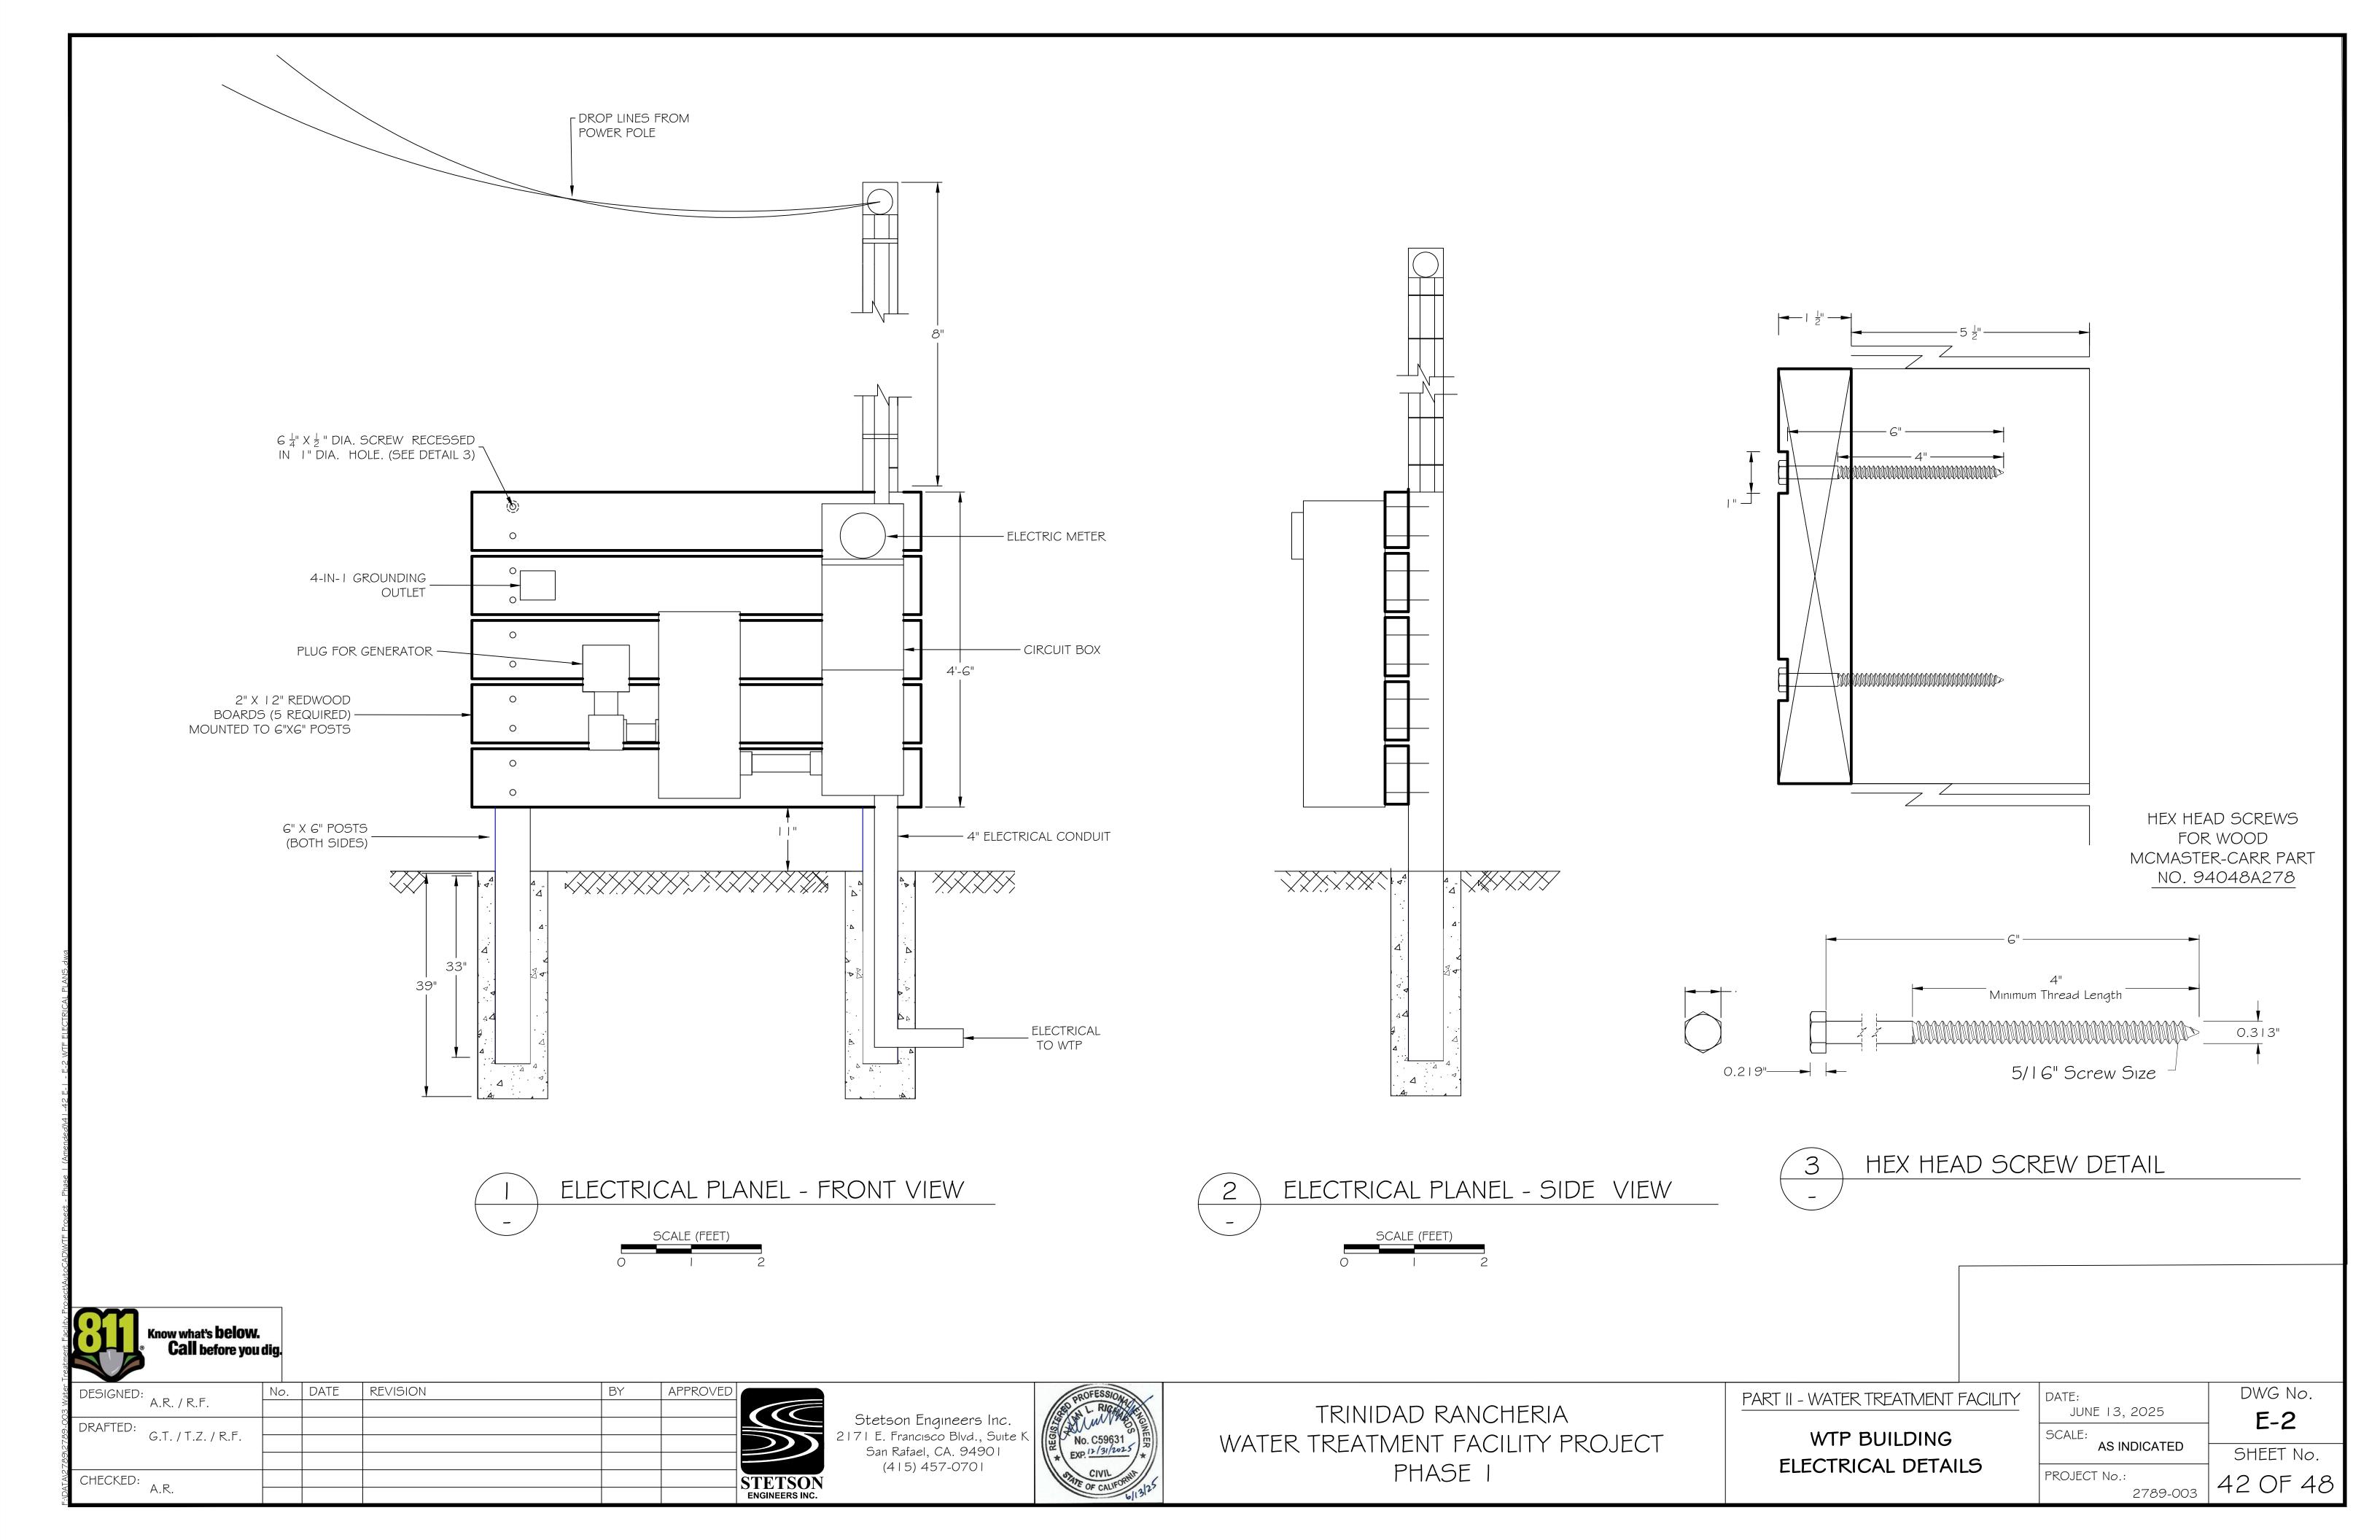

TRINIDAD RANCHERIA WATER TREATMENT FACILITY PROJECT

CHER-AE HEIGHTS INDIAN COMMUNITY OF THE TRINIDAD RANCHERIA - CALIFORNIA

FUNDED BY CALIFORNIA DEPARTMENT OF WATER RESOURCES, UNDER THE SMALL COMMUNITY DROUGHT RELIEF PROGRAM

GENERAL NOTES

- I. PRIOR TO START OF ANY WORK AT THE PROJECT SITE. THE CONTRACTOR SHALL NOTIFY TRINIDAD RANCHERIA'S REPRESENTATIVE AND. THE PROJECT ENGINEER. STETSON ENGINEERS INC., ATTN: ALLAN RICHARDS (415) 457-0701 / ALLANR@STETONENGINEERS.COM, TO ALLOW PROPER COORDINATION AND NOTIFICATION TO THE PROPERTY OWNERS.
- 2. THE PROJECT WORK SHALL CONSIST OF INSTALLING NEW 2-INCH AND 3-INCH DIAMETER PIPE ALONG THE ALIGNMENT SHOWN IN THIS PLAN SET BY OPEN TRENCH OR HORIZONTAL DIRECTION DRILLING METHODS. THE WORK SHALL CONSIST OF DIRECTIONAL DRILLING ALONG UNIMPROVED HILLSIDES; INSTALLATION OF PIPE BEDDING: INSTALLATION OF PIPE BEDDING, INSTALLATION OF FITTINGS AND VALVES; TIE-INS TO NEW WELL SITE PIPING, ON-SITE WATER TREATMENT FACILITY PIPING TO NEW RAW WATER STORAGE TANK. THE COMPLETED WORK WILL ALSO REQUIRE A HYDROSTATIC PRESSURE TEST AND DISINFECTION OF THE NEW PIPELINE AND WELLHEADS.
- 3. CONTRACTOR MUST NOTIFY UNDERGROUND SERVICE ALERT OF NORTHERN/CENTRAL CALIFORNIA AND NEVADA (USA NORTH) AT 811 OR ONLINE AT USANORTH811.ORG, AT LEAST TWO (2) DAYS PRIOR TO THE COMMENCEMENT OF ANY EXCAVATION WORK.
- 4. IT IS THE RESPONSIBILITY OF THE CONTRACTOR TO PERFORM UTILITY EXPLORATION TO VERIFY LOCATIONS OF EXISTING UTILITIES (INCLUDING BUT NOT LIMITED TO, GAS PIPELINES EXISTING WATER PIPELINES, ELECTRICAL, CABLE, AND TELECOMMUNICATIONS UTILITIES, BURIED OR ABOVE GROUND) BY POT-HOLING OR OTHER MEANS, AND PROTECT UTILITIES IN PLACE. CONTRACTOR SHALL REPORT TO THE ENGINEER ANY DISCREPANCIES FOUND OR ANY DETAILS NOT SHOWN ON THE DRAWINGS. EXPLORATORY EXCAVATIONS SHALL BE PERFORMED BY THE CONTRACTOR BEFORE THE SUBMITTAL OF SHOP DRAWINGS FOR THE PIPE AND SPECIAL PIPE SECTIONS.
- 5. THIS PLAN DOES NOT AUTHORIZE ANY WORK WITHIN PUBLIC/PRIVATE RIGHT-OF-WAYS WITHOUT REQUIRED APPROVALS AND/OR PERMITS. CONTRACTOR SHALL WORK WITH THE APPROPRIATE AGENCIES AND TRINIDAD RANCHERIA TO OBTAIN PROPER APPROVAL(S) AND/OR PERMIT(S) AND SHALL SUBMIT TO TRINIDAD RANCHERIA AND PROJECT ENGINEER ALL APPROVAL(S)/PERMIT(S) WITH START OF WORK NOTIFICATION.
- 6. THE LOCATION OF THE EXISTING WATER PIPELINES FOR TIE-INS ARE APPROXIMATED IN THESE DRAWINGS AND IT IS THE CONTRACTOR'S RESPONSIBILITY TO IDENTIFY ACTUAL LOCATIONS AND ALIGNMENT OF EXISTING WATER PIPELINES PRIOR TO START OF THE WORK. THE CONTRACTOR IS RESPONSIBLE FOR ANY DAMAGE TO EXISTING UTILITIES.
- 7. ALL WORK DETAILED HEREIN SHALL BE CONSTRUCTED IN ACCORDANCE WITH THE CONTRACT DOCUMENTS. IN THE CASE OF DISCREPANCY OR AMBIGUITY IN CONTRACT DOCUMENTS AND THIS SET OF DRAWINGS. THE CONTRACTOR IS REFERRED TO DOCUMENT 00700 - GENERAL CONDITIONS ARTICLE 5.7 - PRECEDENCE OF DOCUMENTS OF THE PROJECT MANUAL
- 8. NO REVISIONS SHALL BE MADE TO THESE DRAWINGS WITHOUT THE APPROVAL OF THE PROJECT ENGINEER AND THE OSAGE NATION.
- 9. ANY DATA AND INFORMATION PROVIDED BY THE TRINIDAD RANCHERIA ON ARE FOR THE CONTRACTOR'S INFORMATION ONLY. ANY INTERPRETATIONS OR CONCLUSIONS DRAWN BY THE CONTRACTOR FROM THEM SHALL BE THE RESPONSIBILITY OF THE CONTRACTOR.
- 10. THE CONTRACTOR SHALL EXERCISE CARE AND SAFETY WHEN WORKING NEAR EXISTING UTILITIES ON SITE INCLUDING EXISTING WATER MAINS AND APPURTENANCES, GAS LINES AND ELECTRICAL UTILITIES. AND SHALL BE FULLY RESPONSIBLE FOR ANY DAMAGE. BREAKAGE, OR LEAKS CAUSED BY THE CONTRACTOR'S WORK.

PART III - PIPELINES AND WELLS

- II. THE CONTRACTOR SHALL RESTORE THE GROUND SURFACE OF EXCAVATED AREAS TO ORIGINAL GRADE AS REASONABLY POSSIBLE UNLESS OTHERWISE SHOWN OR DIRECTED.
- 12. THE CONTRACTOR SHALL TAKE PRECAUTIONARY MEASURES TO PROTECT EXISTING UTILITIES, STRUCTURES, FENCING, ETC. FROM DAMAGE. CONTRACTOR SHALL BEAR SOLE RESPONSIBILITY FOR ANY DAMAGE TO SUCH FACILITIES.
- 13. THE ENGINEER HAS, BY SEARCH OF KNOWN RECORDS, ENDEAVORED TO LOCATE AND INDICATE ON THE PLANS ALL THE UTILITIES WHICH EXIST WITHIN THE LIMITS OF THE WORK. HOWEVER. THE ACCURACY OR COMPLETENESS OF THE UTILITIES ON THE DRAWINGS IS NOT GUARANTEED.
- 14. STATIONS SHOWN ON THE DRAWINGS ARE ALONG OR ON A LINE NORMAL OR RADIAL TO THE CENTER LINE OF THE WATER LINE.
- 15. ALL WATER LINES SHALL HAVE A MINIMUM OF THIRTY (30") INCHES OF COVER OR HAVE SUFFICIENT INSULATION TO PREVENT FREEZING, UNLESS OTHERWISE SHOWN. ALL RAW WATER LINES SHALL CROSS BELOW ANY POTABLE WATER CROSSINGS AND MAINTAIN AT LEAST 12-INCHES OF SEPARATION.
- 16. ALL BURIED VALVES SHALL BE INSTALLED WITHIN A VALVE BOX AND VALVE STEM EXTENSION.
- 17. WATER LINES SHALL BE PRESSURE TESTED AND DISINFECTED PER THE AWWA STANDARDS PRIOR TO PLACING THE NEW WATER PIPELINE INTO SERVICE.
- 18. THE LOCATION OF AVAC VALVE REROUTING/OUTLET IS ONLY GENERALLY SHOWN. THE EXACT LOCATION OF VERTICAL RISER WILL BE DETERMINED IN THE FIELD BY TRINIDAD RANCHERIA STAFF.

SURVEY CONTROL NOTES

- I. FOR PHASE III PIPELINES AND WELLS PLANS HAVE A VERTICAL DATUM NAVD 88. BASED ON DEM DATA.
- 2. FOR PHASE III PIPELINES AND WELLS PLANS HAVE A HORIZONTAL DATUM NAD 83 CALIFORNIA STATE PLANES, ZONE I IN FEET, BASED ON DEM DATA.

CULTURAL MONITORING

- I. CULTURAL MONITORING IS REQUIRED UNDER THIS PROJECT AND CONTRACT AGREEMENT FOR ANY GROUND DISTURBING ACTIVITIES. DURING CONSTRUCTION. THE CONTRACTOR IS TO ADHERE TO THE REQUIREMENTS OF THE TRINIDAD RANCHERIA THPO AND CULTURAL MONITOR IN THE EVEN OF DISCOVERY OF SENSITIVE ITEMS AS DEFINED AND EXPLAINED HEREIN.
- 2. IT IS THE RESPONSIBILITY OF THE CONTRACTOR TO NOTIFY THE RANCHERIA SEVENTY-TWO (72) HOURS PRIOR TO CONDUCTING GROUND DISTURBANCE ACTIVITIES.
- 3. 3. CONTRACTOR IS RESPONSIBLE FOR ALL COORDINATION WITH TRINIDAD RANCHERIA THPO TO ENSURE A TRINIDAD RANCHERIA CULTURAL MONITOR IS AVAILABLE DURING ANY GROUND DISTURBANCE ACTIVITIES.

REFERENCE

DETAIL / SECTION

NUMERAL OR LETTER SHOWN INDICATES DETAIL OR SECTION DRAWING

- NUMERAL SHOWN INDICATES DRAWING NUMBER ON WHICH DETAIL OR SECTION APPEARS

ABBREVIATIONS & SYMBOLS

ASBESTOS - CEMENT PIPE

APPROX APPROXIMATED CENTER LINE

CONCRETE

CATHODIC TEST STATION

CUBIC YARDS DUCTILE IRON DIAMETER

DUCTILE IRON PIPE DRAWING

EXISTING ELECTRIC. EAST EXISTING GROUND

ELEVATION FLANGE FEET

GALVANIZED HORIZONTAL INCHES LENGTH LINEAL FEET MAXIMUM

MINIMUM MISCELLANEOUS

MECHANICAL JOINT NEW NORTH NOMINAL

NOT TO SCALE NUMBER ON CENTER START CURVE POINT OF INFLEXION

END CURVE POTABLE WATER RADIUS REQUIRED Rea'd

SQUARE FEET SQ.FT. SOUTH STAINLESS STEEL STATION

STANDARD TO BE DETERMINED

CHER-AE HEIGHTS INDIAN COMMUNITY OF THE TRINIDAD RANCHERIA


TYPICAL VERT VERTICAL WATER, WEST WITH

DEGREES FEET OR MINUTES INCHES OR SECONDS

DELTA ANGULE

DIAMETER NUMBER PERCENT

Know what's **below**. **Call** before you dig.

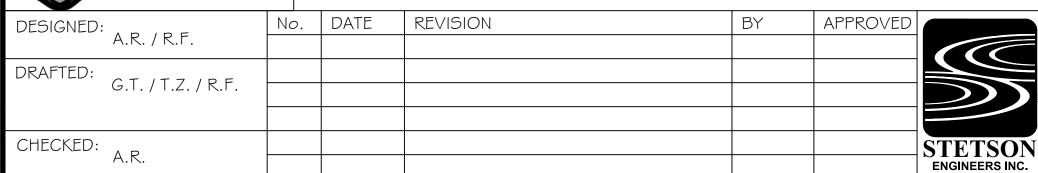

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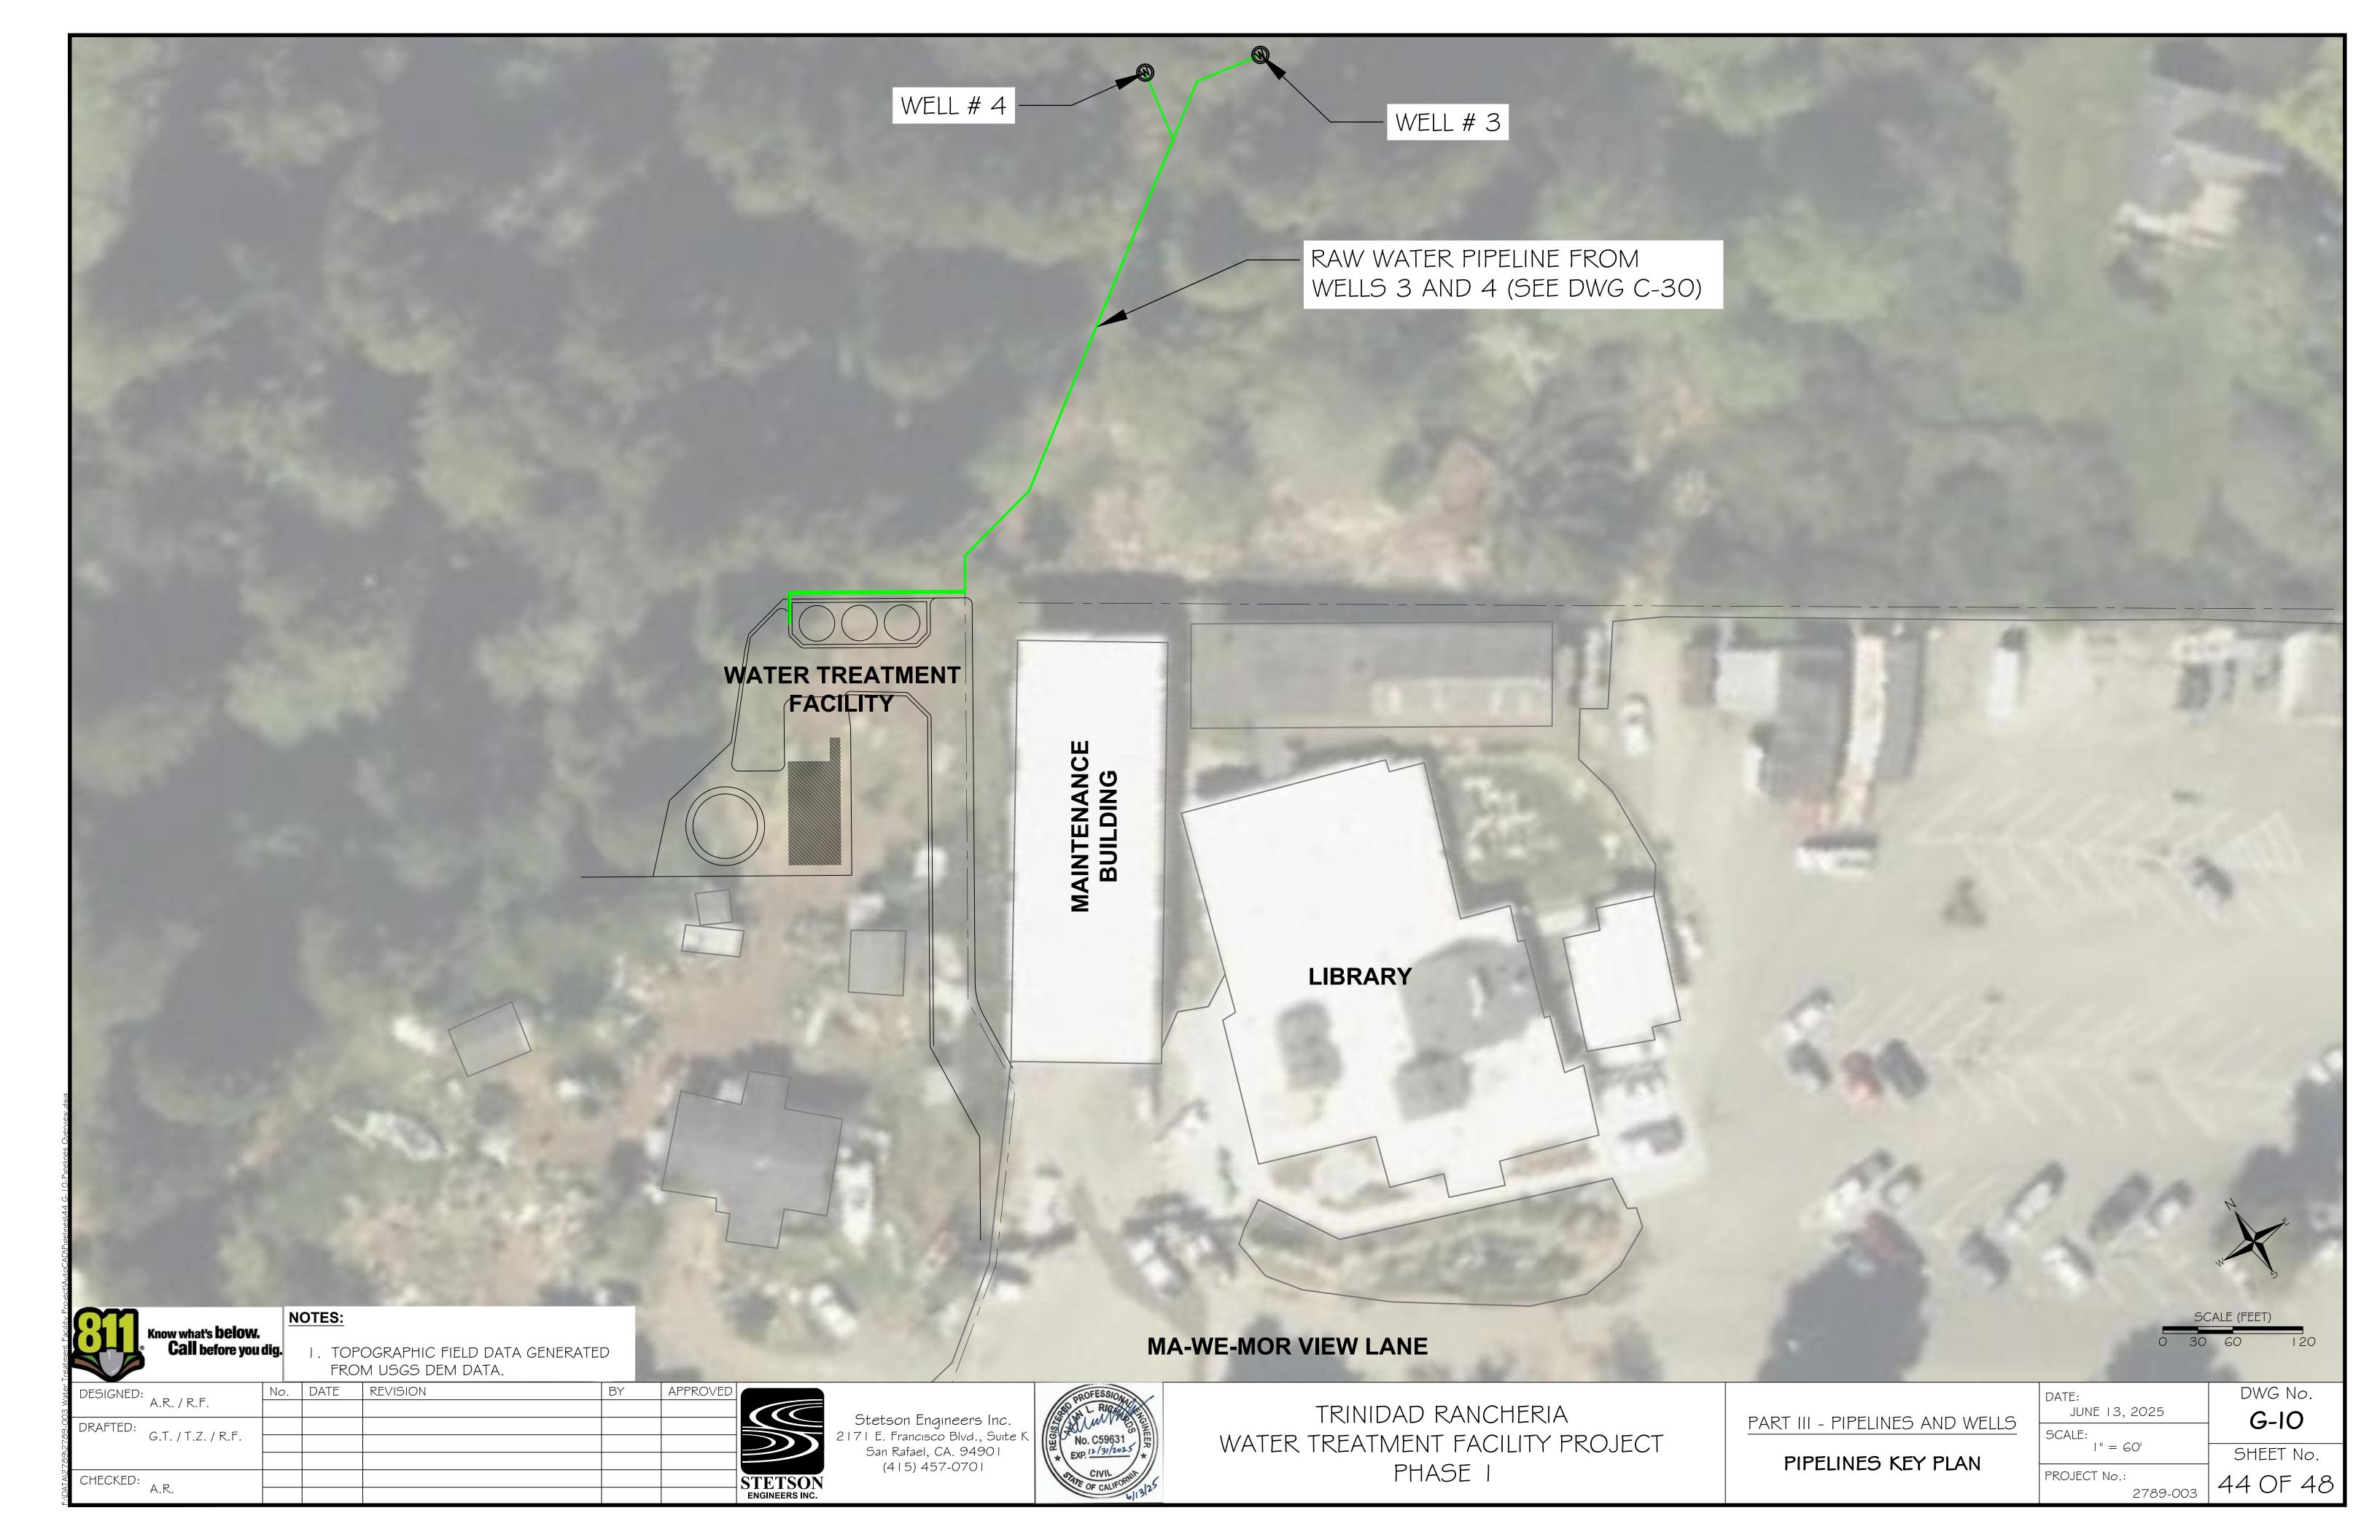



TRINIDAD RANCHERIA WATER TREATMENT FACILITY PROJECT PHASE I

PART III - PIPELINES AND WELLS GENERAL NOTES; SURVEY CONTROL NOTES; CULTURAL MONITORING; REFERENCE; ABBREVIATIONS & SYMBOLS


DWG No. JUNE 13, 2025 G-9 NO TO SCALE SHEET No.

PROJECT No.: 43 OF 48 2789-003



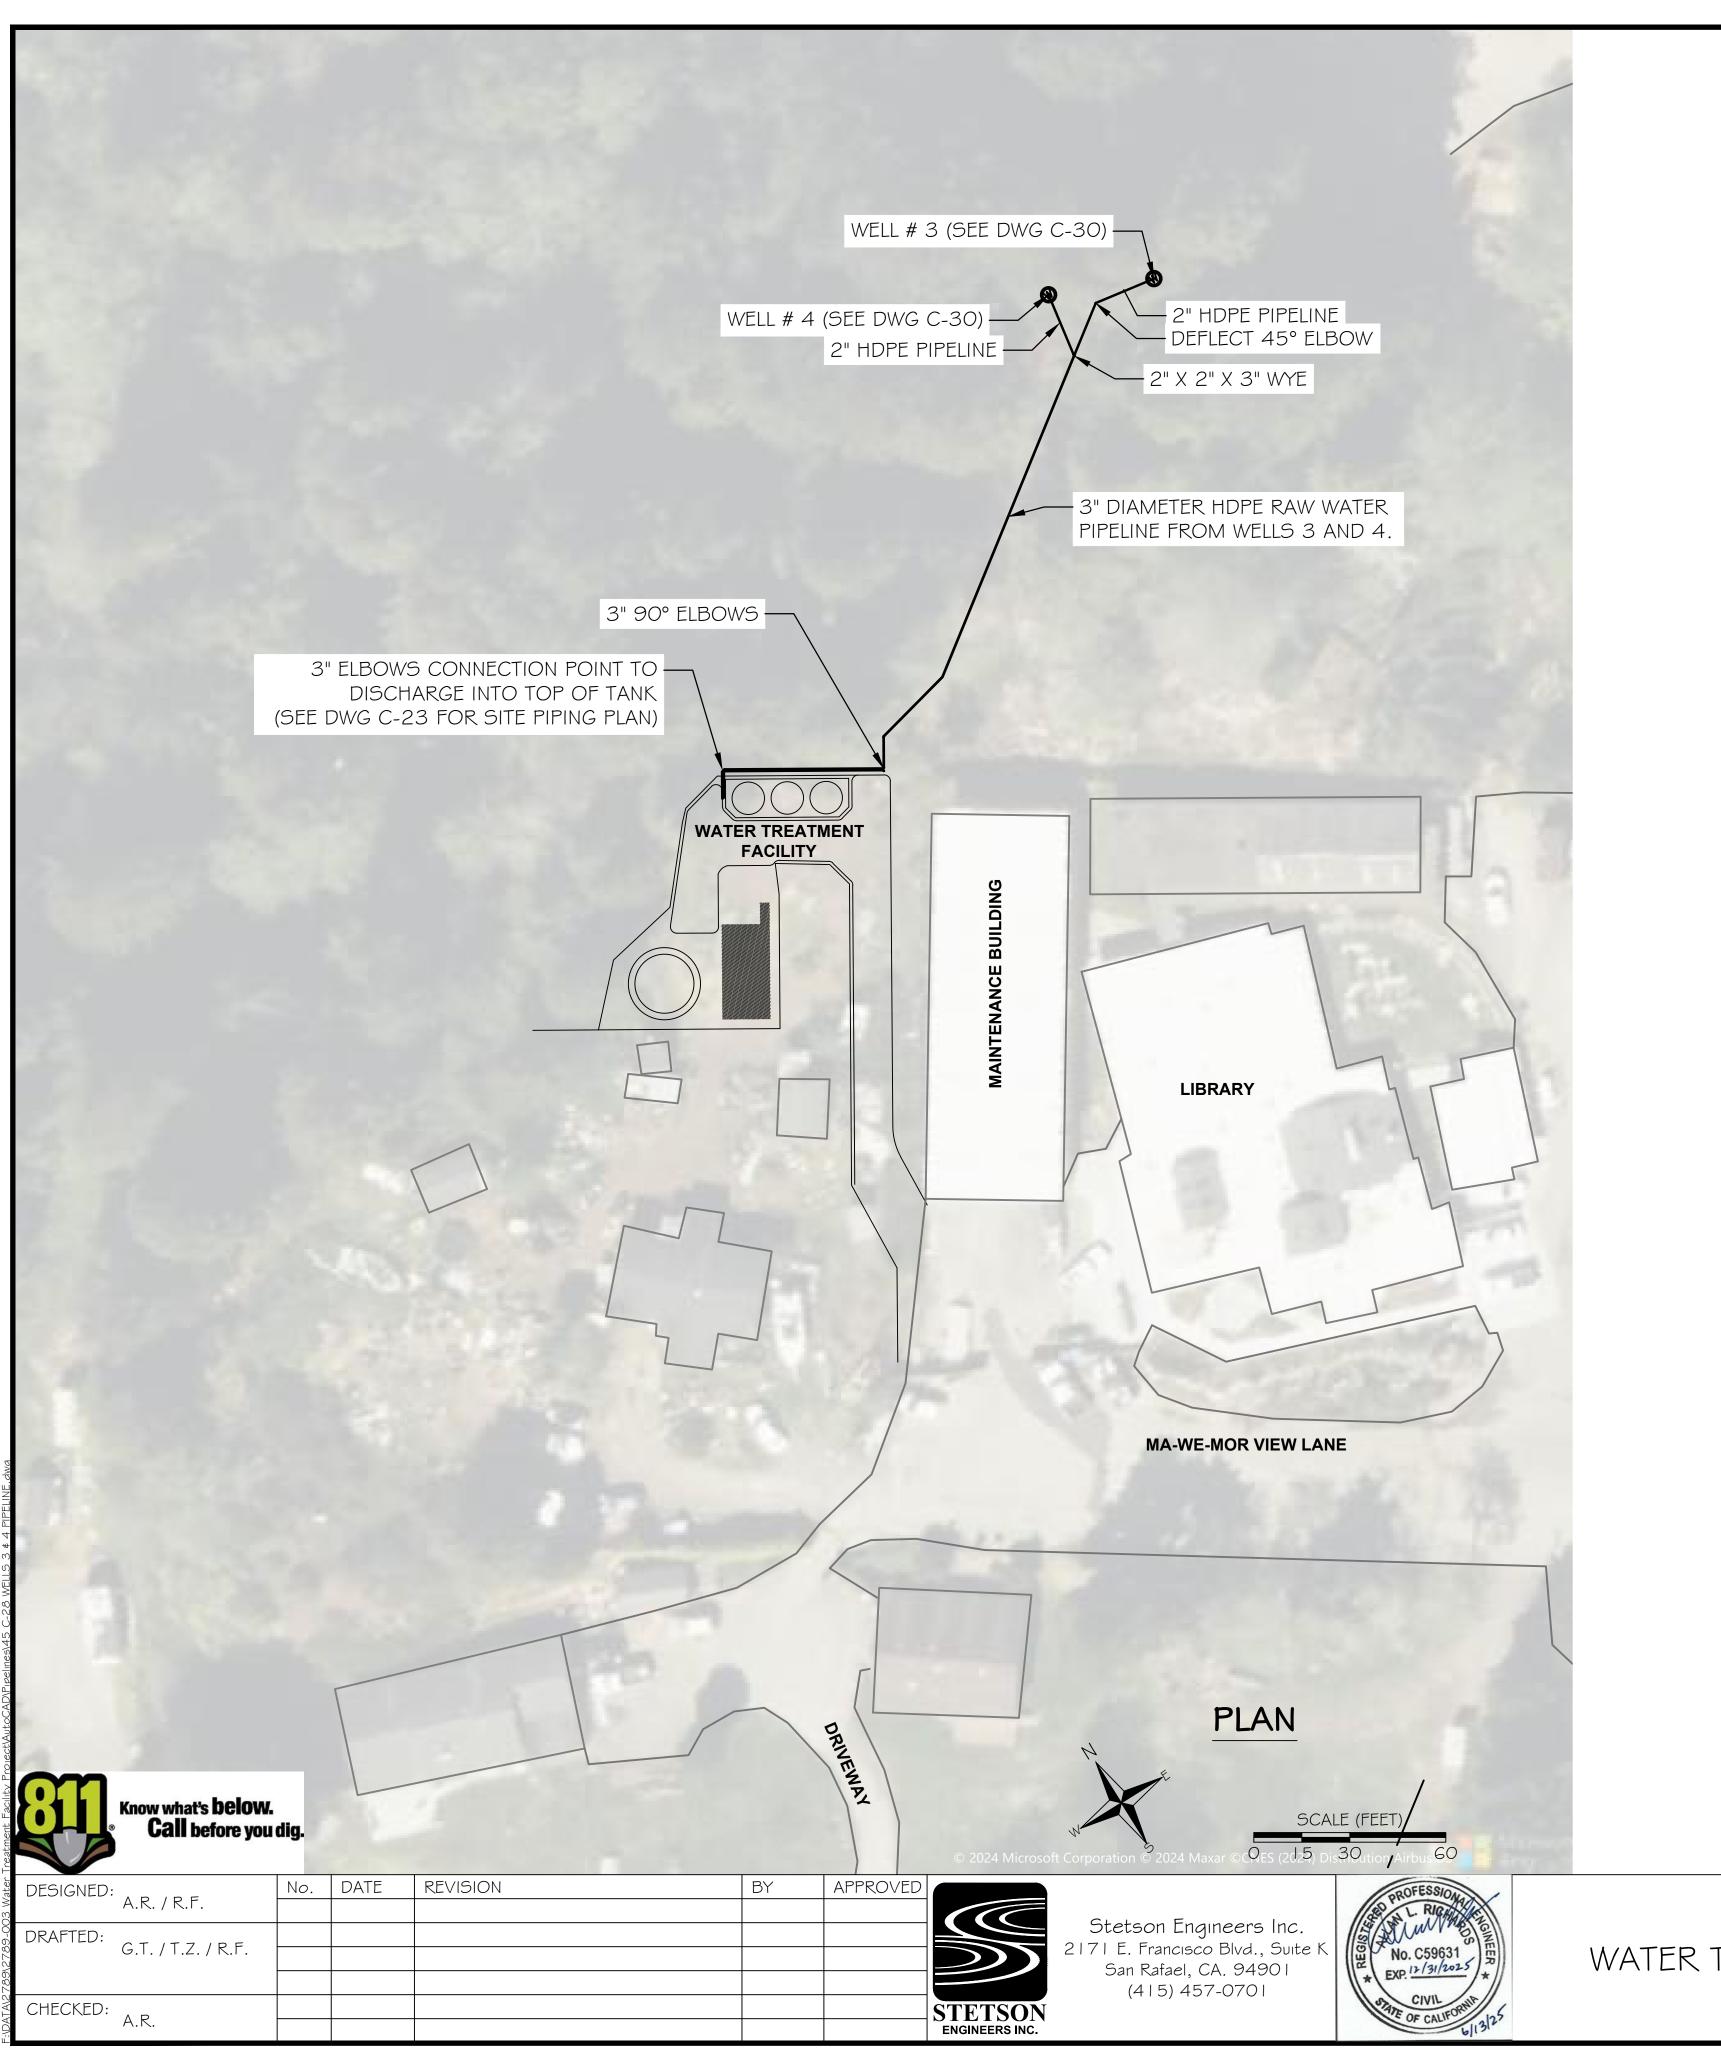

RAW WATER PIPELINE - WELLS 3 AND 4 PROFILE

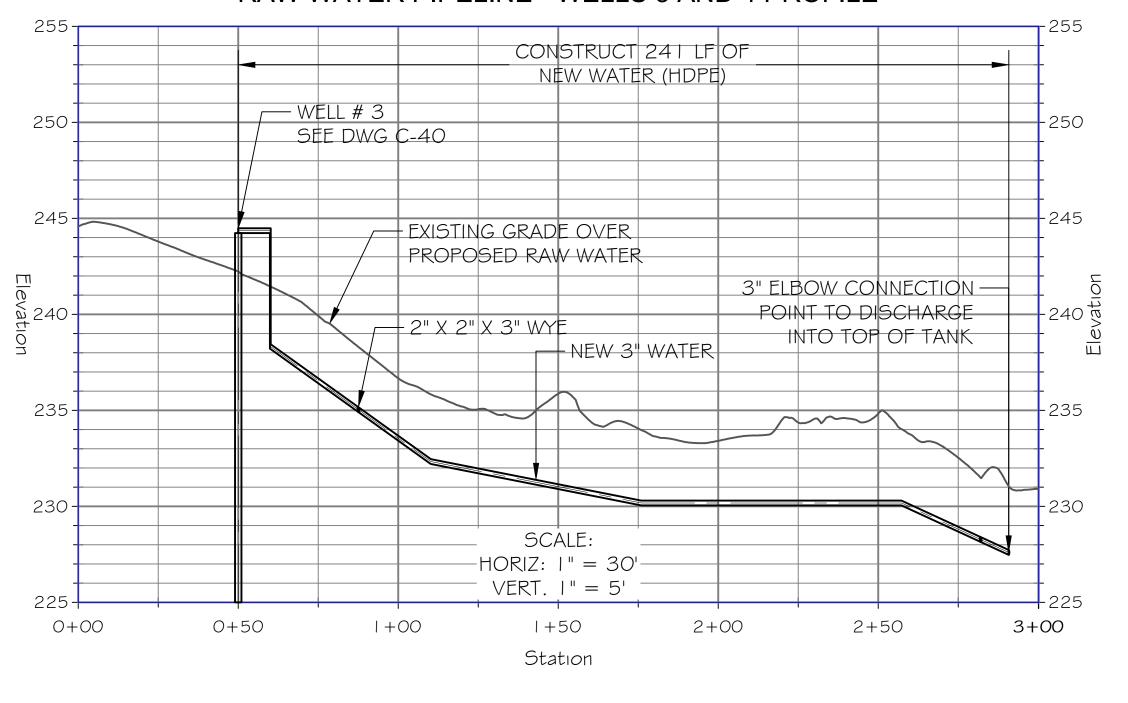

TRINIDAD RANCHERIA
WATER TREATMENT FACILITY PROJECT
PHASE I


PART III - PIPELINES AND WELLS


RAW WATER PIPELINES FROM
WELLS 3 AND 4
PROJECT No.:

:	DWG No.
UNE 13, 2025	C-28
E:	0
AS INDICATED	SHEET No.

2789-003


45 OF 48

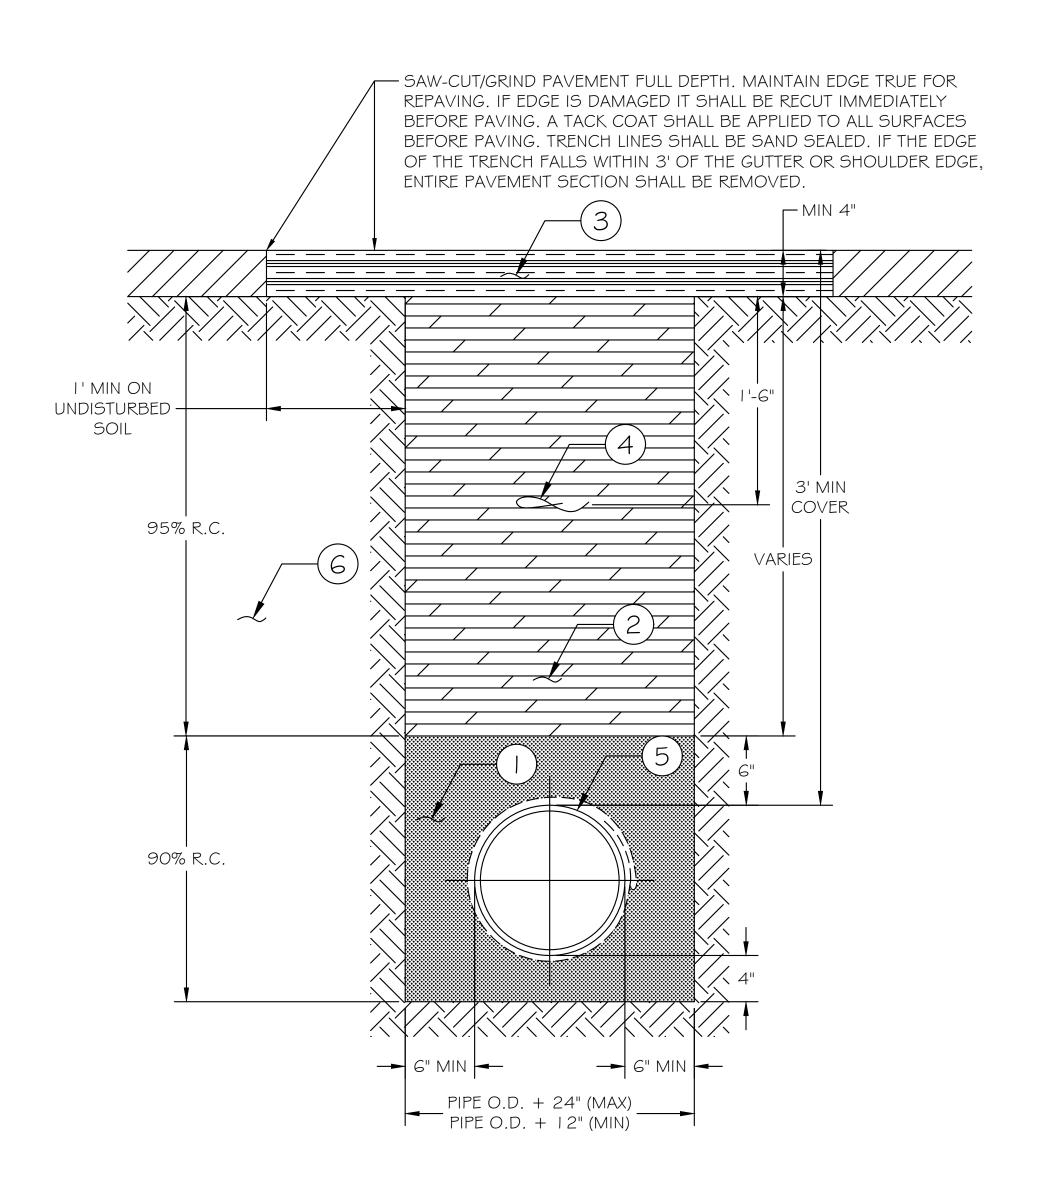

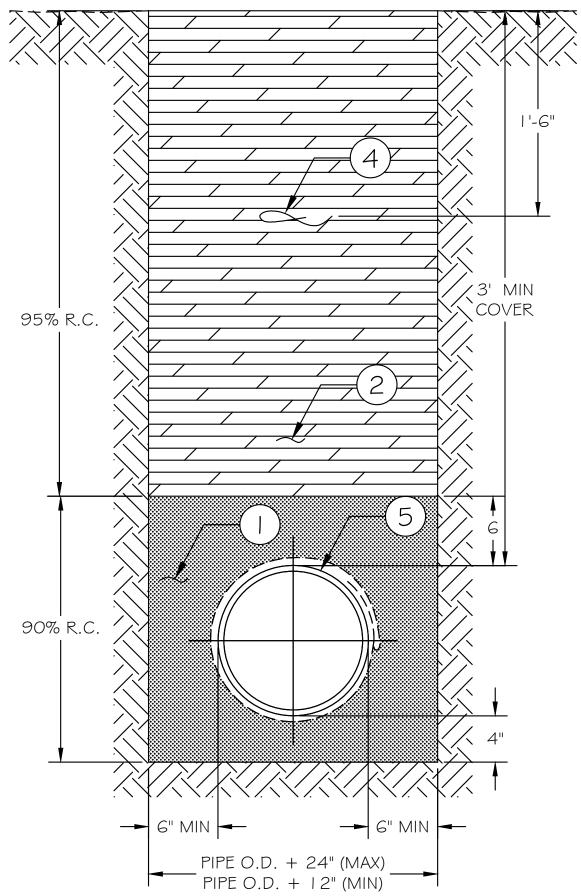





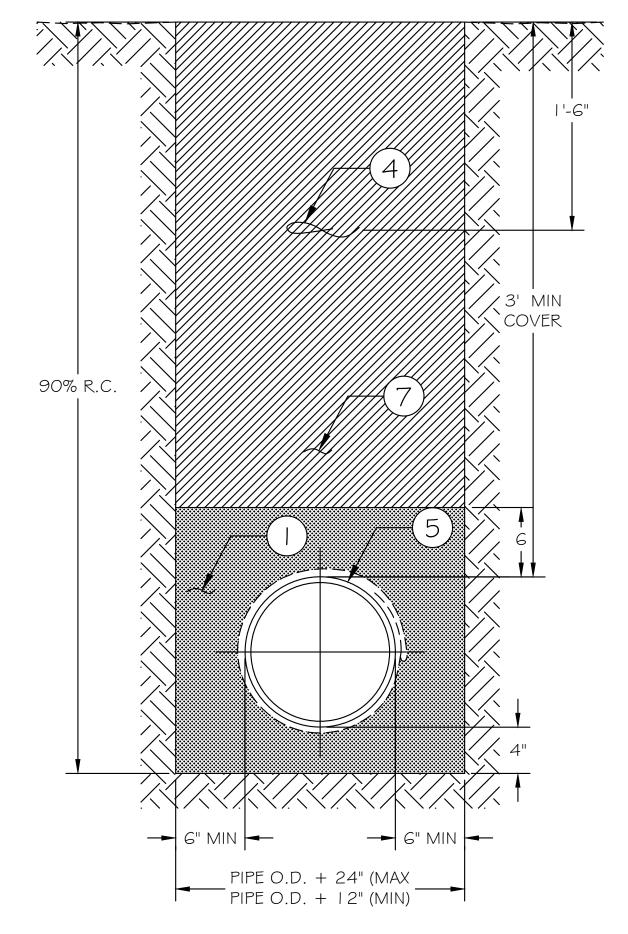



LEGEND:

PAVED SURFACES

NOT TO SCALE

TRENCH SECTION - TYPE A -

- UTILITY SAND BEDDING AND BACKFILL MATERIAL SHALL BE COMPACTED TO 90% RELATIVE COMPACTION.
- CLASS 2 AGGREGATE BASE BACKFILL MATERIAL SHALL BE COMPACTED TO 95% RELATIVE COMPACTION.
- ASPHALT CONCRETE PAVEMENT THICKNESS SHALL BE REPLACED IN KIND BUT NOT LESS THAN 4".
- MARKER TAPE TO BE INSTALLED 18" BELOW AC. REPLACE EXISTING TRACER WIRE IF DAMAGED DURING TRENCHING OPERATION.
- 3" HDPE FOR RAW WATER OR 6" HDPE FOR POTABLE WATER DR | 3.5 PIPE, UNLESS OTHERWISE NOTED.
- A SECOND OPERATION IS REQUIRED PRIOR TO FINAL PAVING TO ACHIEVE THE "T" CUT SECTION. SAW CUTTING/GRINDING A WIDER TRENCH LINE DURING INITIAL TRENCH EXCAVATION TO ACHIEVE A "T" CUT SECTION WILL NOT BE ALLOWED.
- NATIVE BACKFILL MATERIAL, SHALL BE COMPACTED TO 90% RELATIVE COMPACTION.

No. DATE REVISION APPROVED DESIGNED: A.R. / R.F. DRAFTED: G.T. / T.Z. / R.F. CHECKED: A.R.

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TRINIDAD RANCHERIA WATER TREATMENT FACILITY PROJECT PHASE I

PART III - PIPELINES AND WELLS


TRENCH REPLACEMENT **DETAILS**


JUNE 13, 2025 AS INDICATED


C-29 SHEET No.

DWG No.


PROJECT No.: 46 OF 48 2789-003

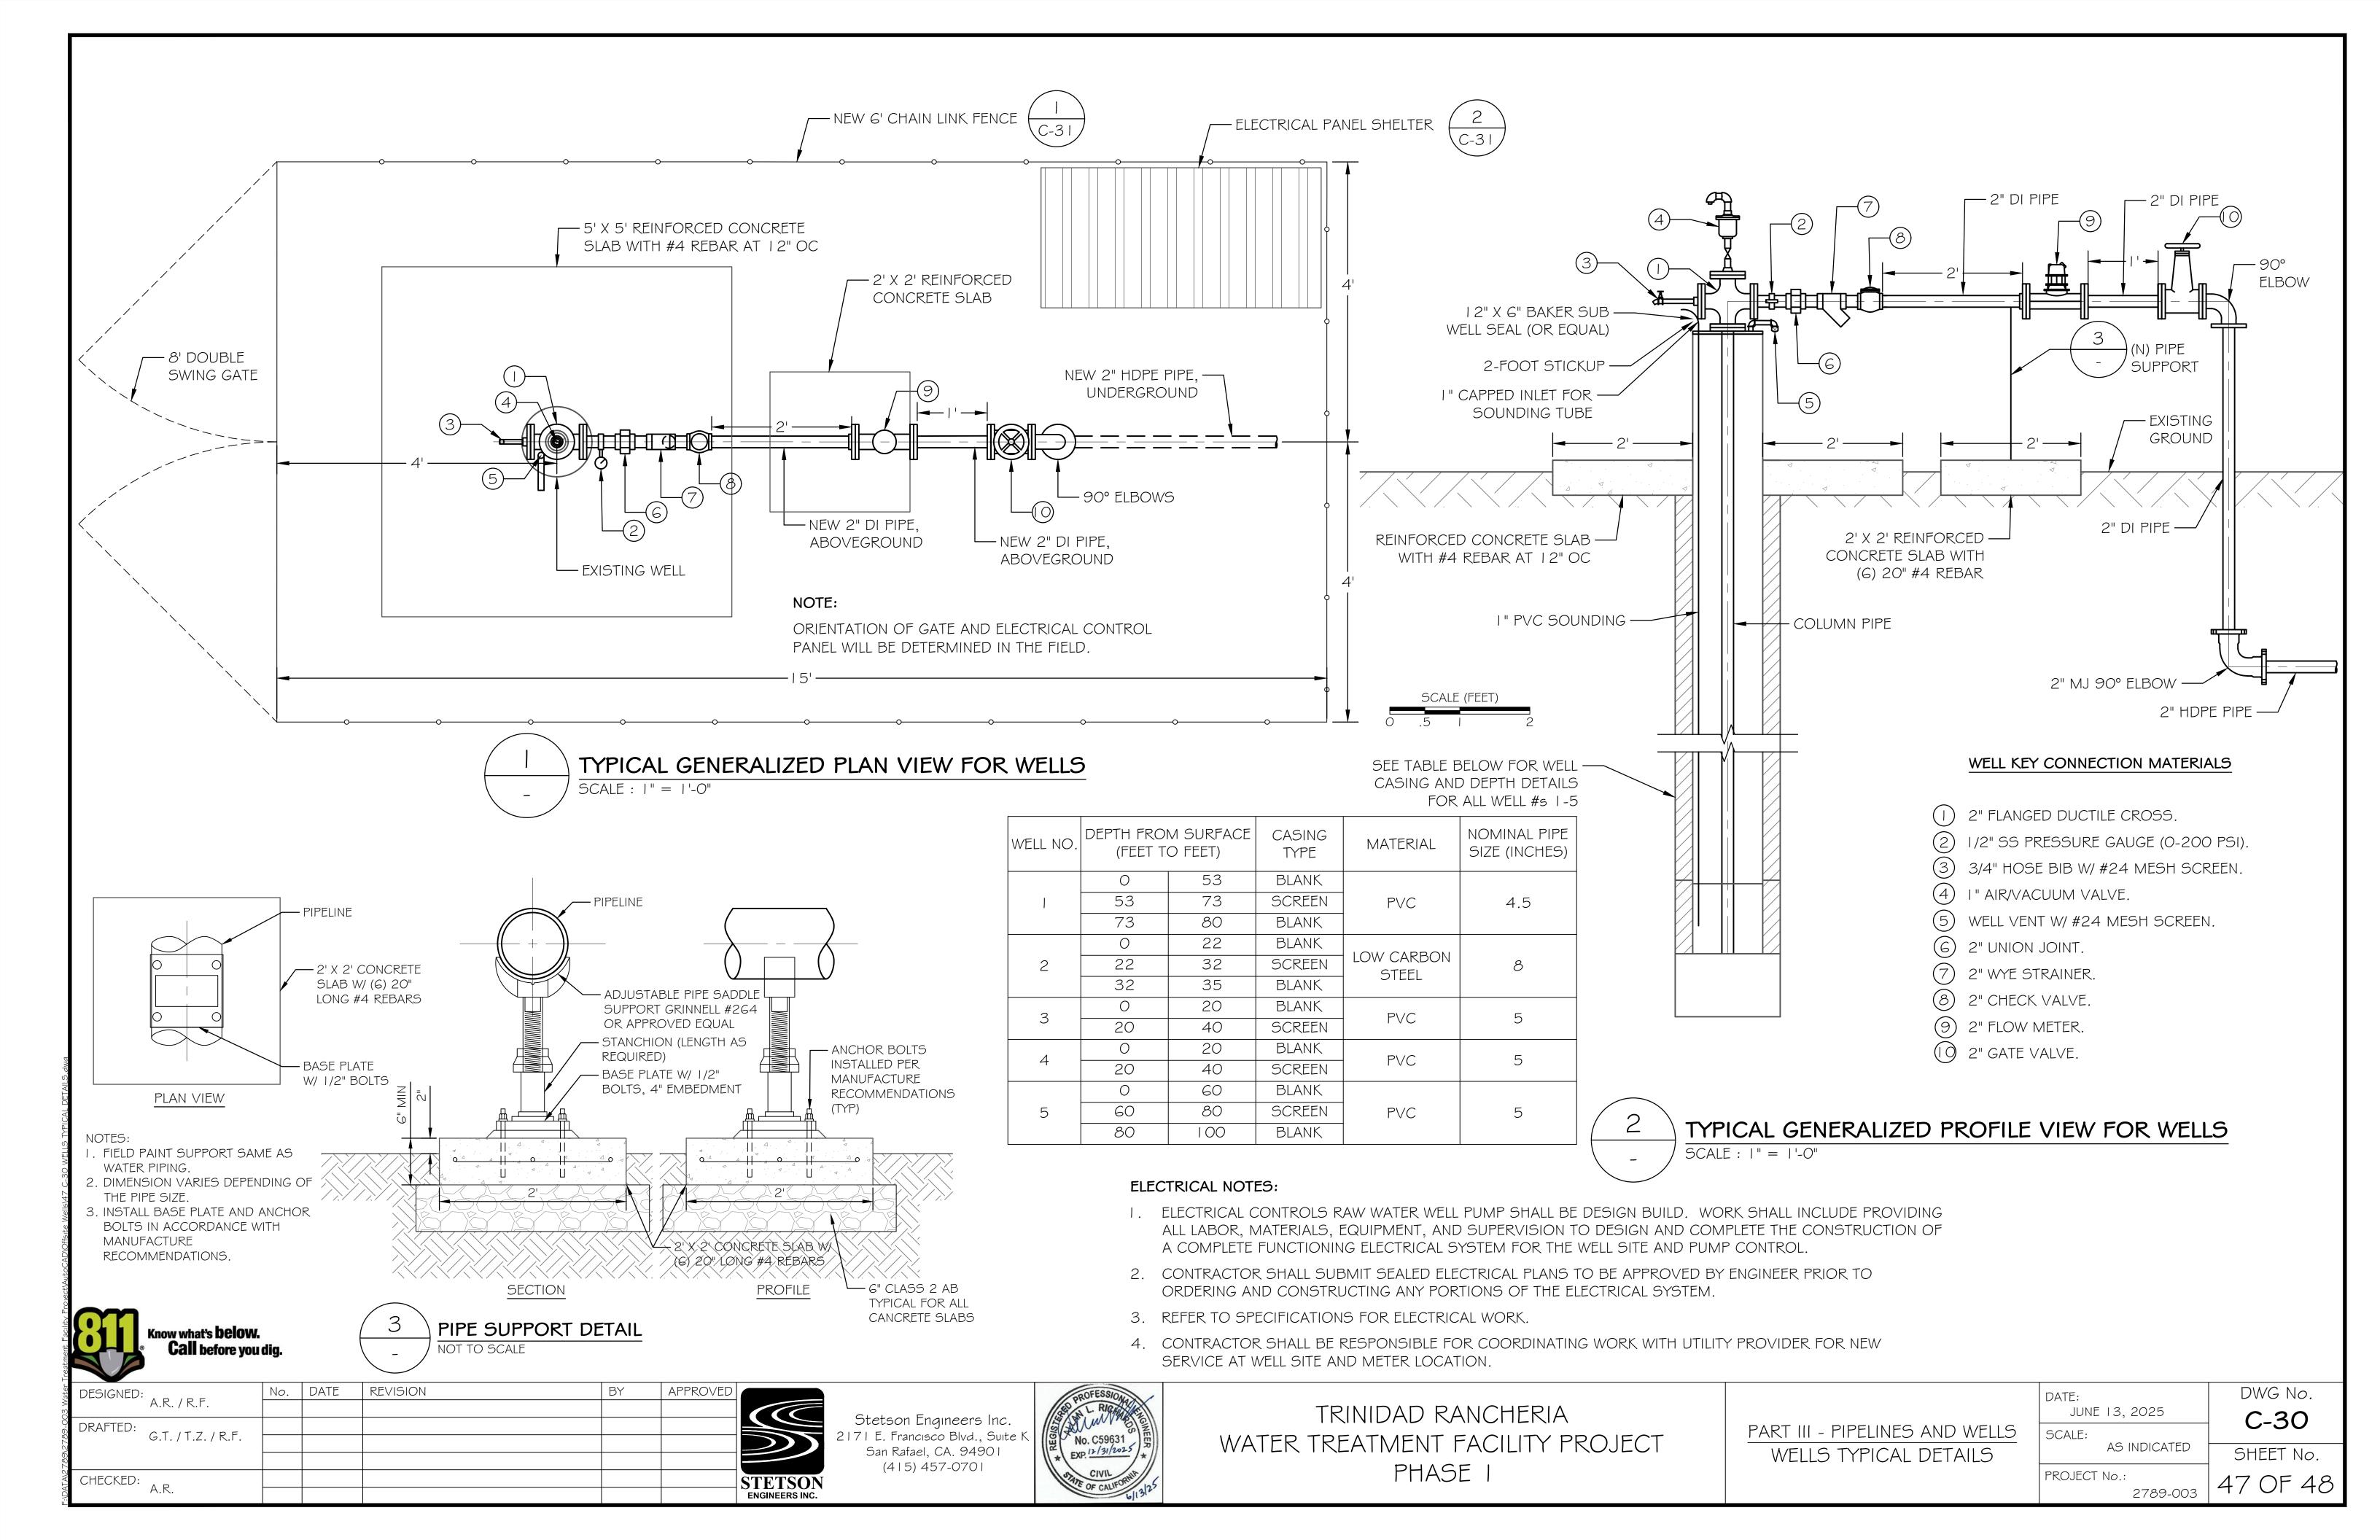


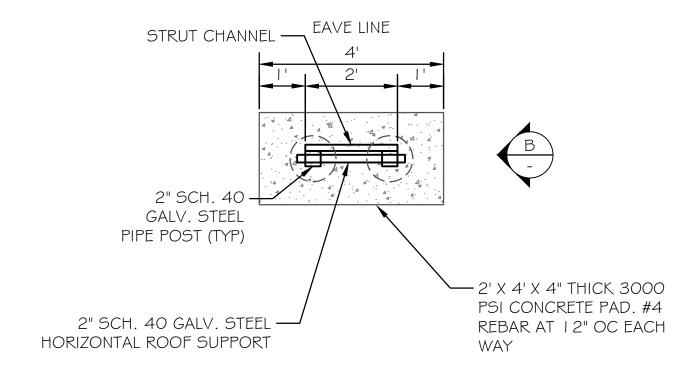


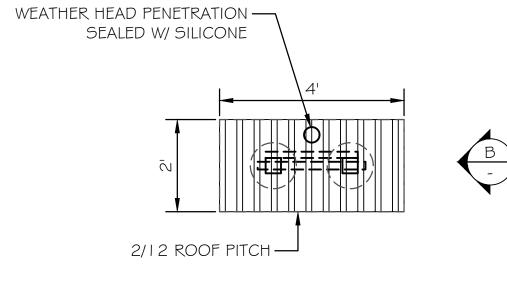



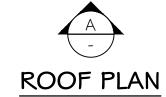

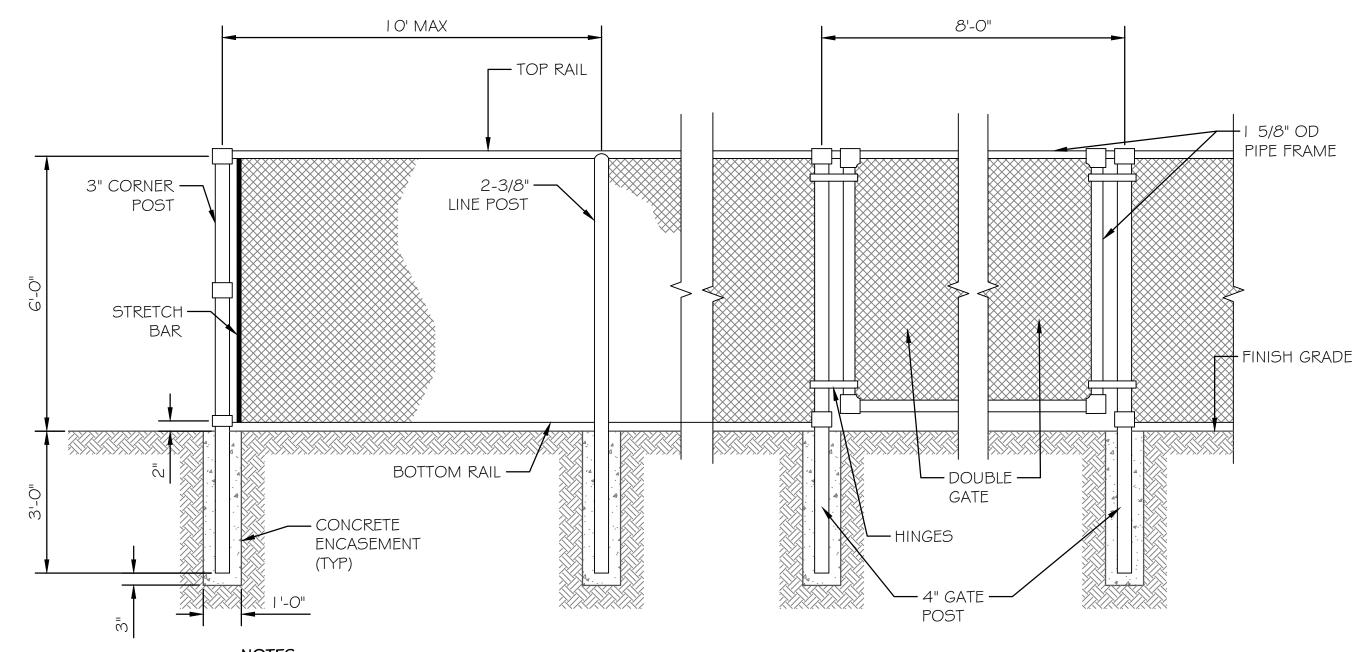

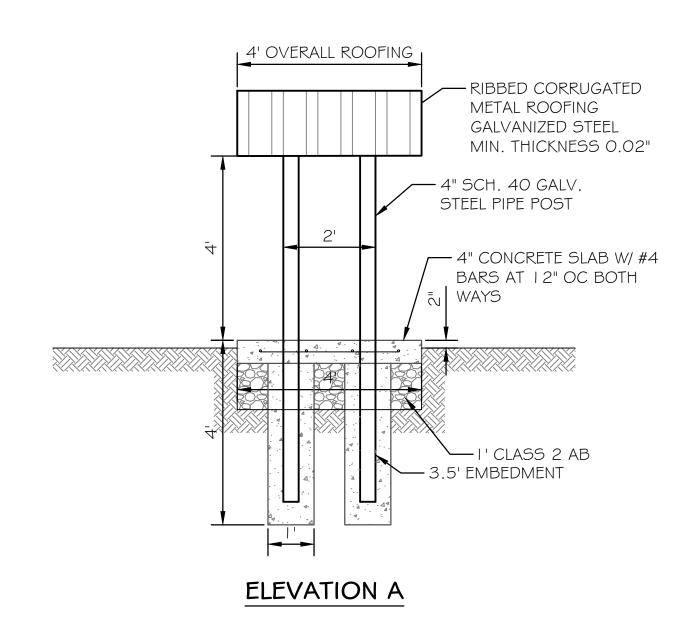

OVERALL 4" CONCRETE SLAB W/ #4 BARS AT 12" OC BOTH WAYS ELEVATION B

I. DOUBLE GATE SHALL HAVE A LOCKING MECHANISM, DROP ROD, AND TRUSS ROD.



ELECTRICAL PANEL SHELTER DETAIL C-30 NOT TO SCALE



DESIGNED:	, D [No.	DATE	REVISION	BY	APPROVED	
A.R.	/ R.F.						
DRAFTED:	, 1 , 1 , 1						
G.I.	/ T.Z. / R.F.						
CHECKED:							STET
A.R.							ENGINE

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TRINIDAD RANCHERIA WATER TREATMENT FACILITY PROJECT PHASE I

PHASE III - PIPELINES AND WELLS

WELLS TYPICAL DETAILS	
(CONTINUED)	

ATE: JUNE	13, 2025	
CALE:	AS INDICATED	_

PROJECT No.:

C-31 SHEET No.

DWG No.

48 OF 48 2789-003